RESOLUTION No. 24-223

A RESOLUTION OF THE MAYOR AND THE CITY COUNCIL OF THE CITY OF DORAL, FLORIDA, APPROVING THE SITE PLAN FOR MIA 102 AVE HOSPITALITY, FOR THE PROPERTY LOCATED AT 10234 NW 19 STREET, DORAL, FLORIDA, PURSUANT TO SECTION 53-184(F) OF THE CITY'S LAND DEVELOPMENT CODE; AND PROVIDING FOR AN EFFECTIVE DATE

WHEREAS, Chapter 53 "Administration", Article III. Development Procedures, Sec. 53-184(f) of the City's Land Development Code, establishes the site plan review and approval procedures for the Mayor and City Council to review and approve the site plan; and

WHEREAS, MIA 102nd Ave Hospitality (the "Applicant") is seeking site plan approval for the property located at 10234 NW 19 Street, further identified by the Miami-Dade County Property Appraiser by Folio No. 35-3032-034-0020 (the "Property"), as legally described in "Exhibit A" (the "Project"); and

WHEREAS, City staff finds that the proposed site plan, attached hereto as "Exhibit B," complies with the requirements and standards of the City's Land Development Code and Comprehensive Plan; and

WHEREAS, a zoning workshop was held on April 17, 2024, during which the public was afforded an opportunity to examine the Project and provide feedback; and

WHEREAS, the City Council reviewed the site plan application, the written and oral recommendations of the Planning and Zoning Department, including the recommended conditions, and hereby finds competent substantial evidence to find the site plan is in compliance with the City's Comprehensive Plan and Land Development Regulations, and that the site plan maintains the basic intent and purpose of the zoning, subdivision or other

land use regulations, which is to protect the general welfare of the public, and further finds that the site plan application should be granted.

NOW, THEREFORE, BE IT RESOLVED BY THE MAYOR AND THE CITY COUNCIL OF THE CITY OF DORAL, FLORIDA, AS FOLLOWS:

<u>Section 1.</u> Recitals. The foregoing recitals are confirmed, adopted, and incorporated herein and made as part hereof by this reference.

Section 2. Findings and Conclusions. Based upon an analysis of the site plan application and standards for approval of a site plan under the City's Land Development Regulations, the City Council hereby finds and concludes that the Applicant's request for site plan, as more particularly set forth in "Exhibit B," is in compliance with the Comprehensive Plan and the Land Development Regulations of the City, and there is substantial competent evidence to support approval of the Application.

Section 3. Approval. The Mayor and City Council hereby approve the site plan for Hyatt House, for the property located at 10234 NW 19 Street, further identified by folio number 35-3032-034-0020, as legally described in "Exhibit A." The proposed site plan comprises of a 6-story hotel with 124 hotel rooms featuring amenities such as a pool, breakfast buffet, lounge, and fitness center, including retail space with a restaurant and a pub. A copy of the site plan is provided in "Exhibit B." The approval of the site plan is subject to the following conditions:

1. The Project shall be built in substantial compliance with the plans entitled "Hyatt House," prepared by RBA, dated stamped received February 21, 2024.

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- 2. The Project shall be landscaped in accordance with the landscape plan, signed by Michael J. Phillips, LA, dated stamped received February 21, 2024, as amended, and included with the site plan submittal.
- 3. The Applicant shall comply with Ordinance No. 2015-09 "Public Arts Program," as amended, at the time of building permit (if applicable).
- 4. The Applicant shall comply with Chapter 63, "Green Building Incentives," of the City's Land Development Code at the time of building permit (if applicable).
- 5. The Applicant shall comply with the City's Floodplain Management regulations (Chapter 23, Article II, Floodplain Management) of the City's Code.
- 6. The Applicant shall provide the Building Department a certified drainage inspection report prior to the issuance of a certificate of occupancy.
- 7. The property owner shall maintain the landscaping within the public rightsof-way adjacent to the property. Maintenance includes trees, plants, sod, and other landscape material.
- 8. The Applicant shall submit a Stormwater Pollution Prevention Plan (SWPPP) at time of building permit. The Plan should provide guidelines for implementing an erosion and sedimentation control program before the site is cleared or graded, including areas where topsoil will be removed, and contours of slopes will be cleared. The Plan shall also include location and type of erosion control measures, storm water and sediment management systems, and a vegetative plan for temporary and permanent stabilization. The Plan shall remain on-site for the duration of the construction activity.
- 9. If more than one (1) acre of land is disturbed during construction the Contractor/Developer is responsible to obtain NPDES Stormwater permit coverage through the Florida Department of Environmental Protection (FDEP), Construction Generic Permit (CGP). If the project is less than one (1) acre, but part of a larger common plan of development or sale that will ultimately disturb one or more acres, permit coverage is also required. Instruction to request and obtain a CGP can be found at: http://www.dep.state.fl.us/water/stormwater/npdes/docs/cgp.pdf. Contractor/Developer should submit the Notice of Intent (NOI) with the appropriate processing fees to the NPDES Stormwater Notices Center. Contractor/Developer must apply for permit coverage at least two (2) days before construction begins.
- 10. Construction shall be permitted only during the hours set forth in Ordinance No. 2011-01 "Noise Ordinance."

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- 11. The Applicant shall comply with all applicable conditions and requirements of the Miami-Dade County Department of Regulatory and Economic Resources.
- 12. The Applicant shall comply with all applicable conditions and requirements of the Miami-Dade County Fire Rescue Department.
- 13. All applicable local, state and federal permits must be obtained before commencement of the development.
- 14. Issuance of this development permit by the City of Doral does not in any way create any right on the part of an Applicant to obtain a permit from a state or federal agency and does not create any liability on the part of the City of Doral for issuance of the permit if the applicant fails to obtain requisite approvals or fulfill the obligations imposed by a state or federal agency or undertakes actions that result in a violation of state or federal law.

<u>Section 4.</u> <u>Effective Date.</u> This Resolution shall become effective immediately upon its adoption.

The foregoing Resolution was offered by Vice Mayor Puig-Corve who moved its adoption.

The motion was seconded by Councilmember Pineyro and upon being put to a vote, the vote was as follows:

Mayor Christi Fraga	Yes
Vice Mayor Oscar Puig-Corve	Yes
Councilwoman Digna Cabral	Yes
Councilman Rafael Pineyro	Yes
Councilwoman Maureen Porras	Yes

PASSED AND ADOPTED this 11 day of September, 2024.

CHRISTI FRAĞA, MAYOR

ATTEST:

CONNIE DIAZ, MMC

CITY CLERK

APPROVED AS TO FORM AND LEGAL SUFFICIENCY FOR THE USE AND RELIANCE OF THE CITY OF DORAL ONLY:

LORENZO COBIELLA

GASTESI, LOPEZ & MESTRE, PLLC

CITY ATTORNEY

EXHIBIT "A"

Legal Description – Proposed Hyatt House

TRACT 'B', "GREAT SPRINGS AT I.C.P.", ACCORDING TO THE PLAT THEREOF, AS RECORDED IN PLAT BOOK 158, PG. 94, OF THE PUBLIC RECORDS OF MIAMI/DADE COUNTY, FLORIDA. SECTION 32, TOWNSHIP 53 SOUTH, RANGE 40 EAST, LESS THE WEST 267.34 FEET THEREOF.

EXHIBIT "B"

SITE & BUILDING DATA TABLE RECEIVED 56951.33 SF SITE AREA LOT FRONTAGE WIDTH: 119'-5"
BUILDING SETBACK: FRONT 20'-0", SIDES AND REAR 15'-0" By Stephanie Puglia at 9:55 am, Feb 21, 2024 GROUND FLOOR GROSS AREA 14614.31 SF BUILDLING COVERAGE: 25.6% (ALLOWED 50%) OPEN SPACE 8943.89 SF FIRST FLOOR: .25 (ALLOWED 0.5 MAX) TYPICAL FLOOR: .25 (ALLOWED 0.25 MAX) BUILDING GROSS AREA LEVEL AREA BUILDILNG: 6-STORY, 124 ROOMS BUILDING HEIGHT: ALLOWED 80'-0" PROVIDED 78'-7" 14509.89 SF 14949.14 SF REQUIRED 15% MIN. (8543 SF) PROVIDED 15.7% (8637 SF) OPEN SPACE: 14949.14 SF Level 04 14949.14 SF LANDSCAPE 14949.14 SF REQUIREMENTS: (SEE LANDSCAPE DWGS) 14949.14 SF PARKING REQUIREMENTS:
1 PER FIRST (40) GUESTROOMS = 40 SPACES 89255.59 SF 1 PER ADDITIONAL (2) = 42 SPACES 1 PER (4) EMPLOYEES = 3 SPACES TOTAL REQUIRED = 85 SPACES PROVIDED FOR 124 ROOMS = 81 SPACES NM 105ND VAENAE AW 102ND AVENUE ELECTRICAL VAULT-FPL SWITCH CABINET-FPL SWITCH CABINET <u>OPEN SPACE</u> /5721/7/SF/ FPL EASEMENT— PROPOSED TRANSFORMER— -BUILDING SETBACK ---FPL EASEMENT —BUILDING SETBACK -SIGHT TRIANGLE 194' - 8 1/2" OPEN SPACE OPEN SPACE OPEN SPACE 168.41 SF 679.66 SF 307.54 SE OPEN SPACE 89.25 SF OPEN SPACE 693.96 SF HYATT HOUSE DORAL DORAL, FL GROUND FLOOR GROSS BAYWOOD HOTELS OPEN SPACE 3785 NW 82 AVE 250.88 SF DORAL, FL 33166 OPEN SPACE OPEN SPACE OPEN SPACE OPEN SPACE 138,98 SF 69.03 SF 585.67/SF/ 238.8 SF DESIGN DEVELOPMENT PROPERTY LINE -LEASE LINE ISSUE DATE: 02/14/2024 **CURRENT REVISION** Description EXISTING RESIDENCE INN BY MARRIOTT 0 0 PROJECT NUMBER:23-2232 SITE REGULATORY STREE SHEET 0 0 CV1.00 1 Gross Site Areas Plan CV1.00 1/16" = 1'-0" 2/15/2024 5:43:24 PM


122-B W. BLAND ST. CHARLOTTE, NC 28203 704.344.9098










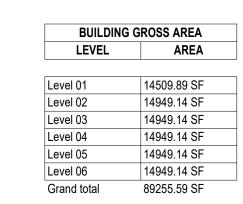



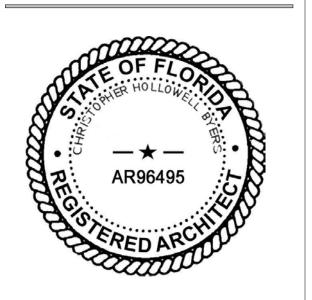




HYATT HOUSE DORAL DORAL, FL

BAYWOOD HOTELS 3785 NW 82 AVE DORAL, FL 33166

DESIGN DEVELOPMENT

ISSUE DATE: 02/14/2024

CURRENT REVISION

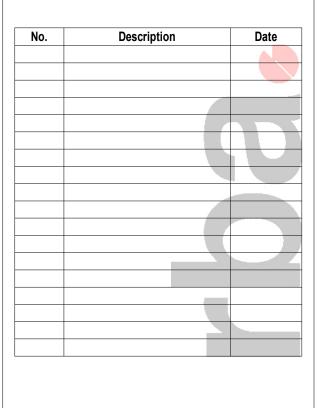



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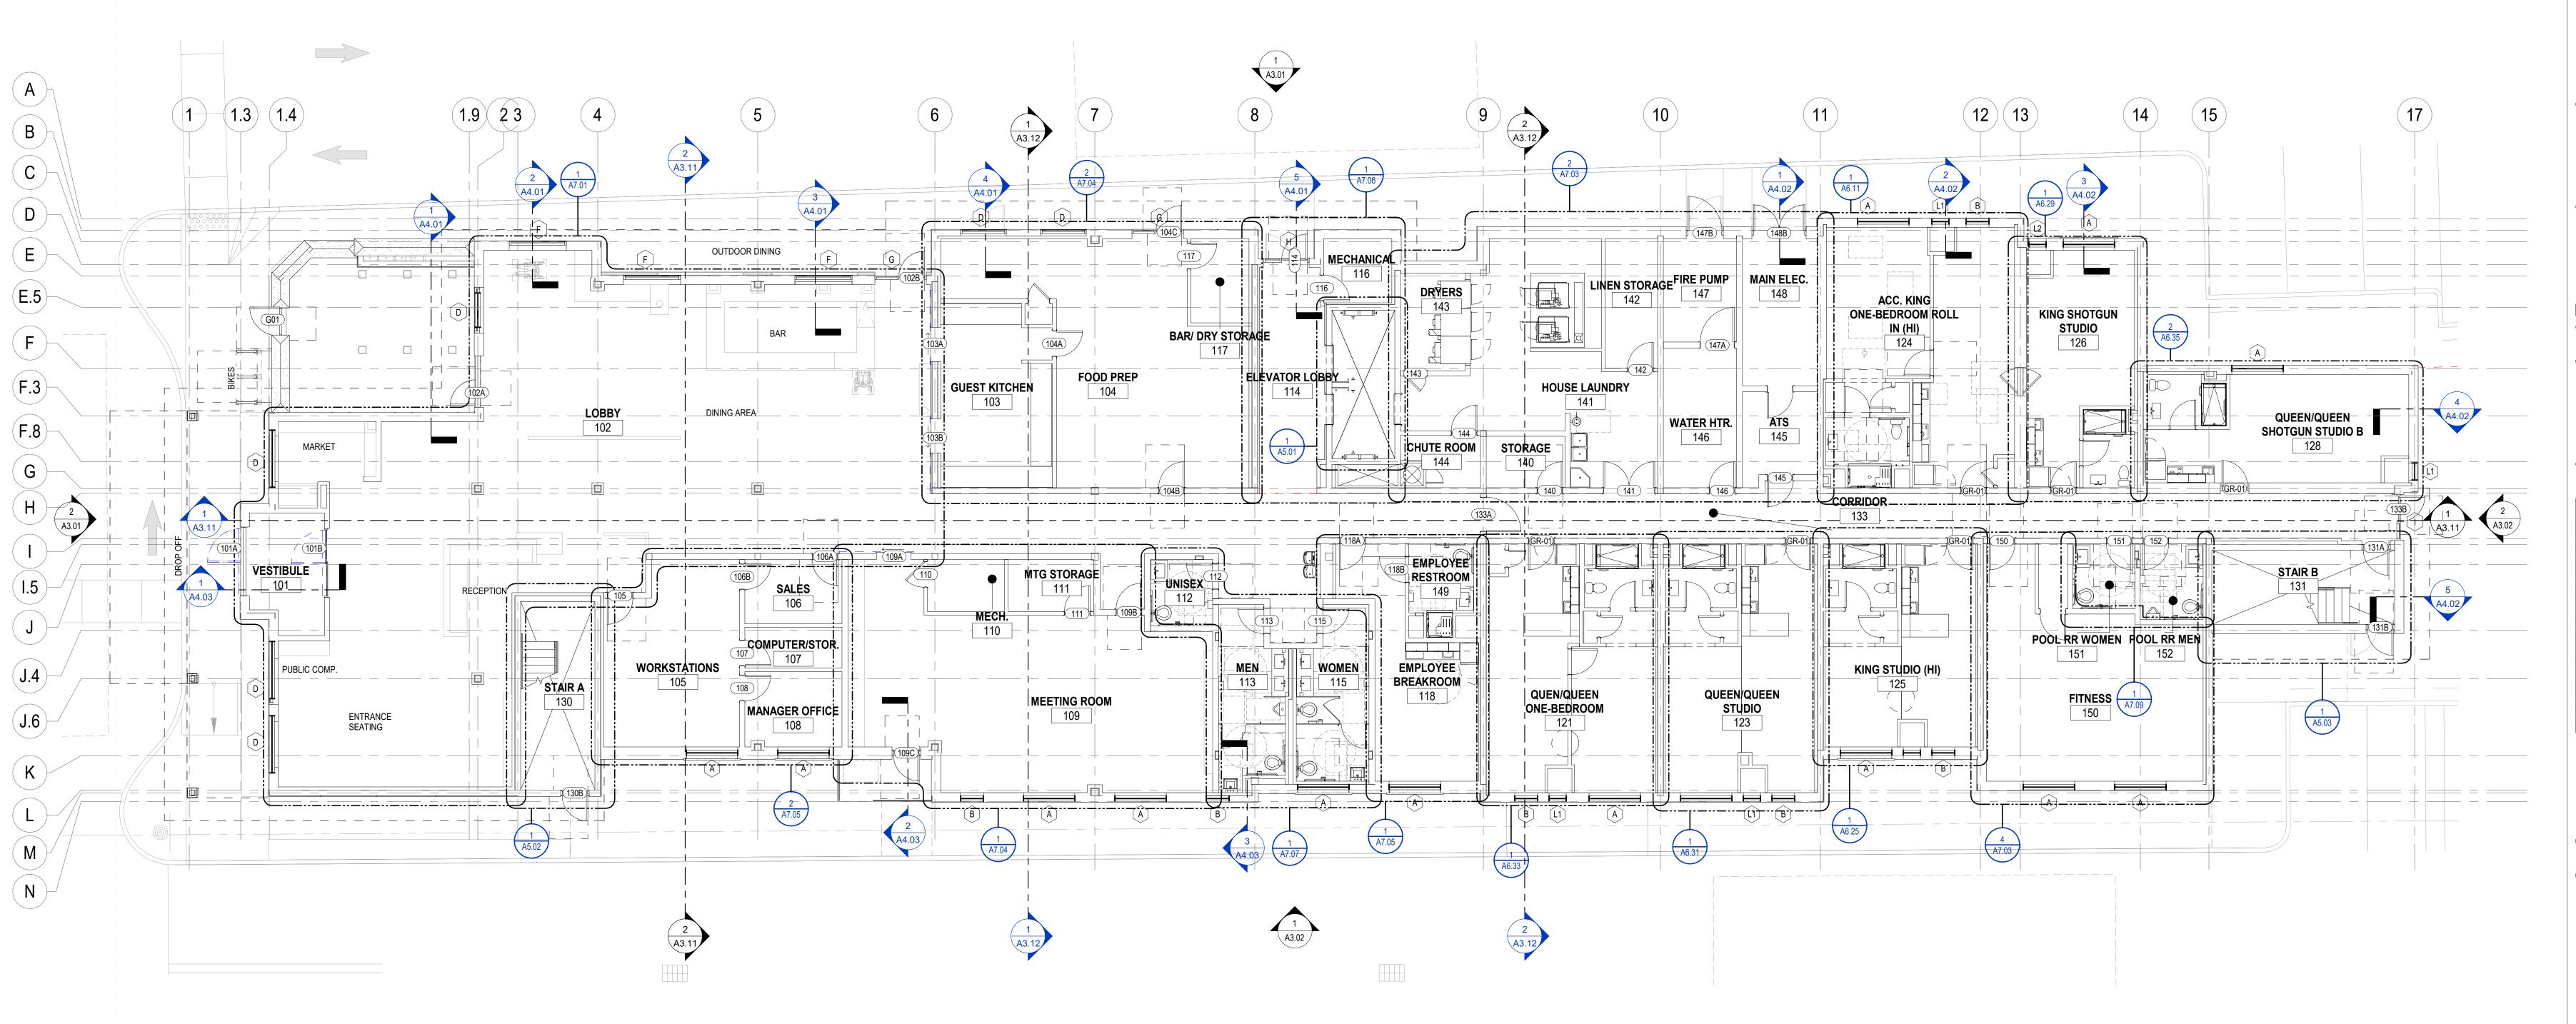
ARCHITECTURAL SITE PLAN

A2.00

2/15/2024 5:11:54 PM



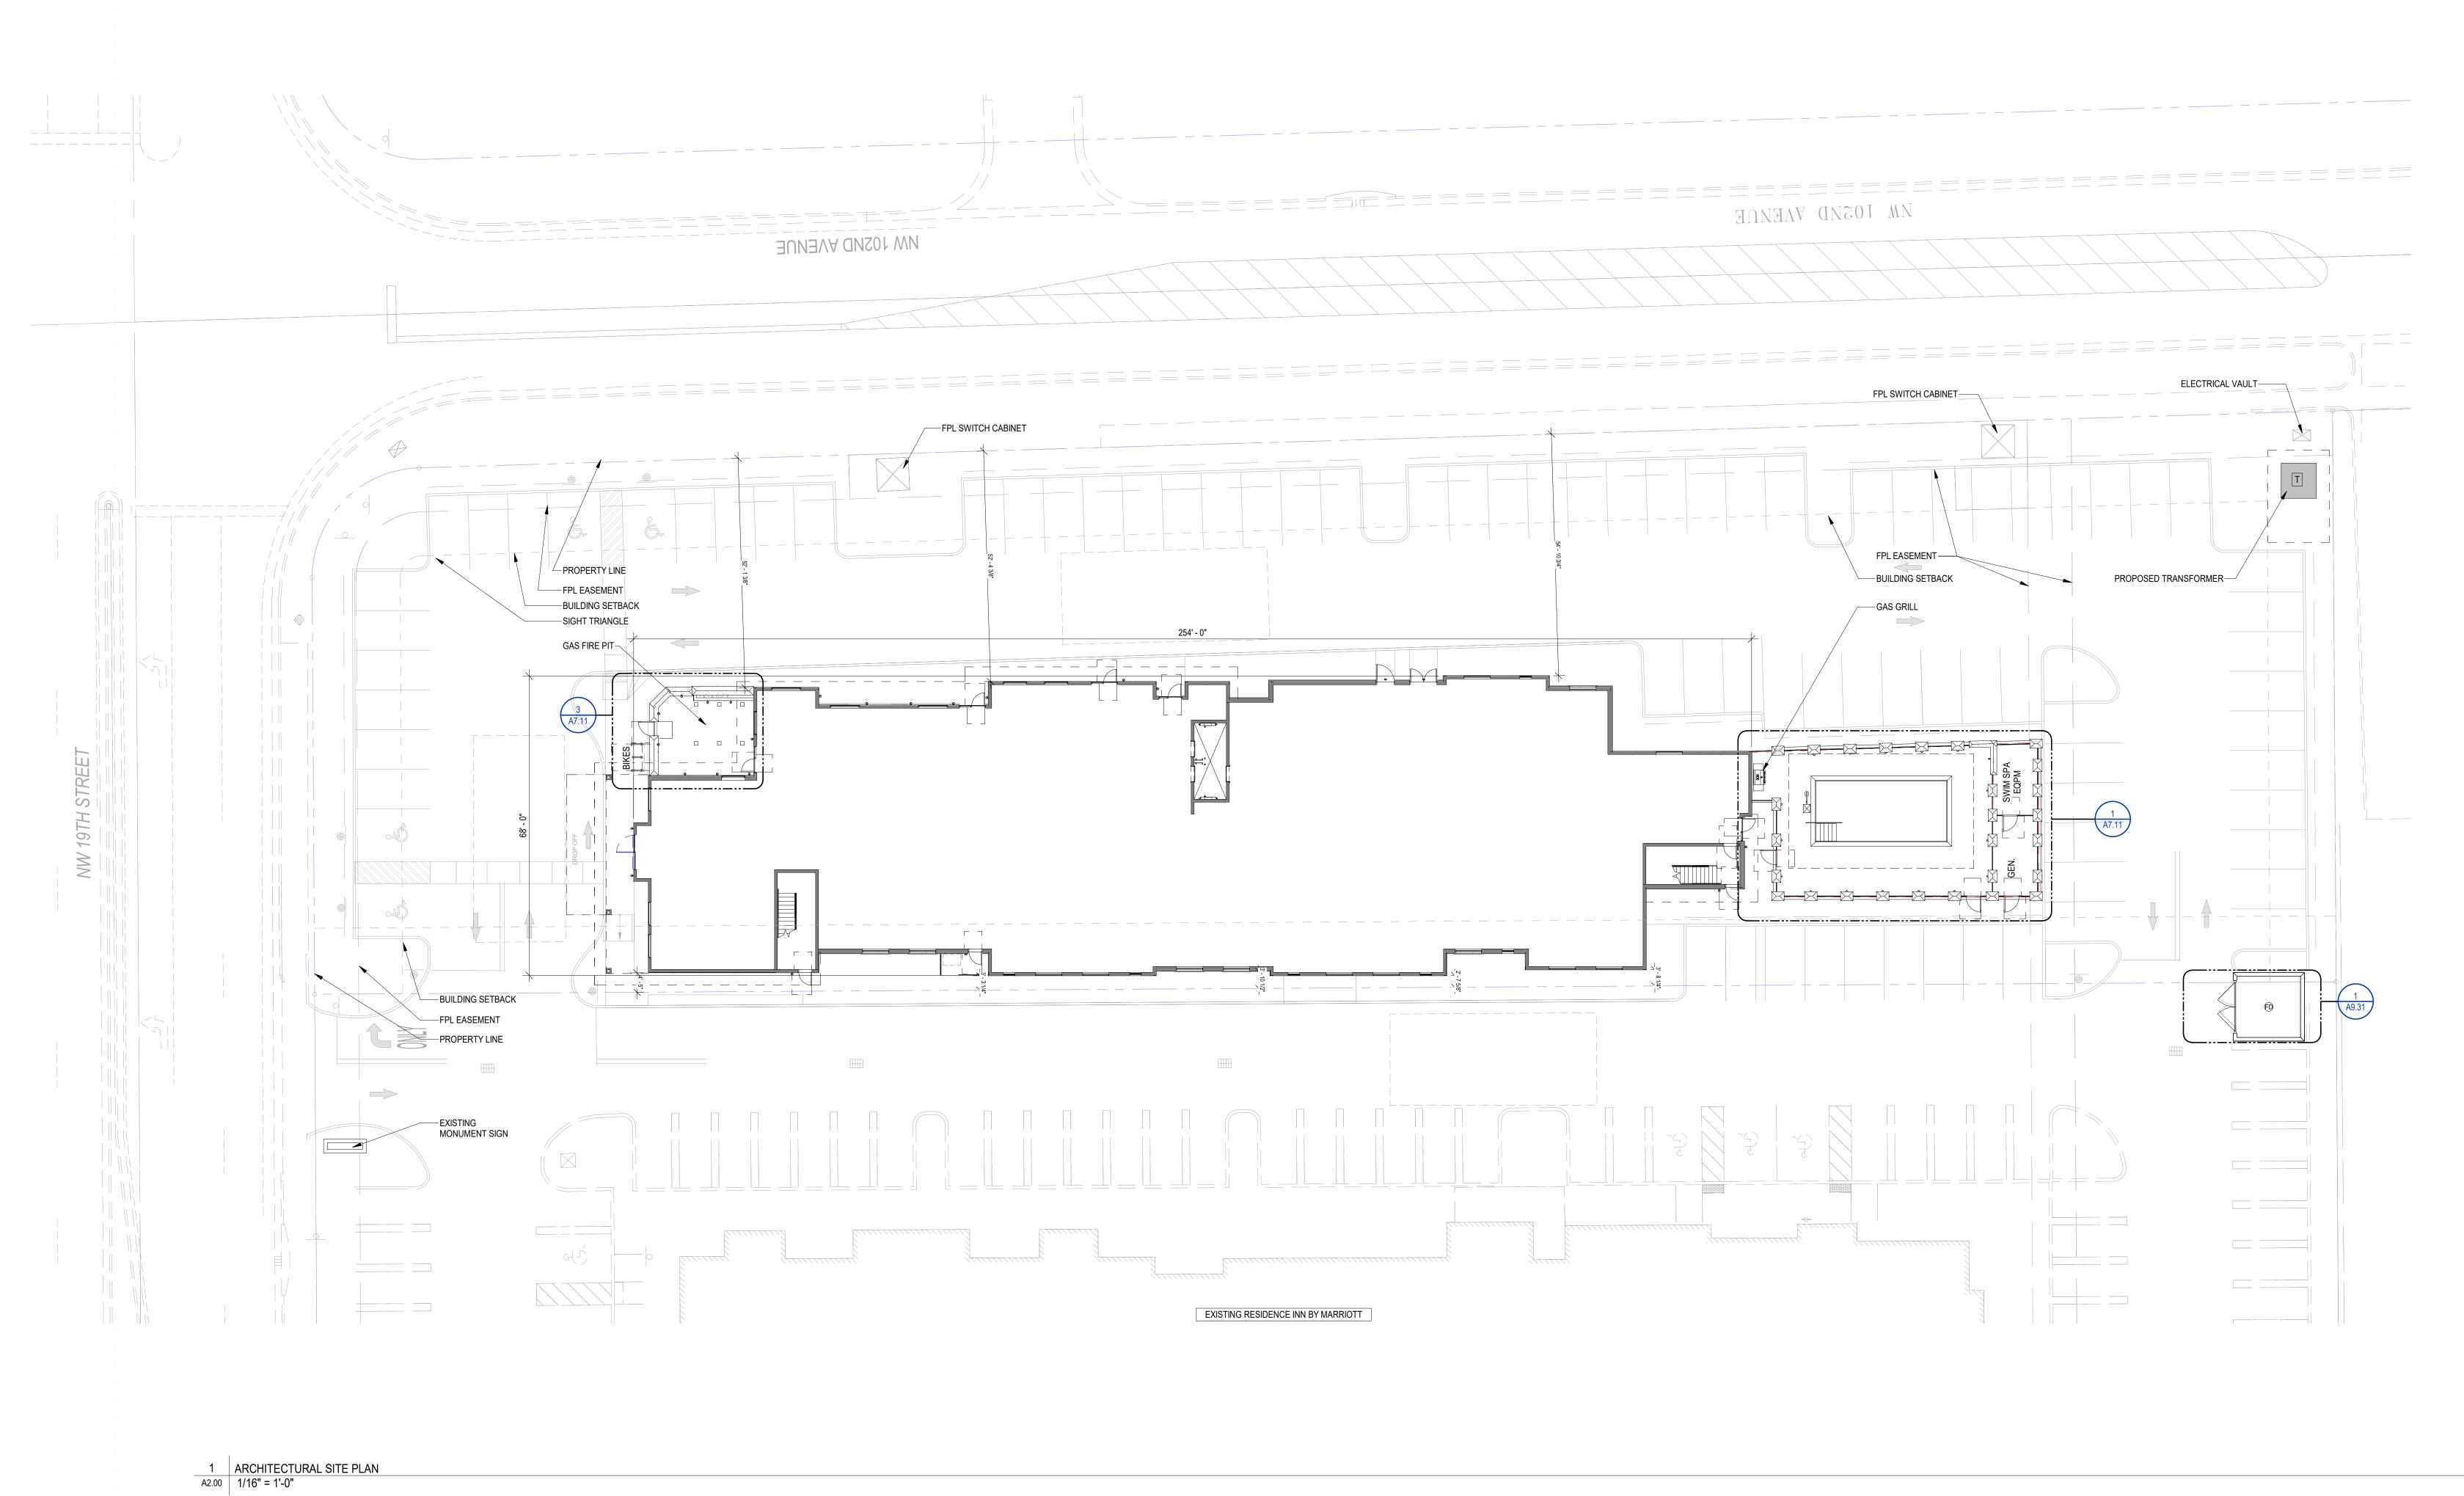

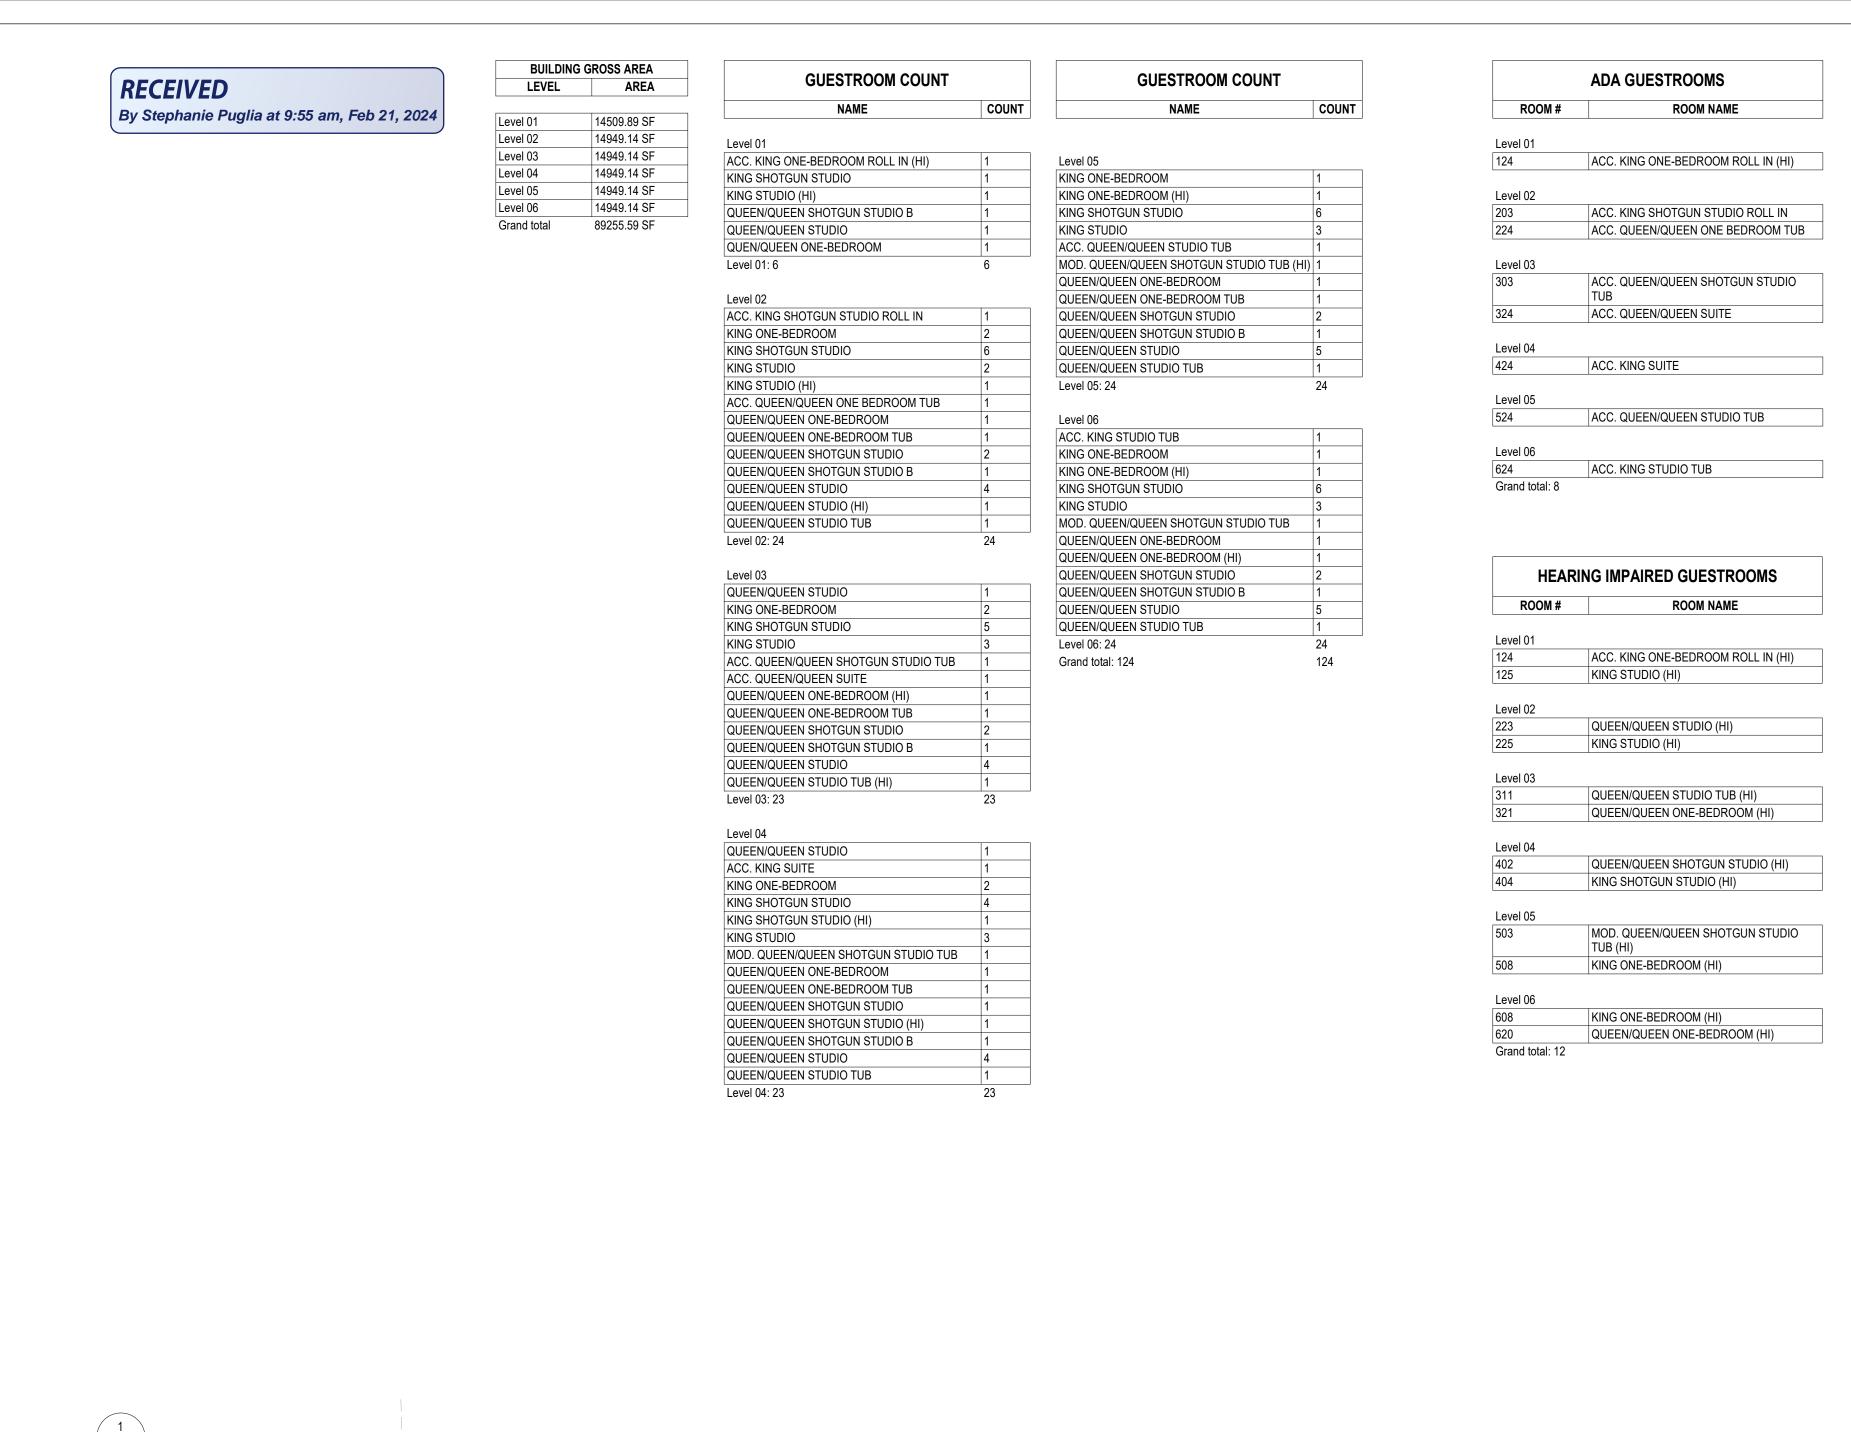

1 LEVEL 01 FLOOR PLAN
A2.01 1/8" = 1'-0"

122-B W. BLAND ST. CHARLOTTE, NC 28203 704.344.9098






HYATT HOUSE DORAL DORAL, FL

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DESIGN DEVELOPMENT

ISSUE DATE: 02/14/2024


CURRENT REVISION

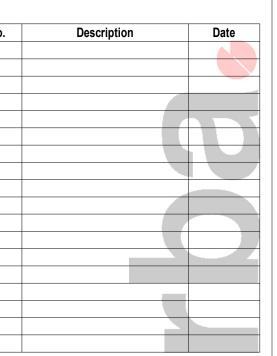

PROJECT NUMBER:23-2232
LEVEL 01 FLOOR PLAN

A2.01

2/15/2024 5:12:00 PM

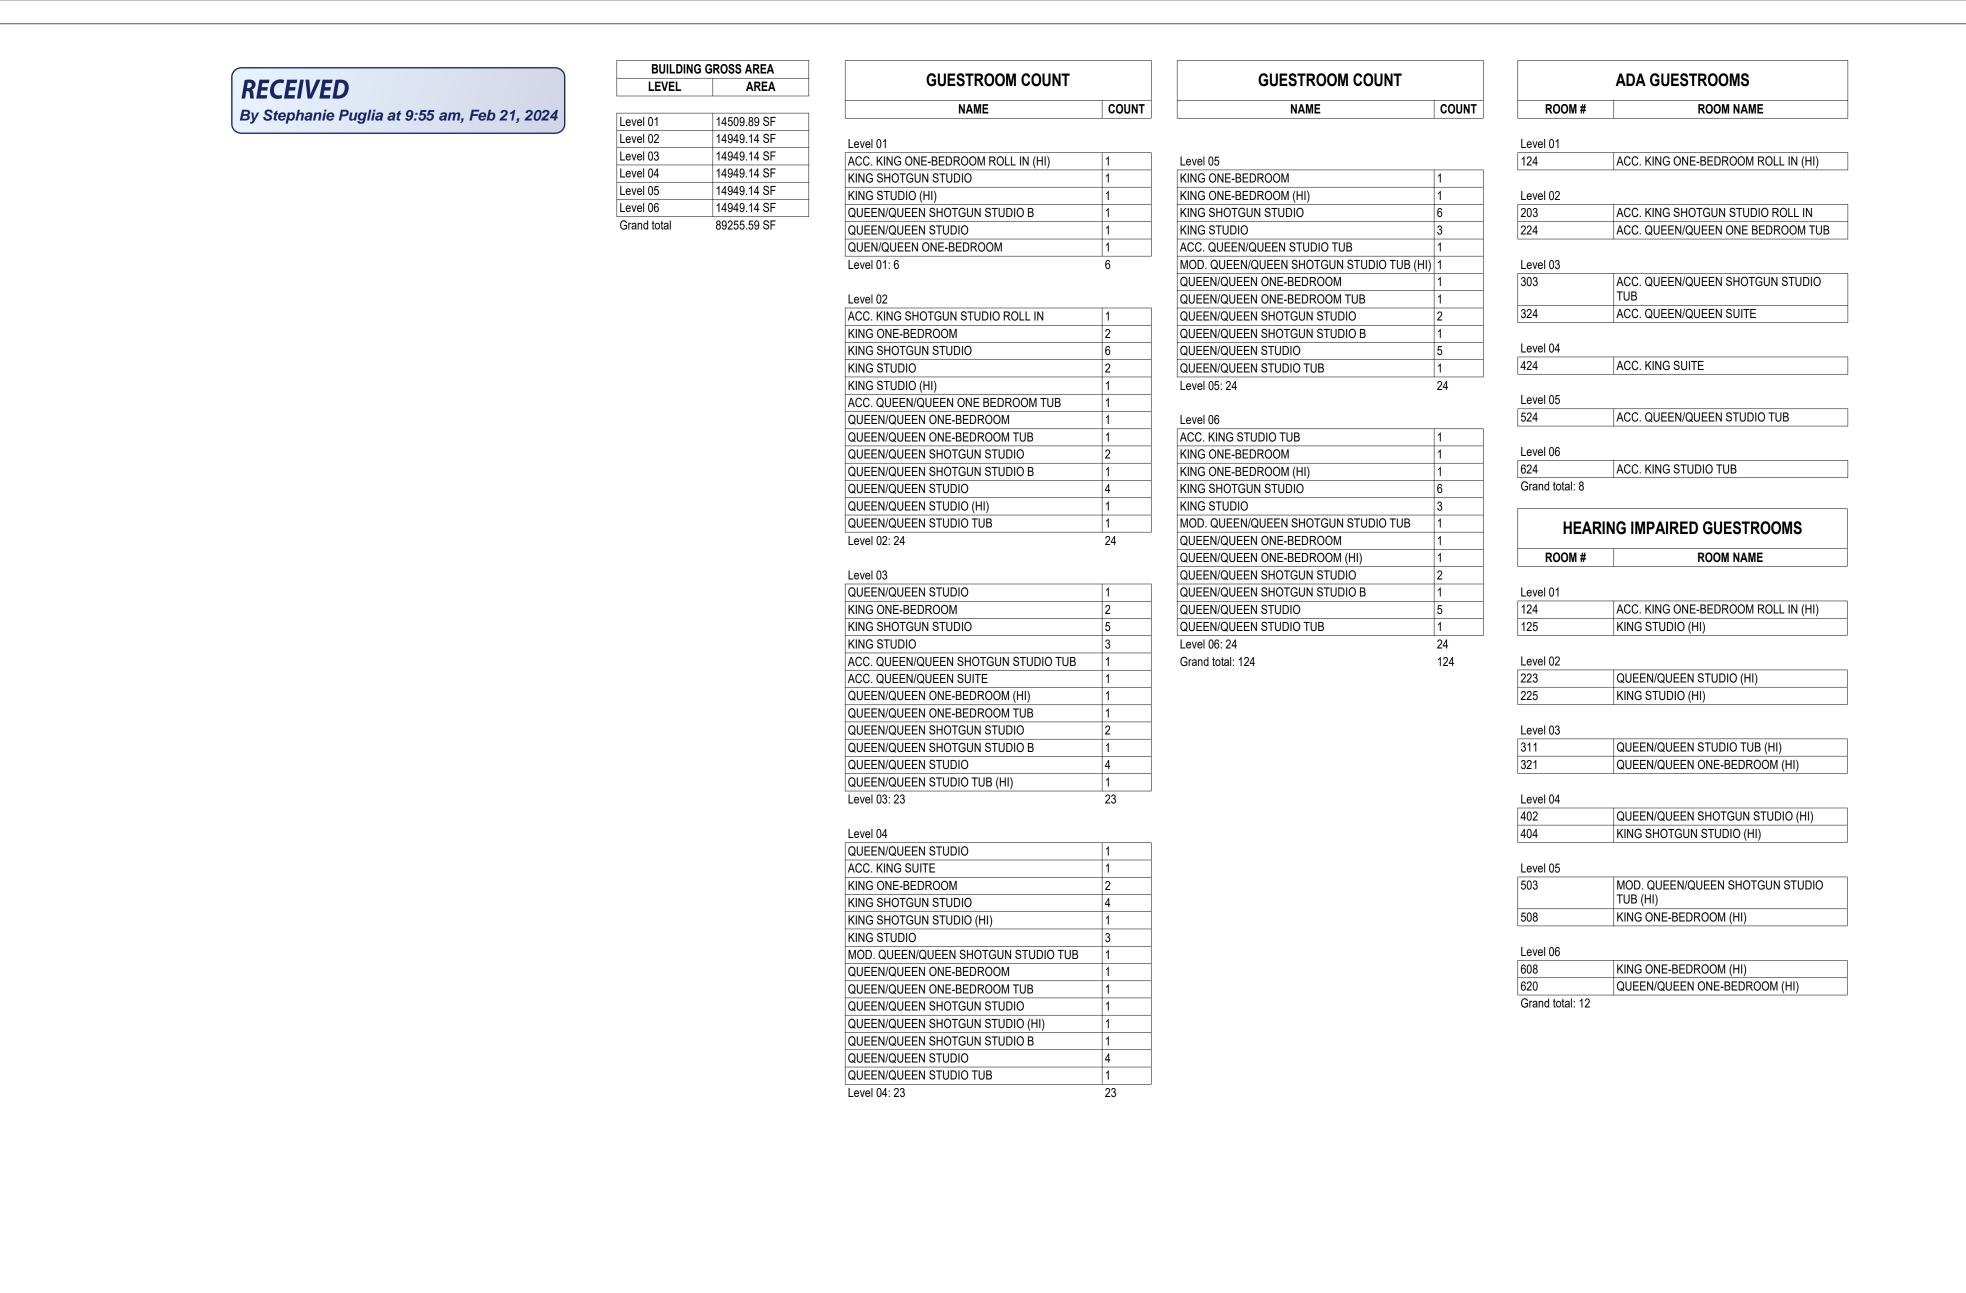

ACC. QUEEN/QUEEN ONE BEDROOM TUB

224

KING STUDIO (HI)

A L2 B

KING SHOTGUN

STUDIO

KING SHOTGUN

STUDIO 227

KING SHOTGUN STUDIO 229

QUEEN/QUEEN SHOTGUN STUDIO B

QUEEN/QUEEN STUDIO

222

QUEEN/QUEEN STUDIO (HI) 223

A L1 B

A3.01

QUEEN/QUEEN

STUDIO 212

QUEEN/QUEEN STUDIO TUB

211

(8.3)(8.5)(8.6)

MAINTENANCE 216

KING SHOTGUN

STUDIO 213

ELECTRICAL

KING SHOTGUN STUDIO 219


QUEEN/QUEEN

ONE-BEDROOM TUB

QUEEN/QUEEN

ONE-BEDROOM



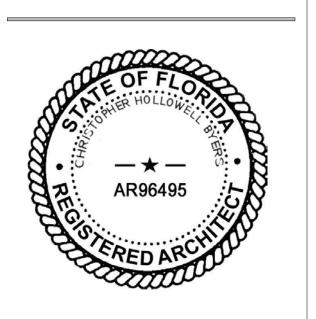



HYATT HOUSE DORAL DORAL, FL

BAYWOOD HOTELS 3785 NW 82 AVE DORAL, FL 33166

DESIGN DEVELOPMENT

ISSUE DATE: 02/14/2024

CURRENT REVISION



PROJECT NUMBER:23-2232 LEVEL 02 FLOOR PLAN

A2.02

2/15/2024 5:12:05 PM

1 LEVEL 02 FLOOR PLAN
A2.02 1/8" = 1'-0"

1.3 (1.4)

ACC. KING SHOTGUN STUDIO ROLL IN

QUEEN/QUEEN SHOTGUN STUDIO

QUEEN/QUEEN

SHOTGUN STUDIO

(E.5)

(F.3)

(F.8)

G

J.4

J.6

1.9 23

KING SHOTGUN

STUDIO 204

KING STUDIO

KING STUDIO

KING ONE-BEDROOM


KING ONE-BEDROOM


QUEEN/QUEEN

STUDIO 210

QUEEN/QUEEN STUDIO

209

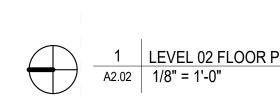

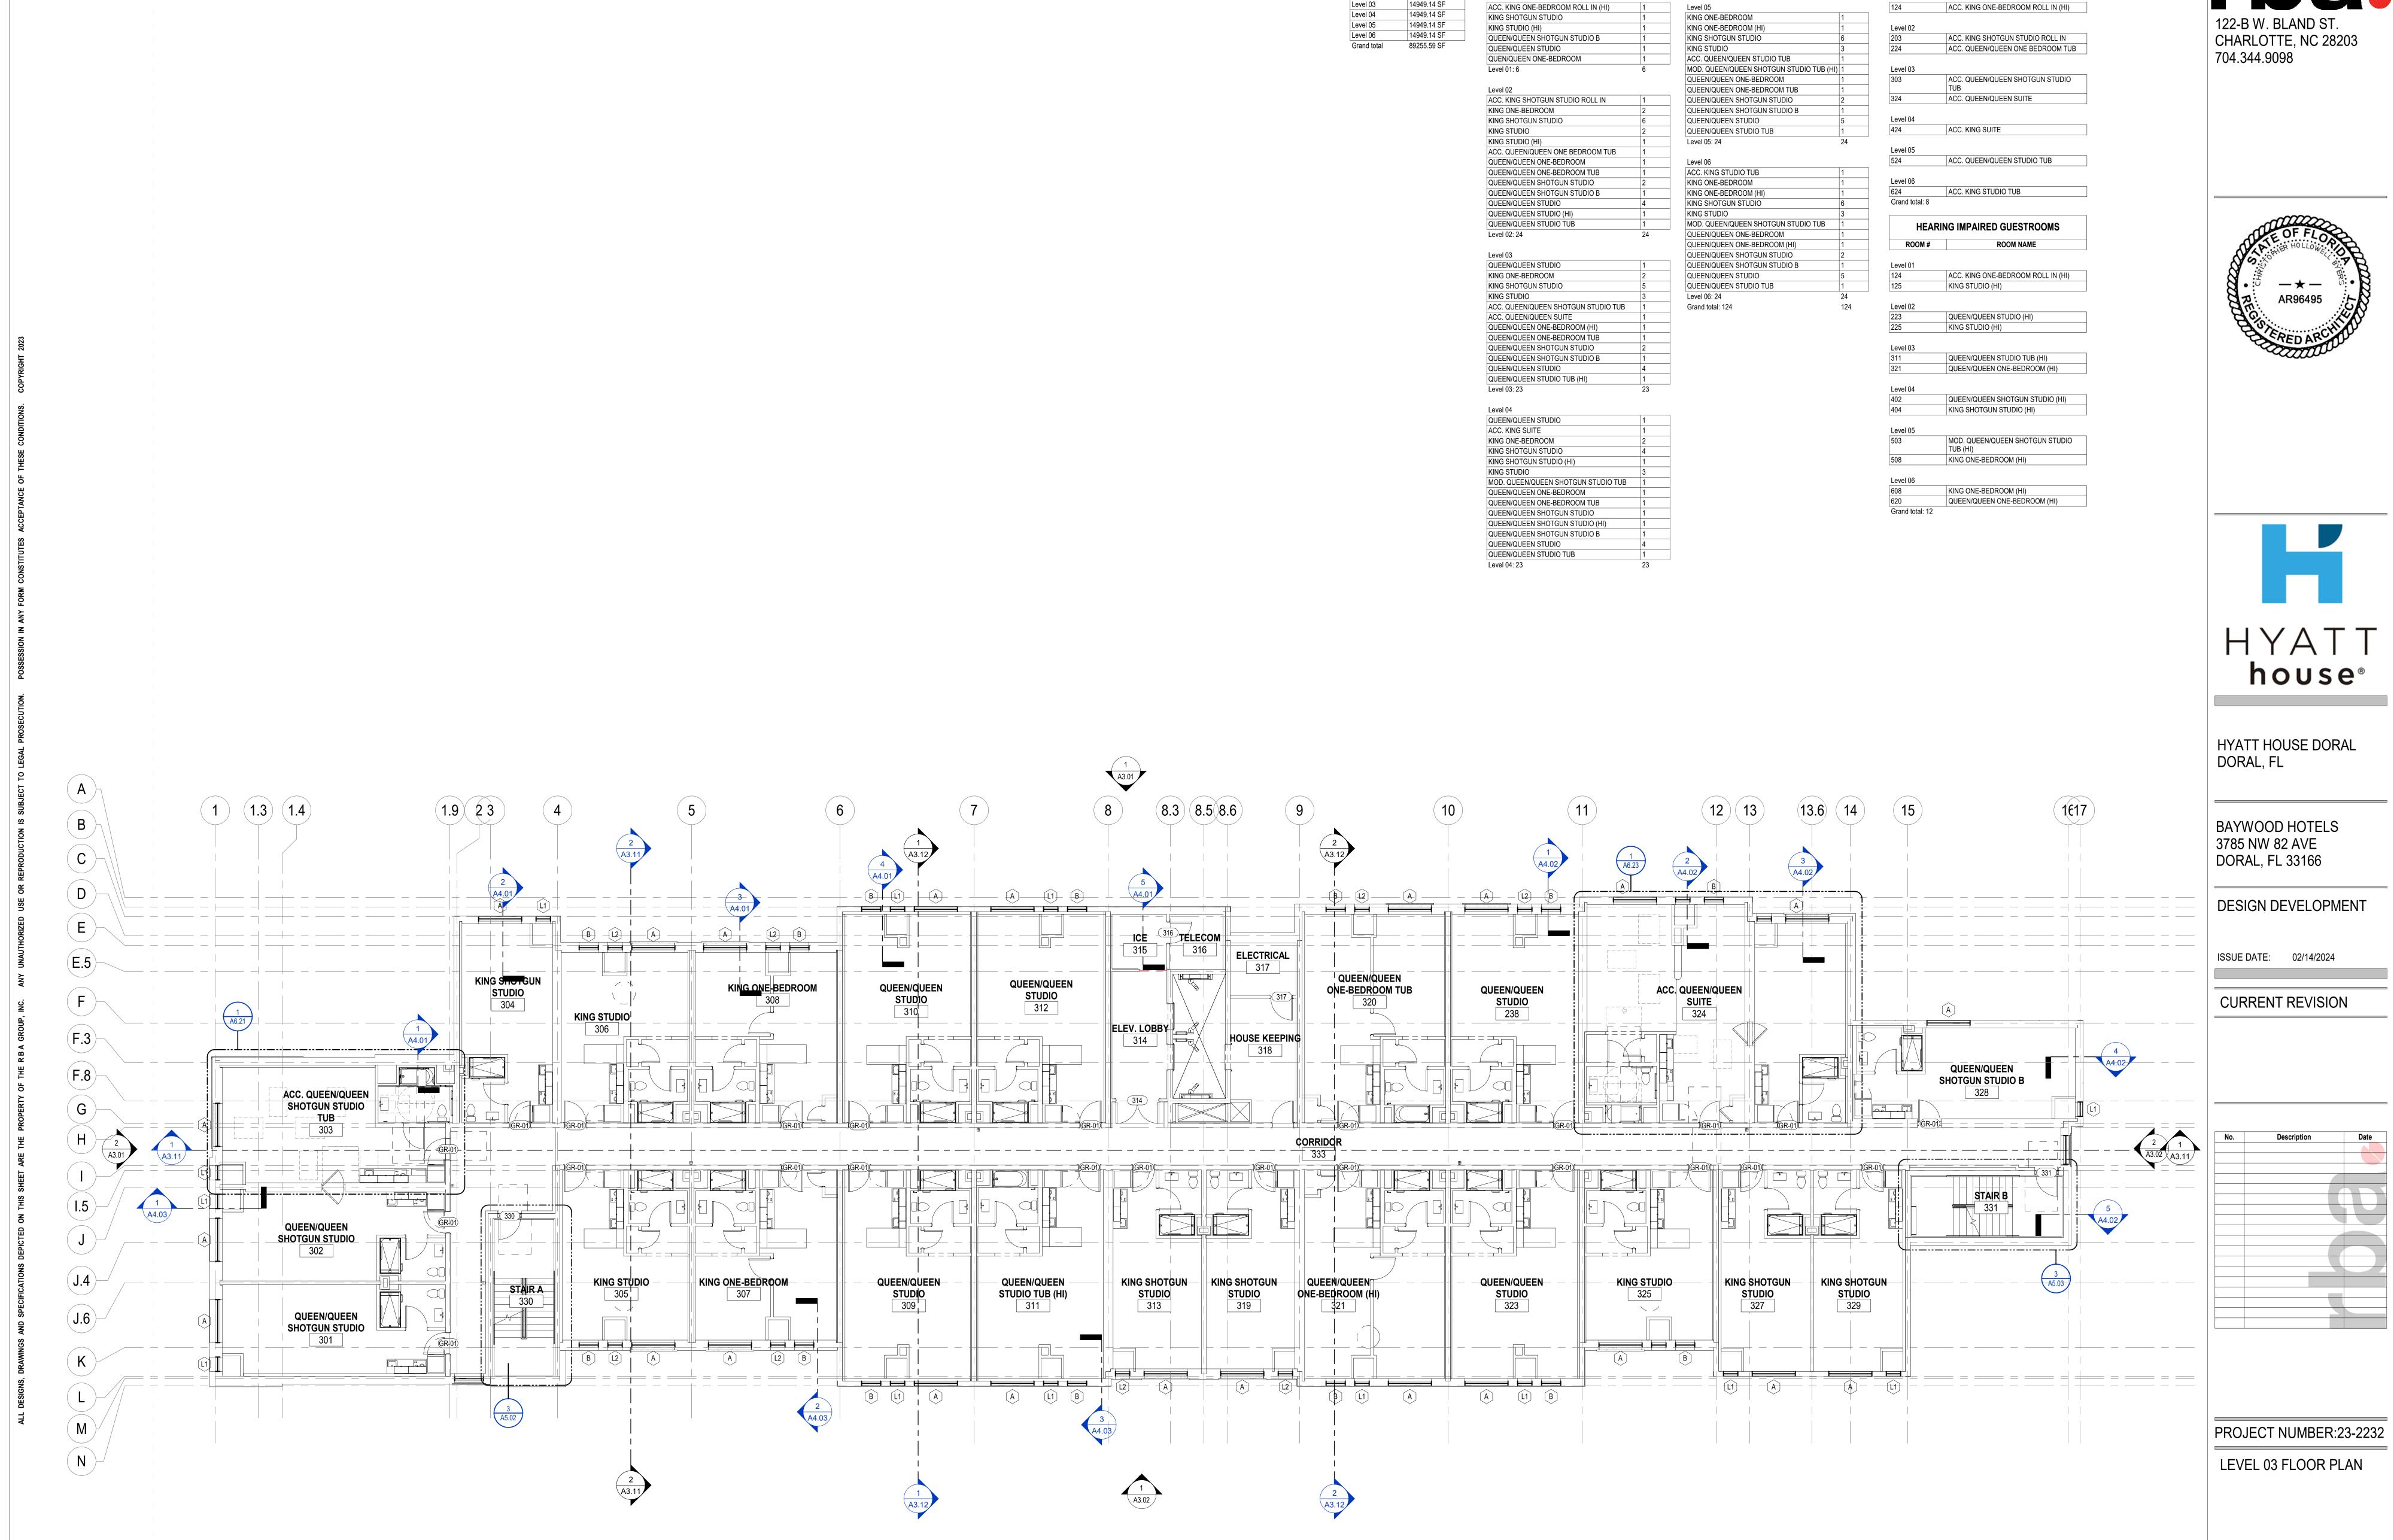

1 LEVEL 03 FLOOR PLAN
A2.03 1/8" = 1'-0"

RECEIVED

By Stephanie Puglia at 9:55 am, Feb 21, 2024

BUILDING GROSS AREA

AREA

14509.89 SF 14949.14 SF

LEVEL

Level 01 Level 02 **GUESTROOM COUNT**

GUESTROOM COUNT

ADA GUESTROOMS

ROOM NAME


ROOM #

COUNT

122-B W. BLAND ST. CHARLOTTE, NC 28203 704 344 9098

A2.03

2/15/2024 5:12:10 PM

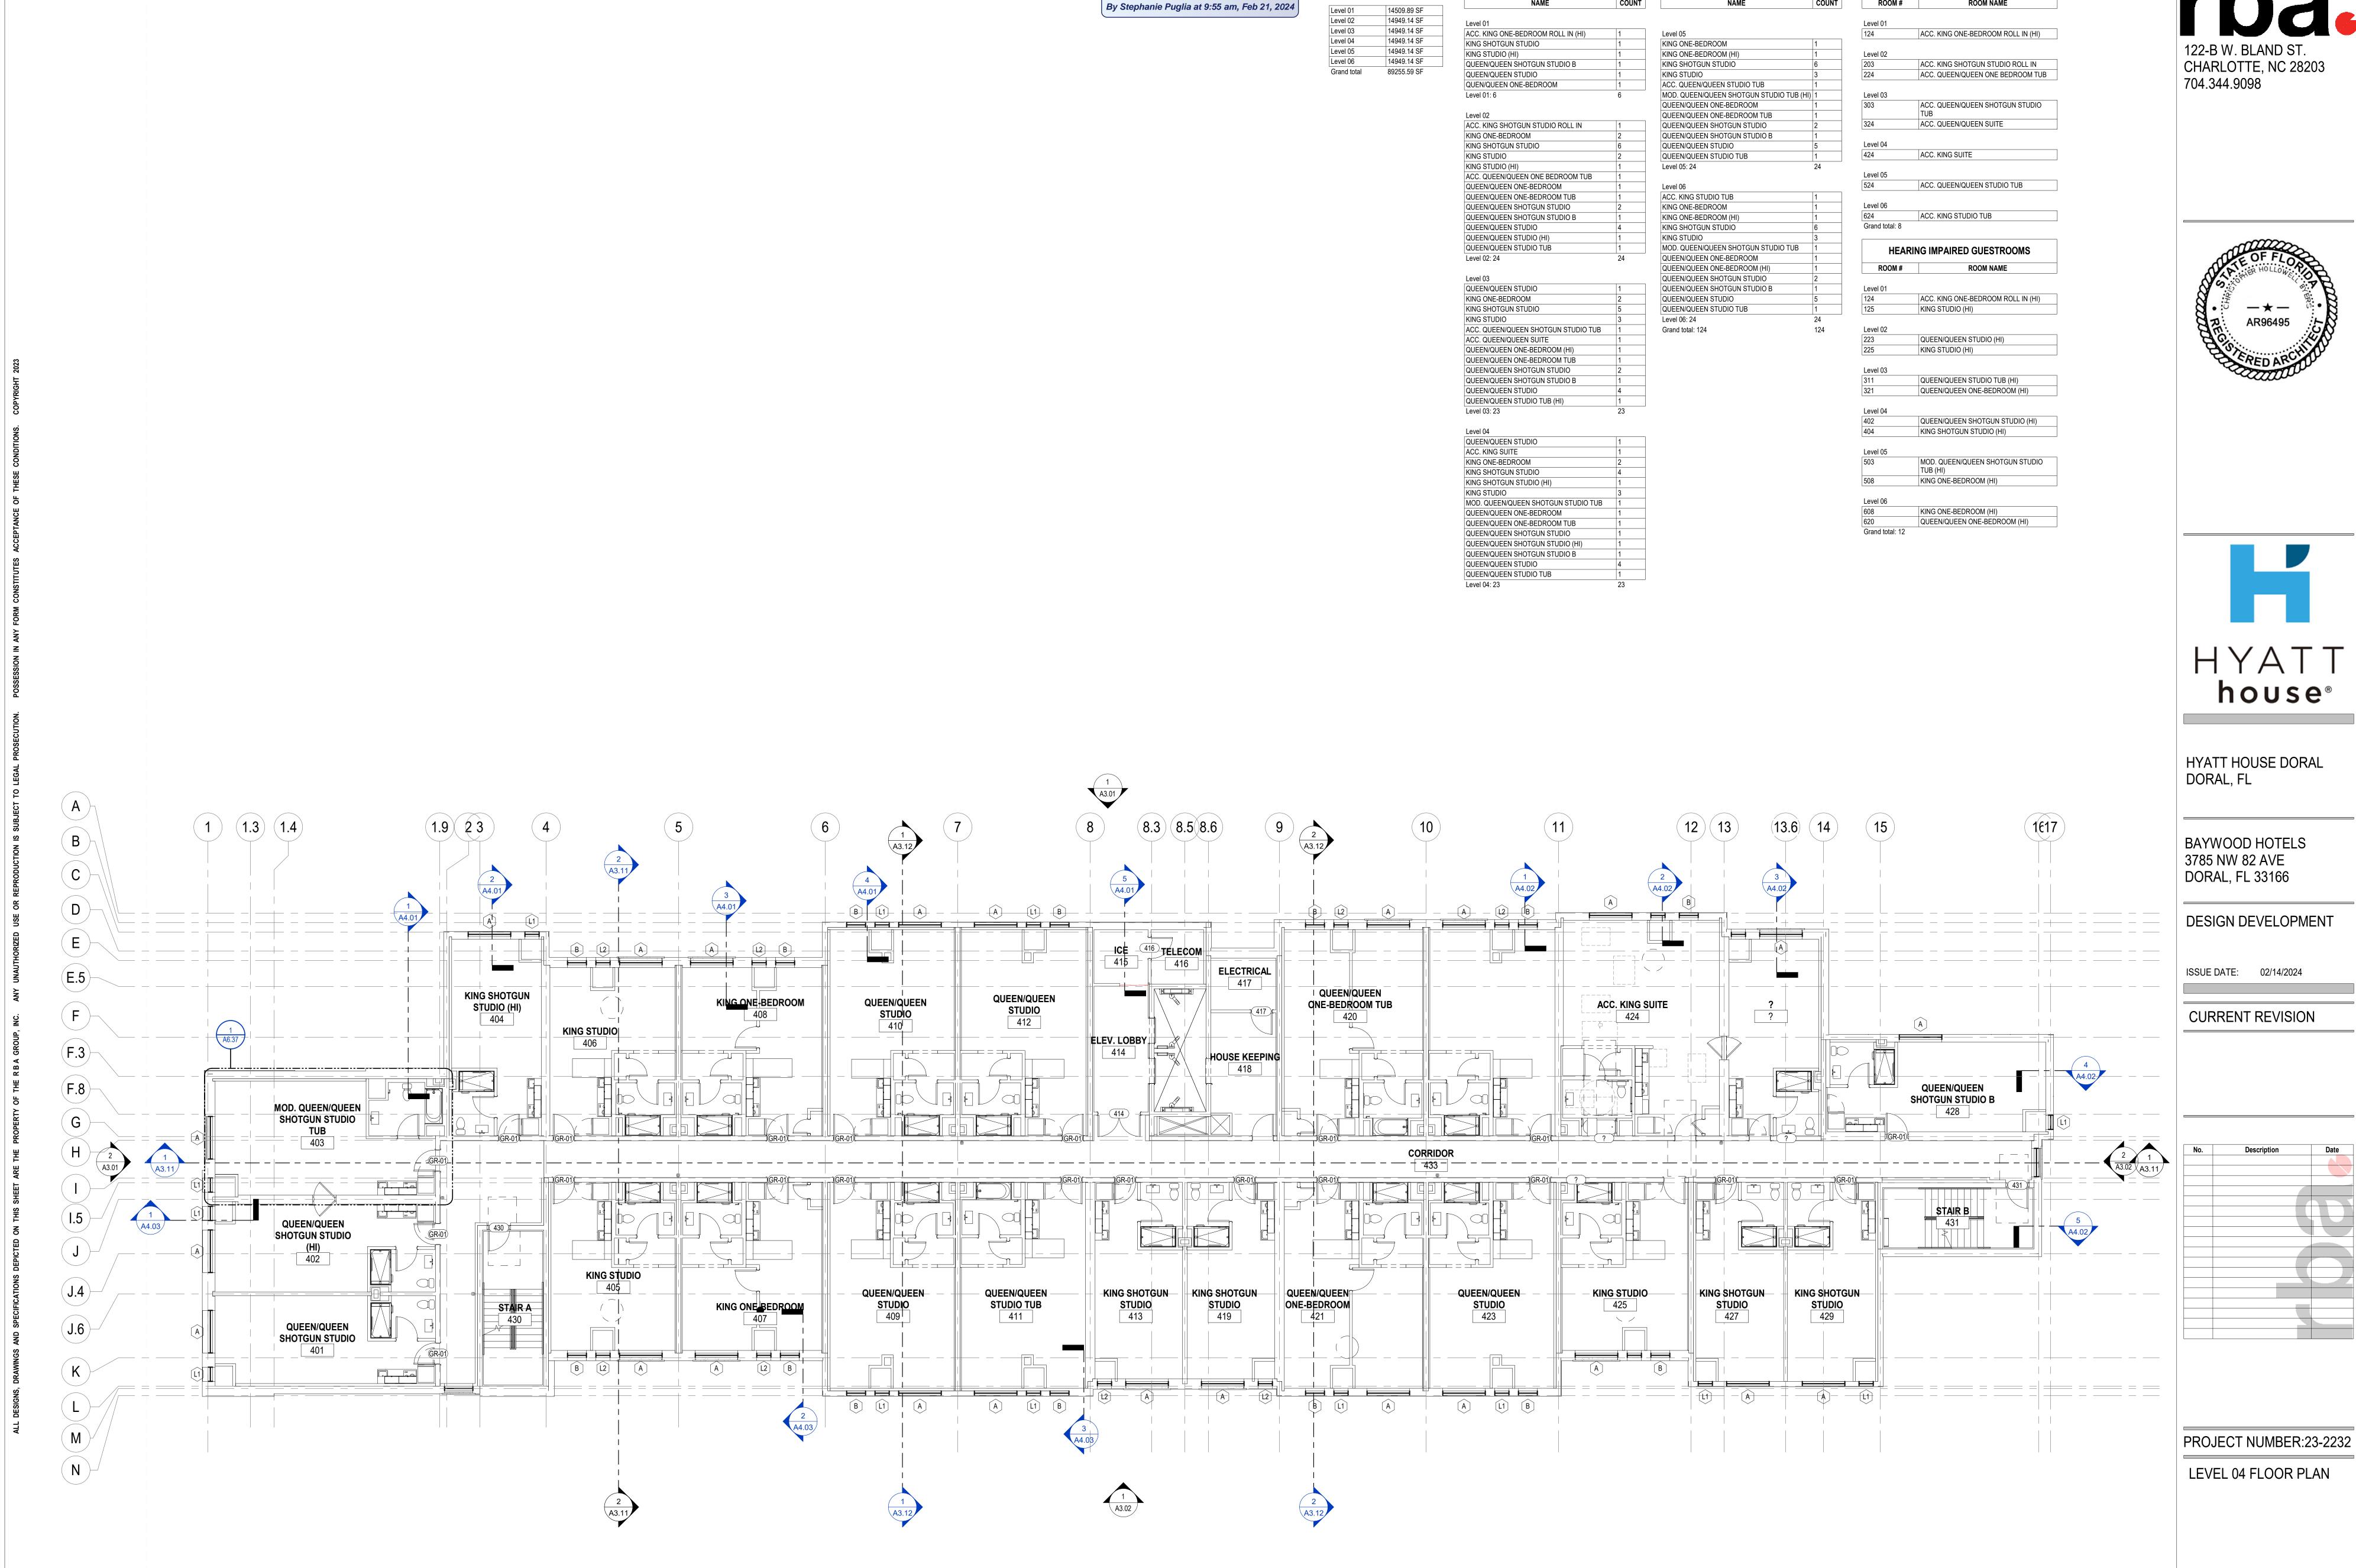

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A2.04 1/8" = 1'-0"

RECEIVED

BUILDING GROSS AREA

AREA

LEVEL

GUESTROOM COUNT


GUESTROOM COUNT

ADA GUESTROOMS

ROOM NAME

ROOM #


COUNT

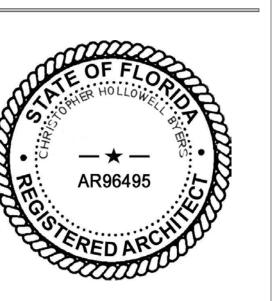



A2.04

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A2.05 1/8" = 1'-0"

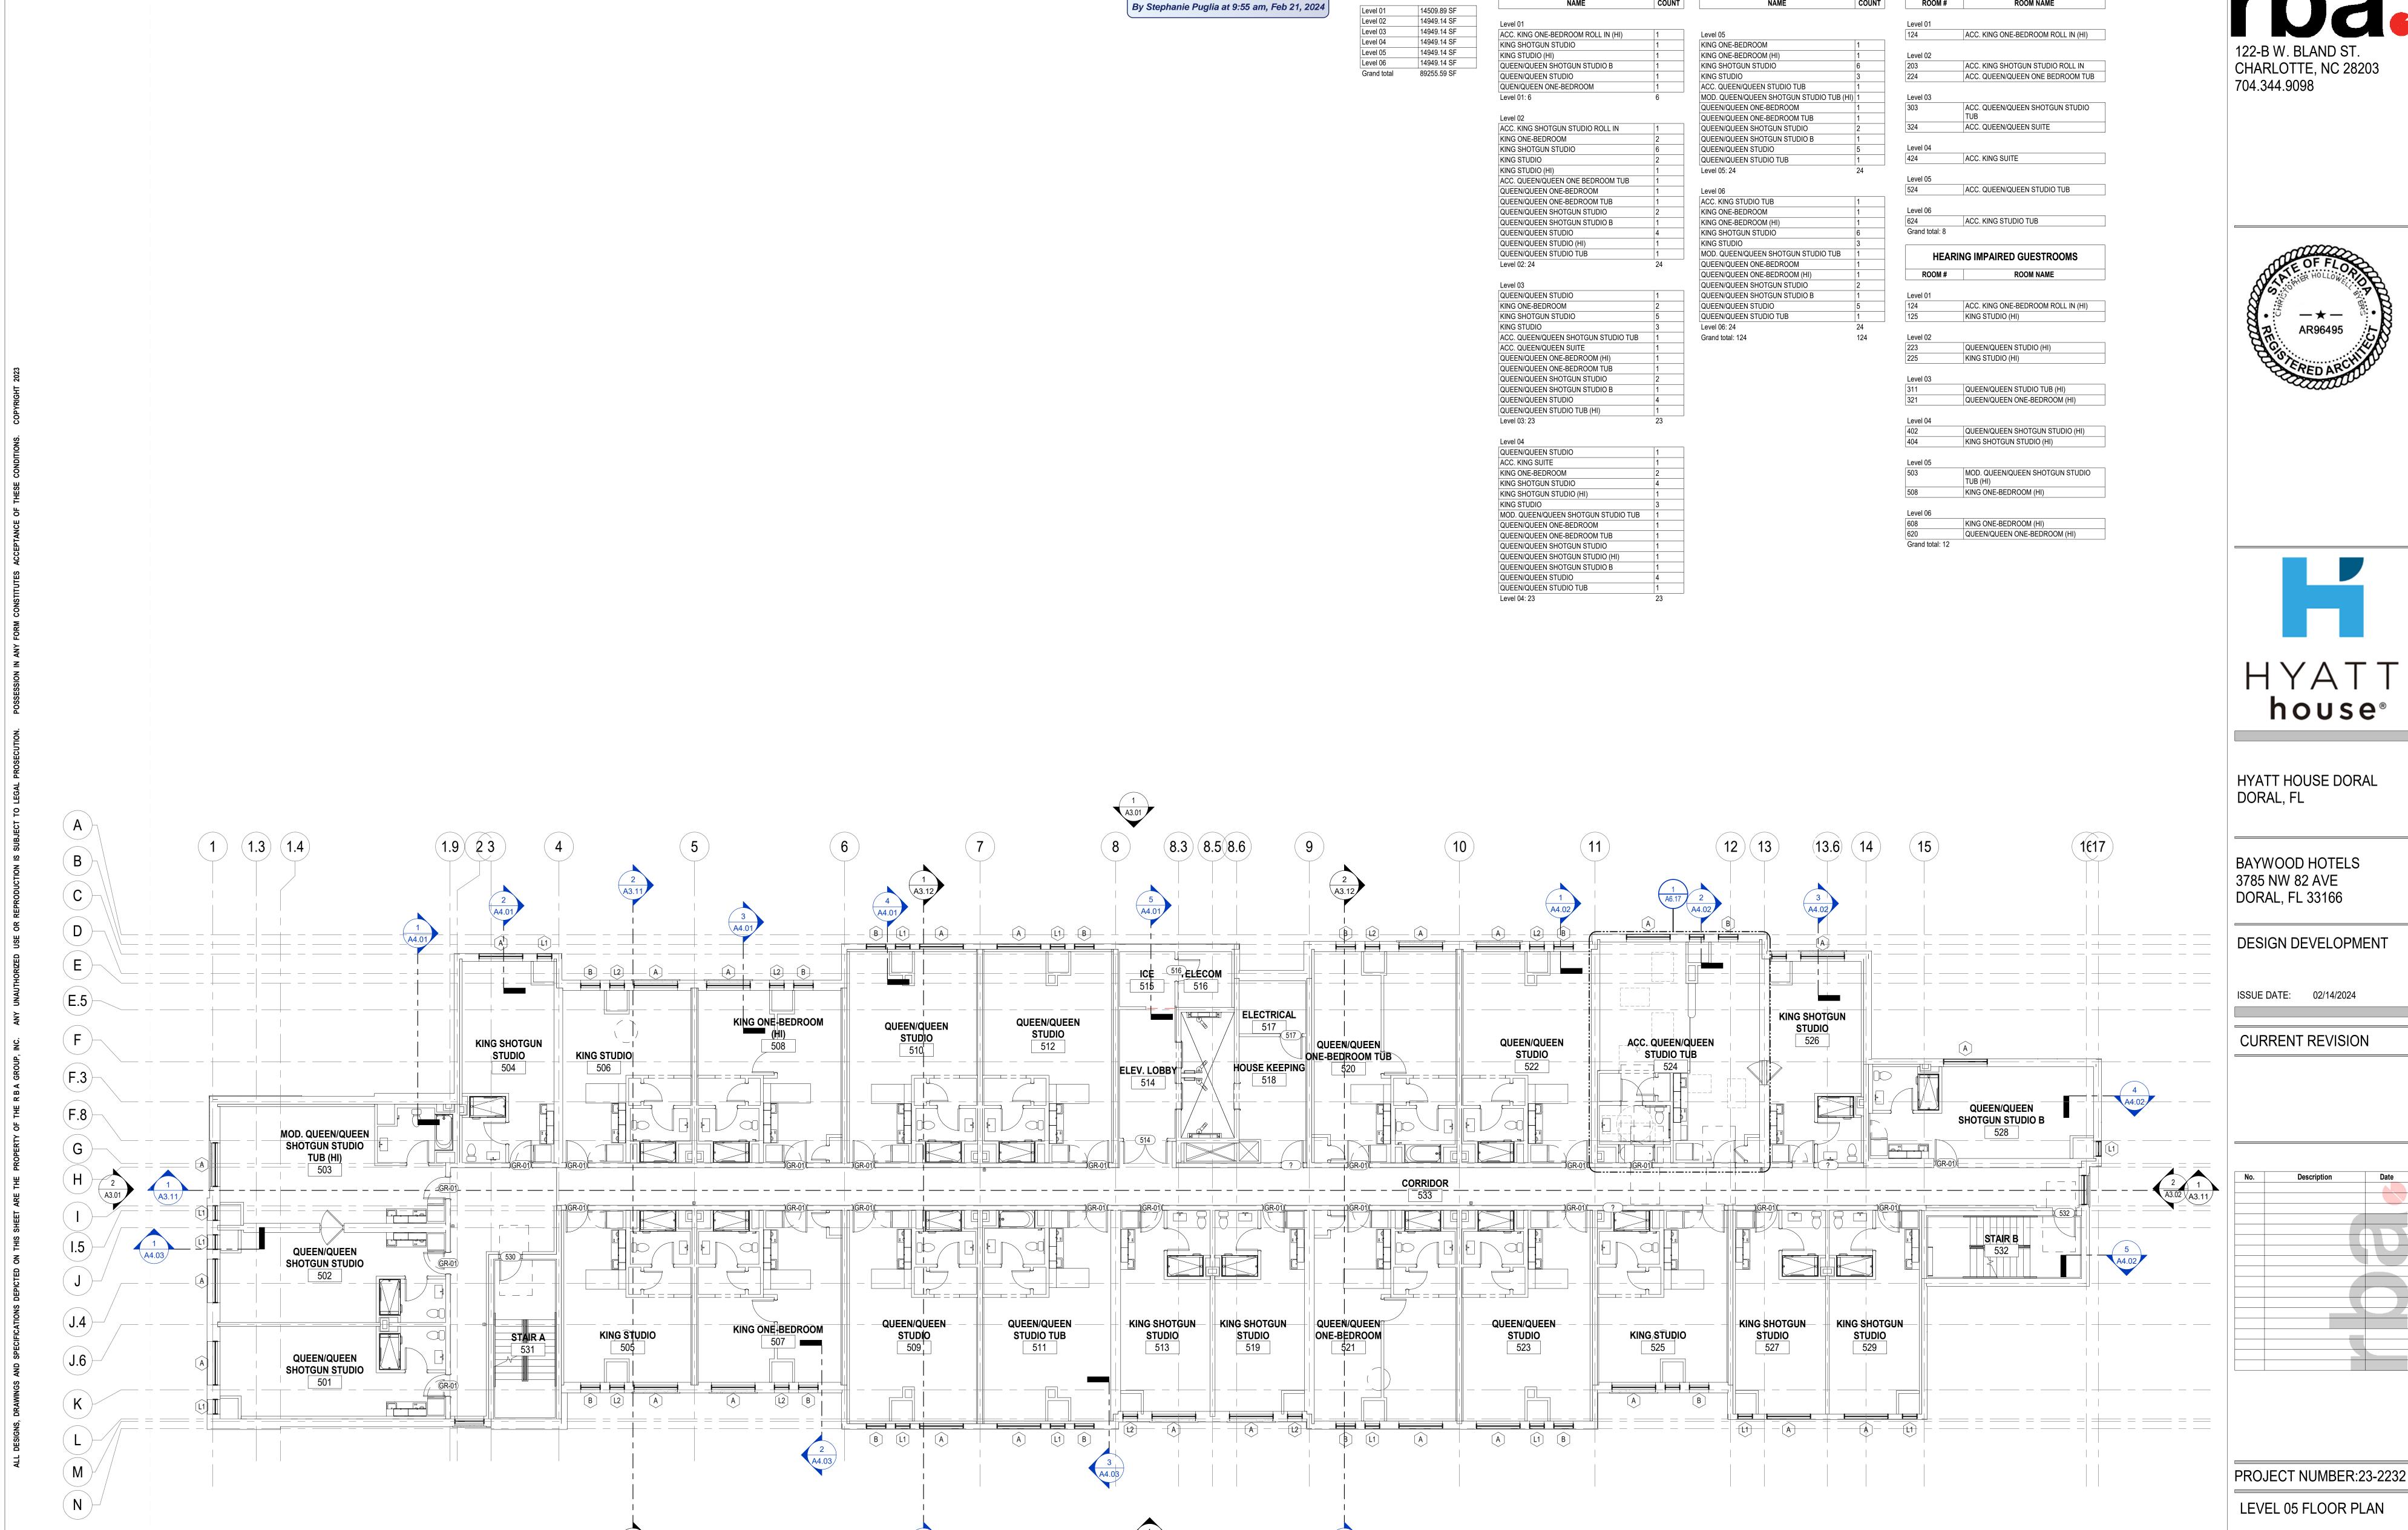RECEIVED

BUILDING GROSS AREA

AREA

LEVEL

GUESTROOM COUNT


GUESTROOM COUNT

ADA GUESTROOMS

ROOM NAME

ROOM #

COUNT

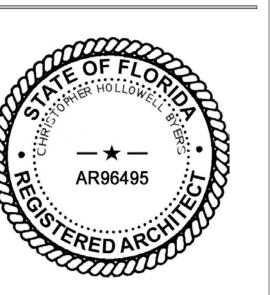






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RECEIVED

By Stephanie Puglia at 9:55 am, Feb 21, 2024

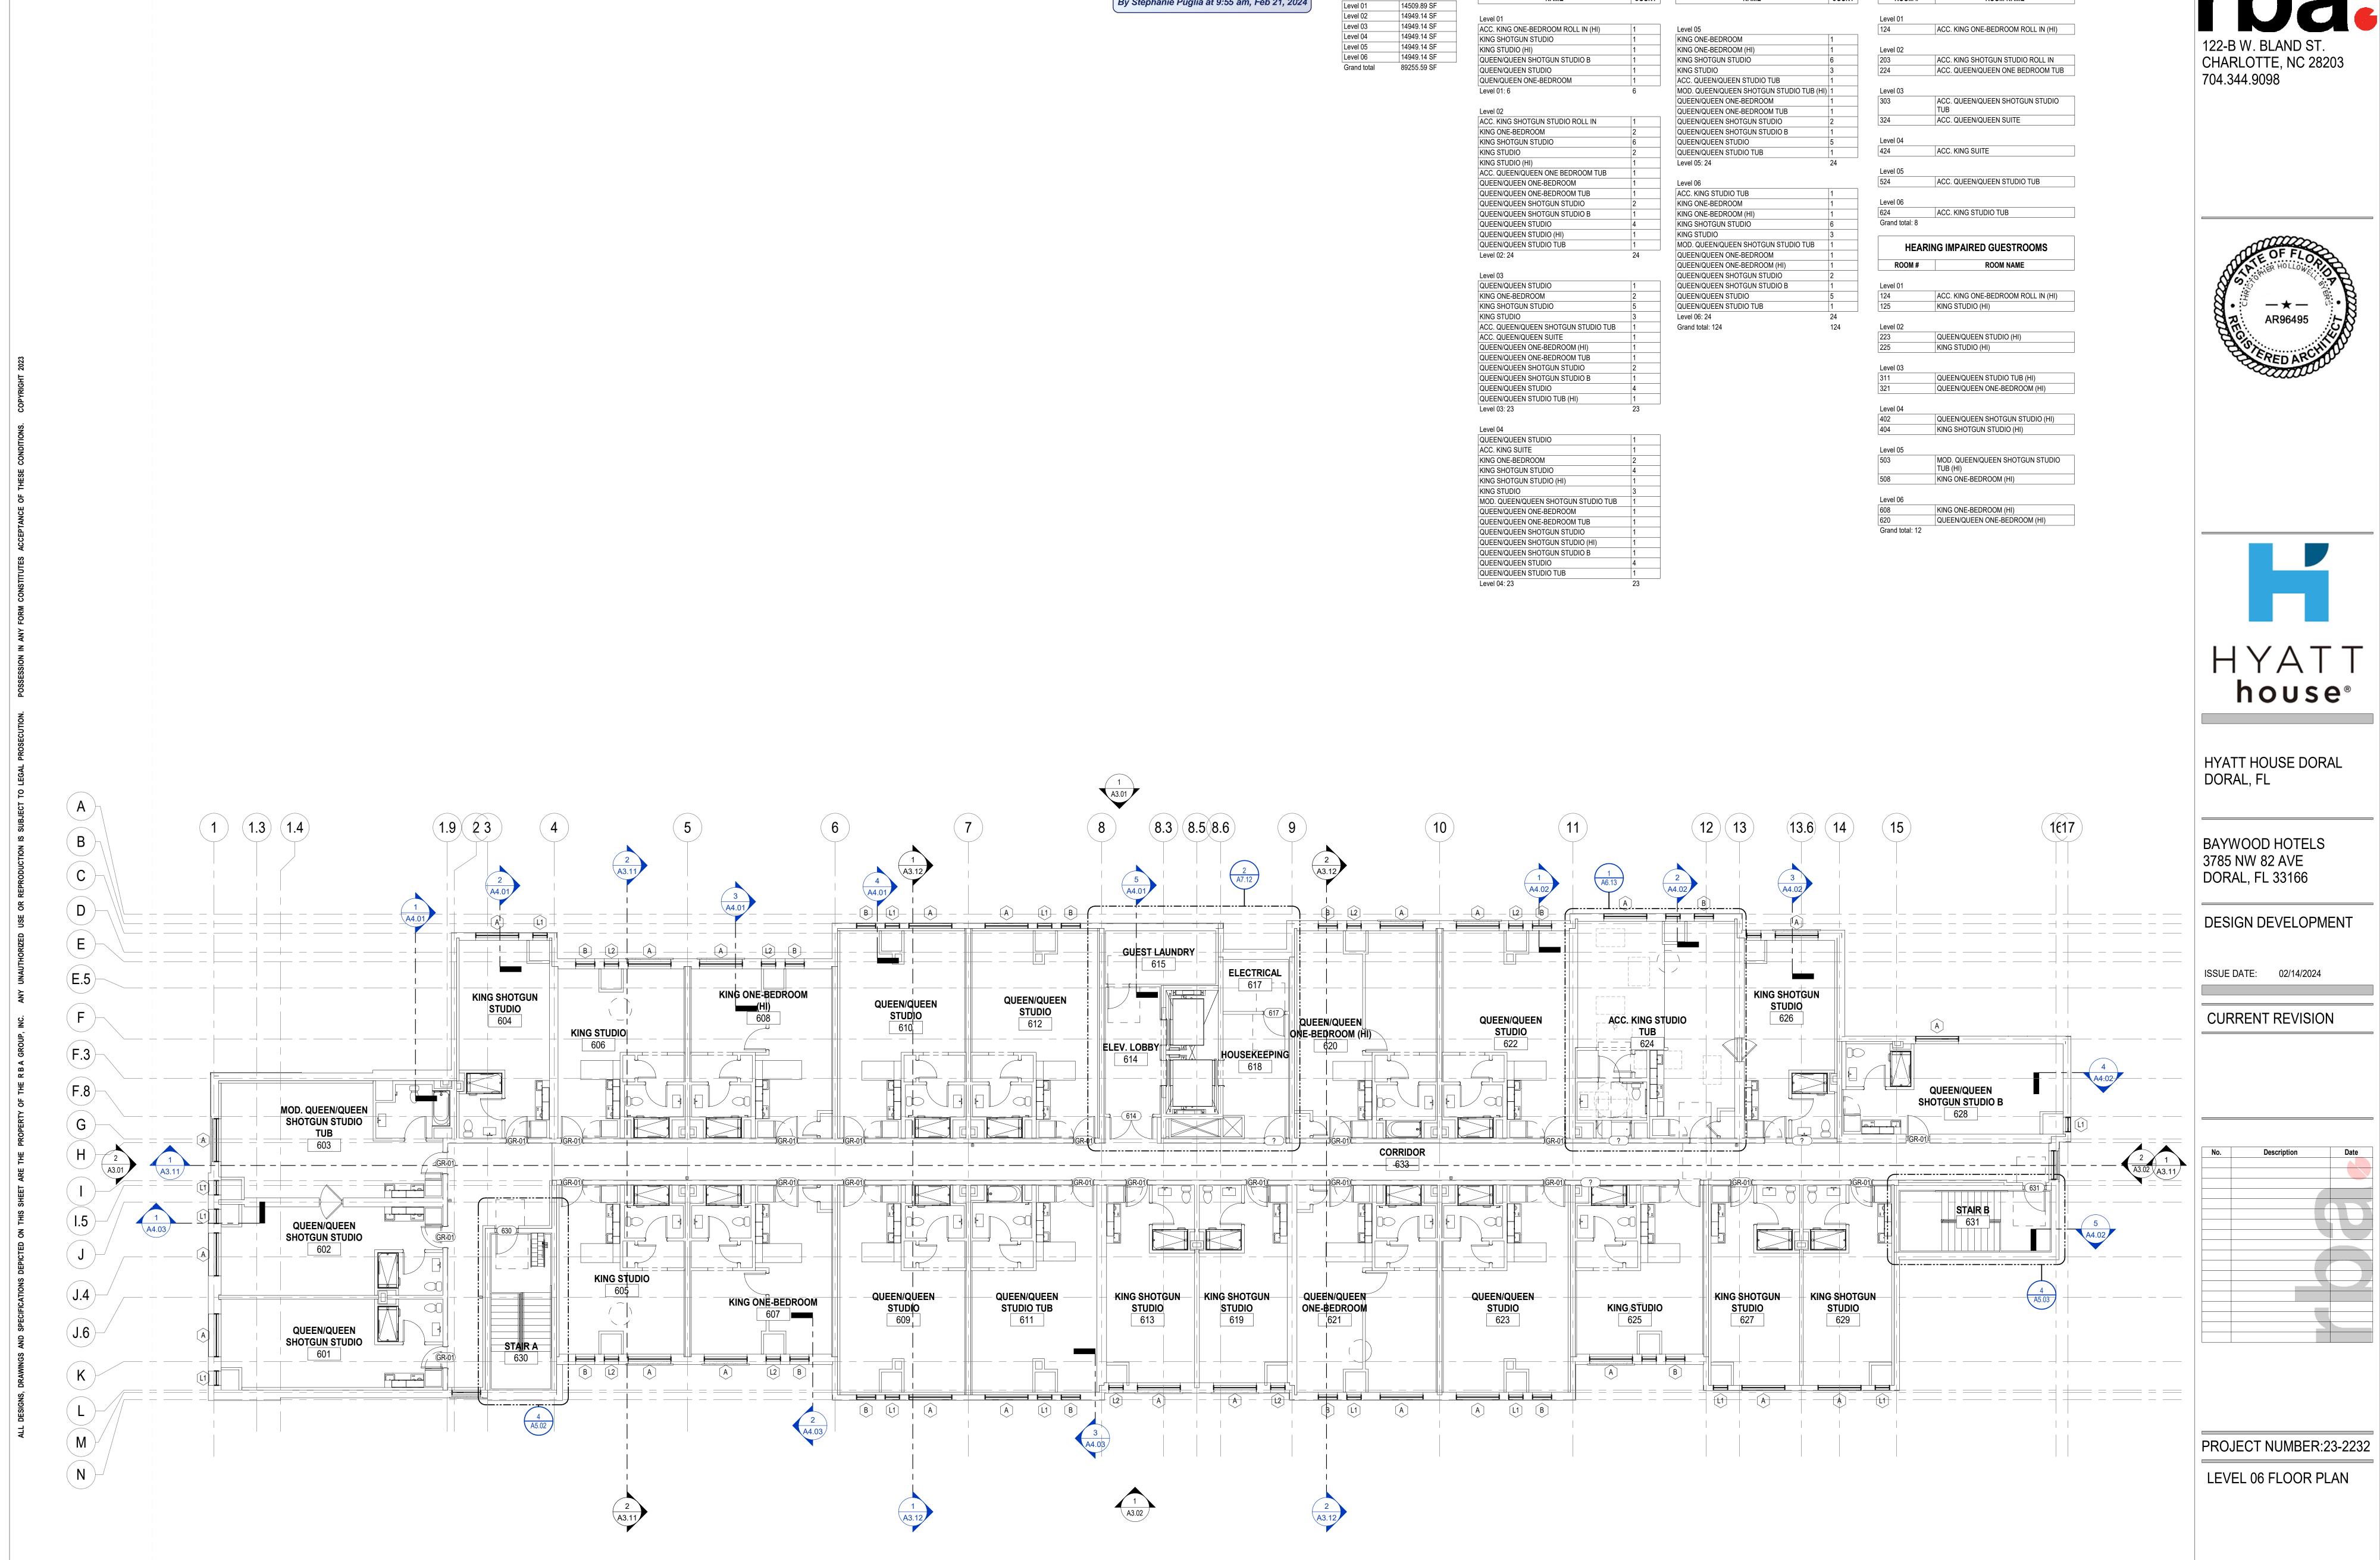BUILDING GROSS AREA

AREA

14509.89 SF 14949.14 SF

LEVEL

GUESTROOM COUNT


GUESTROOM COUNT

ADA GUESTROOMS

ROOM NAME

ROOM #


COUNT

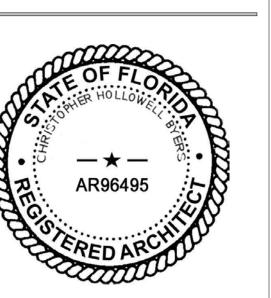



A2.06

2/15/2024 5:12:25 PM

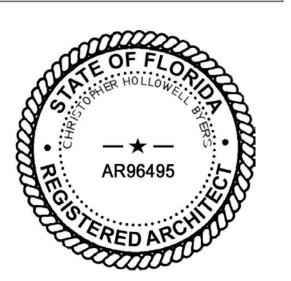

house®

HYATT HOUSE DORAL DORAL, FL

BAYWOOD HOTELS 3785 NW 82 AVE DORAL, FL 33166

DESIGN DEVELOPMENT

ISSUE DATE: 02/14/2024

CURRENT REVISION

ROOF PLAN

A2.07

2/15/2024 5:43:24 PM

 13

 12

A

STN-01

STUC-01

STN-01

A3.12

2 ENTRY ELEVATION
A3.01 1/8" = 1'-0"

STUC-01

STUC-01

STUC-01

1 NORTH ELEVATION

A3.01 1/8" = 1'-0"

1716

RECEIVED

By Stephanie Puglia at 9:55 am, Feb 21, 2024

8.6 8.5 8.3

ELEVATION NOTES

- CONTRACTOR TO COORDINATE LOCATION OF KNOX-BOX WITH FIRE MARSHAL FOR STREET LEVEL ENTRANCE & PER LOCAL CODES. KNOX-BOX TO BE FULLY RECESSED IF ALLOWED BY LOCAL CODES.
 ALL EXTERIOR HOSE BIBS ARE TO BE RECESSED, FROST PROOF TYPE WITH
- LOCKABLE ACCESS DOOR & NUT KEYED HANDLE. NICKEL BRONZE IN COLOR.

 3. ALL EXTERIOR OUTLETS TO BE GFI, RECESSED TYPE WITH APPROVED, WATERPROOF & LOCKABLE COVER PLATE.
- WATERPROOF & LOCKABLE COVER PLATE.

 4. COORDINATE EXTERIRO LOUVERS WITH MECHANICAL DRAWINGS AND MANUFACTURER'S WRITTEN SPECIFICATIONS.

 5. LOUVERS ARE TO MATCH ADJACENT FINISH.
- 6. STUCCO SHALL BE INSTALLED PER MANUFACTURER'S WRITTEN SPECIFICATIONS, STANDARDS AND RECOMMENDATIONS. PROVIDE FULLY DRAINABLE SYSTEM.
 7. SEADANTS AT ALL GLAZING, DOORS & LOUVERS SHALL MATCH THE COLOR OF THE 704.344.9098
- SYSTEM BEING USED AND APPROVED TO BE COMPATIBLE WITH ALL ADJACENT MATERIALS.

 8. ALL ALUMINUM COPING TO BE PRE-FINISHED AND INSTALLED WITH HIDDEN CLIPS OVER CONTINUOUS TPO MEMBRANE UNDERLAYMENT TO CAP
- SHEATHING/FRAMING.

 9. ALL EXPOSED FOUNDATIONS TO BE COVERED WITH E.I.F.S FINISHED TOP-COAT. NO

 10. EXPOSED FOUNDATION SURFACES ALLOWED.

 11. CONTRACTOR TO COORDINATE BRICK VENEER SHELF ANGLE SUPPORTS OVER 30-
- FEET IN LENGTH AND SET CONTINUOUS WITH TYPICAL HEAD HEIGHT OF WINDOW WITHIN BRICK TO CREATE A CONSISTENT BRICK SEAM.

 12. ALL BRICK LINTELS ARE TO BE GALVANIZED, PRIMED ON ALL SIDES AND PAINTED TO MATCH COLOR OF ADJACENT BRICK OR HEADER.
- ALL COPING TO TURN DOWN FACE OF WALL/PARAPET 6" WITH CONTINUOUS ROLLED HEMMED DRIP EDGES U.N.O.
 SUBMIT SHOP DRAWINGS FOR ALL WALL PANEL LAYOUTS INCLUDING COMPOSITE METAL PANELS, FIBER CEMENT PANELS, ETC, AS APPLICABLE.

EXTERIOR MATERIALS

BRK-01
BELDEN BRICK, BEAVER BLEND
COLOR, SEMI-SMOOTH

STUC-01
STUCCO, LIMESTONE TEXTURE

STUCCO, LIMESTONE TEXTURE
WITH HAMMERED METALIC COATING

COMPOSITE METAL PANEL

WITH 10308 PEARL 86 COATING

STN-01
ACCENT BAND CAST STONE

FACADE SIGNAGE NOTES

SPACE AVAILABLE.

 ALL SIGNAGE INDICATED FOR ILLUSTRATIVE PURPOSES ONLY.
 MAXIMUM 3/4" THICK EXTERIOR GRADE PLYWOOD BACKER BOARD REQUIRED AT SIGN LOCATION. AREA SHOULD COVER ENTIRE LENGTH AND HEIGHT OF FASCIA OR

LAYOUT MUST BE OBTAINED FROM THE SIGN COMPANY.

1.4 1.3


STUC-02

BRK-01

HYATT HAT 80' - 0"

- ELECTRICAL AND FINAL CONNECTION BY CONTRACTOR. ELECTRICAL REQUIREMENTS MAY BE OBTAINED FROM SIGN COMPANY. TYPICAL120 V. 1714 REQUIREMENTS.
- RACEWAYS/ WIREWAYS ARE NOT ALLOWED.
 GUESTROOMS OR PUBLIC SPACES WITH SIGNAGE ON EXTERIOR WALLS MUST HAVE ELECTRICAL PENETRATIONS AND /OR REMOTE TRANSFORMERS COORDINATED AND/OR INSTALLED PRIOR TO CLOSING UP THE WALL PENETRATION.



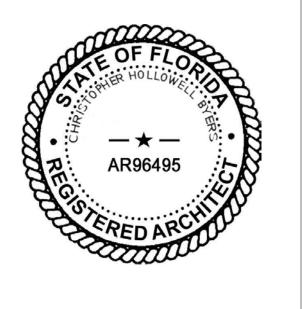



HYATT HOUSE DORAL DORAL, FL

BAYWOOD HOTELS 3785 NW 82 AVE DORAL, FL 33166

DESIGN DEVELOPMENT

ISSUE DATE: 02/14/2024

CURRENT REVISION

Description Date

PROJECT NUMBER:23-2232
BUILDING ELEVATIONS

A3.01

2/15/2024 5:12:45 PM

Parapet 70' - 0" BRK-01 Low Parapet 66', 50", 64' - 0" STUC-02 BRK-01 STUC-02 Level 06 54' - 0" Level 05 44' - 0" STUC-01 BRK-01 STUC-02 Level 04 34' - 0" Level 03 24' - 0" STUC 01 STUC-02 BRK-01 STUC-01 Level 02 14' - 0" ACM-01 ACM-01 BRK-01 BRK-01 ACM-01 ACM-01 Level 01 0' - 0"

 $\begin{array}{|c|c|}\hline & 2\\\hline A3.11 \\\hline \end{array}$

STN-01

A3.12

2 A3.11

STUC-02

1 SOUTH ELEVATION
A3.02 1/8" = 1'-0"

ACM-01

ACM-01

- 1. CONTRACTOR TO COORDINATE LOCATION OF KNOX-BOX WITH FIRE MARSHAL FOR STREET LEVEL ENTRANCE & PER LOCAL CODES. KNOX-BOX TO BE FULLY RECESSED IF ALLOWED BY LOCAL CODES.
- 2. ALL EXTERIOR HOSE BIBS ARE TO BE RECESSED, FROST PROOF TYPE WITH LOCKABLE ACCESS DOOR & NUT KEYED HANDLE. NICKEL BRONZE IN COLOR. 3. ALL EXTERIOR OUTLETS TO BE GFI, RECESSED TYPE WITH APPROVED, WATERPROOF & LOCKABLE COVER PLATE.
- 4. COORDINATE EXTERIRO LOUVERS WITH MECHANICAL DRAWINGS AND MANUFACTURER'S WRITTEN SPECIFICATIONS.
- 6. STUCCO SHALL BE INSTALLED PER MANUFACTURER'S WRITTEN SPECIFICATIONS, STANDARDS AND RECOMMENDATIONS. PROVIDE FULLY DRAINABLE SYSTEM. STANDARDS AND RECOMMENDATIONS. PROVIDE FULLY DRAINABLE SYSTEM.

 7. SEALANTS AT ALL GLAZING, DOORS & LOUVERS SHALL MATCH THE COLOR OF THE 704.344.9098

5. LOUVERS ARE TO MATCH ADJACENT FINISH.

- SYSTEM BEING USED AND APPROVED TO BE COMPATIBLE WITH ALL ADJACENT MATERIALS. 8. ALL ALUMINUM COPING TO BE PRE-FINISHED AND INSTALLED WITH HIDDEN CLIPS
- OVER CONTINUOUS TPO MEMBRANE UNDERLAYMENT TO CAP SHEATHING/FRAMING. 9. ALL EXPOSED FOUNDATIONS TO BE COVERED WITH E.I.F.S FINISHED TOP-COAT. NO 10. EXPOSED FOUNDATION SURFACES ALLOWED.
- 11. CONTRACTOR TO COORDINATE BRICK VENEER SHELF ANGLE SUPPORTS OVER 30-FEET IN LENGTH AND SET CONTINUOUS WITH TYPICAL HEAD HEIGHT OF WINDOW WITHIN BRICK TO CREATE A CONSISTENT BRICK SEAM. 12. ALL BRICK LINTELS ARE TO BE GALVANIZED, PRIMED ON ALL SIDES AND PAINTED TO
- MATCH COLOR OF ADJACENT BRICK OR HEADER. 13. ALL COPING TO TURN DOWN FACE OF WALL/PARAPET 6" WITH CONTINUOUS ROLLED HEMMED DRIP EDGES U.N.O.
- 14. SUBMIT SHOP DRAWINGS FOR ALL WALL PANEL LAYOUTS INCLUDING COMPOSITE METAL PANELS, FIBER CEMENT PANELS, ETC, AS APPLICABLE.

EXTERIOR MATERIALS

ELEVATION NOTES

BELDEN BRICK, BEAVER BLEND COLOR, SEMI-SMOOTH STUC-01 STUCCO, LIMESTONE TEXTURE WITH 10308 PEARL 86 COATING STUCCO, LIMESTONE TEXTURE

- 2. MAXIMUM 3/4" THICK EXTERIOR GRADE PLYWOOD BACKER BOARD REQUIRED AT
- 3. ELECTRICAL AND FINAL CONNECTION BY CONTRACTOR. ELECTRICAL REQUIREMENTS MAY BE OBTAINED FROM SIGN COMPANY. TYPICAL120 V. 1714
- 5. GUESTROOMS OR PUBLIC SPACES WITH SIGNAGE ON EXTERIOR WALLS MUST HAVE ELECTRICAL PENETRATIONS AND /OR REMOTE TRANSFORMERS COORDINATED AND/OR INSTALLED PRIOR TO CLOSING UP THE WALL PENETRATION.

Level 04 34' - 0"

Level 03 24' - 0"

Level 02 14' - 0"

ACM-01


BRK-01

STN-01

STUC-01

BRK-01



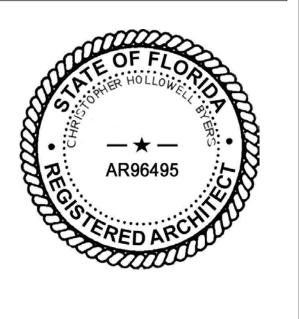



HYATT HOUSE DORAL DORAL, FL

BAYWOOD HOTELS 3785 NW 82 AVE DORAL, FL 33166

DESIGN DEVELOPMENT

ISSUE DATE: 02/14/2024


CURRENT REVISION

Description

PROJECT NUMBER:23-2232 **BUILDING ELEVATIONS**

A3.02

2/15/2024 5:12:49 PM

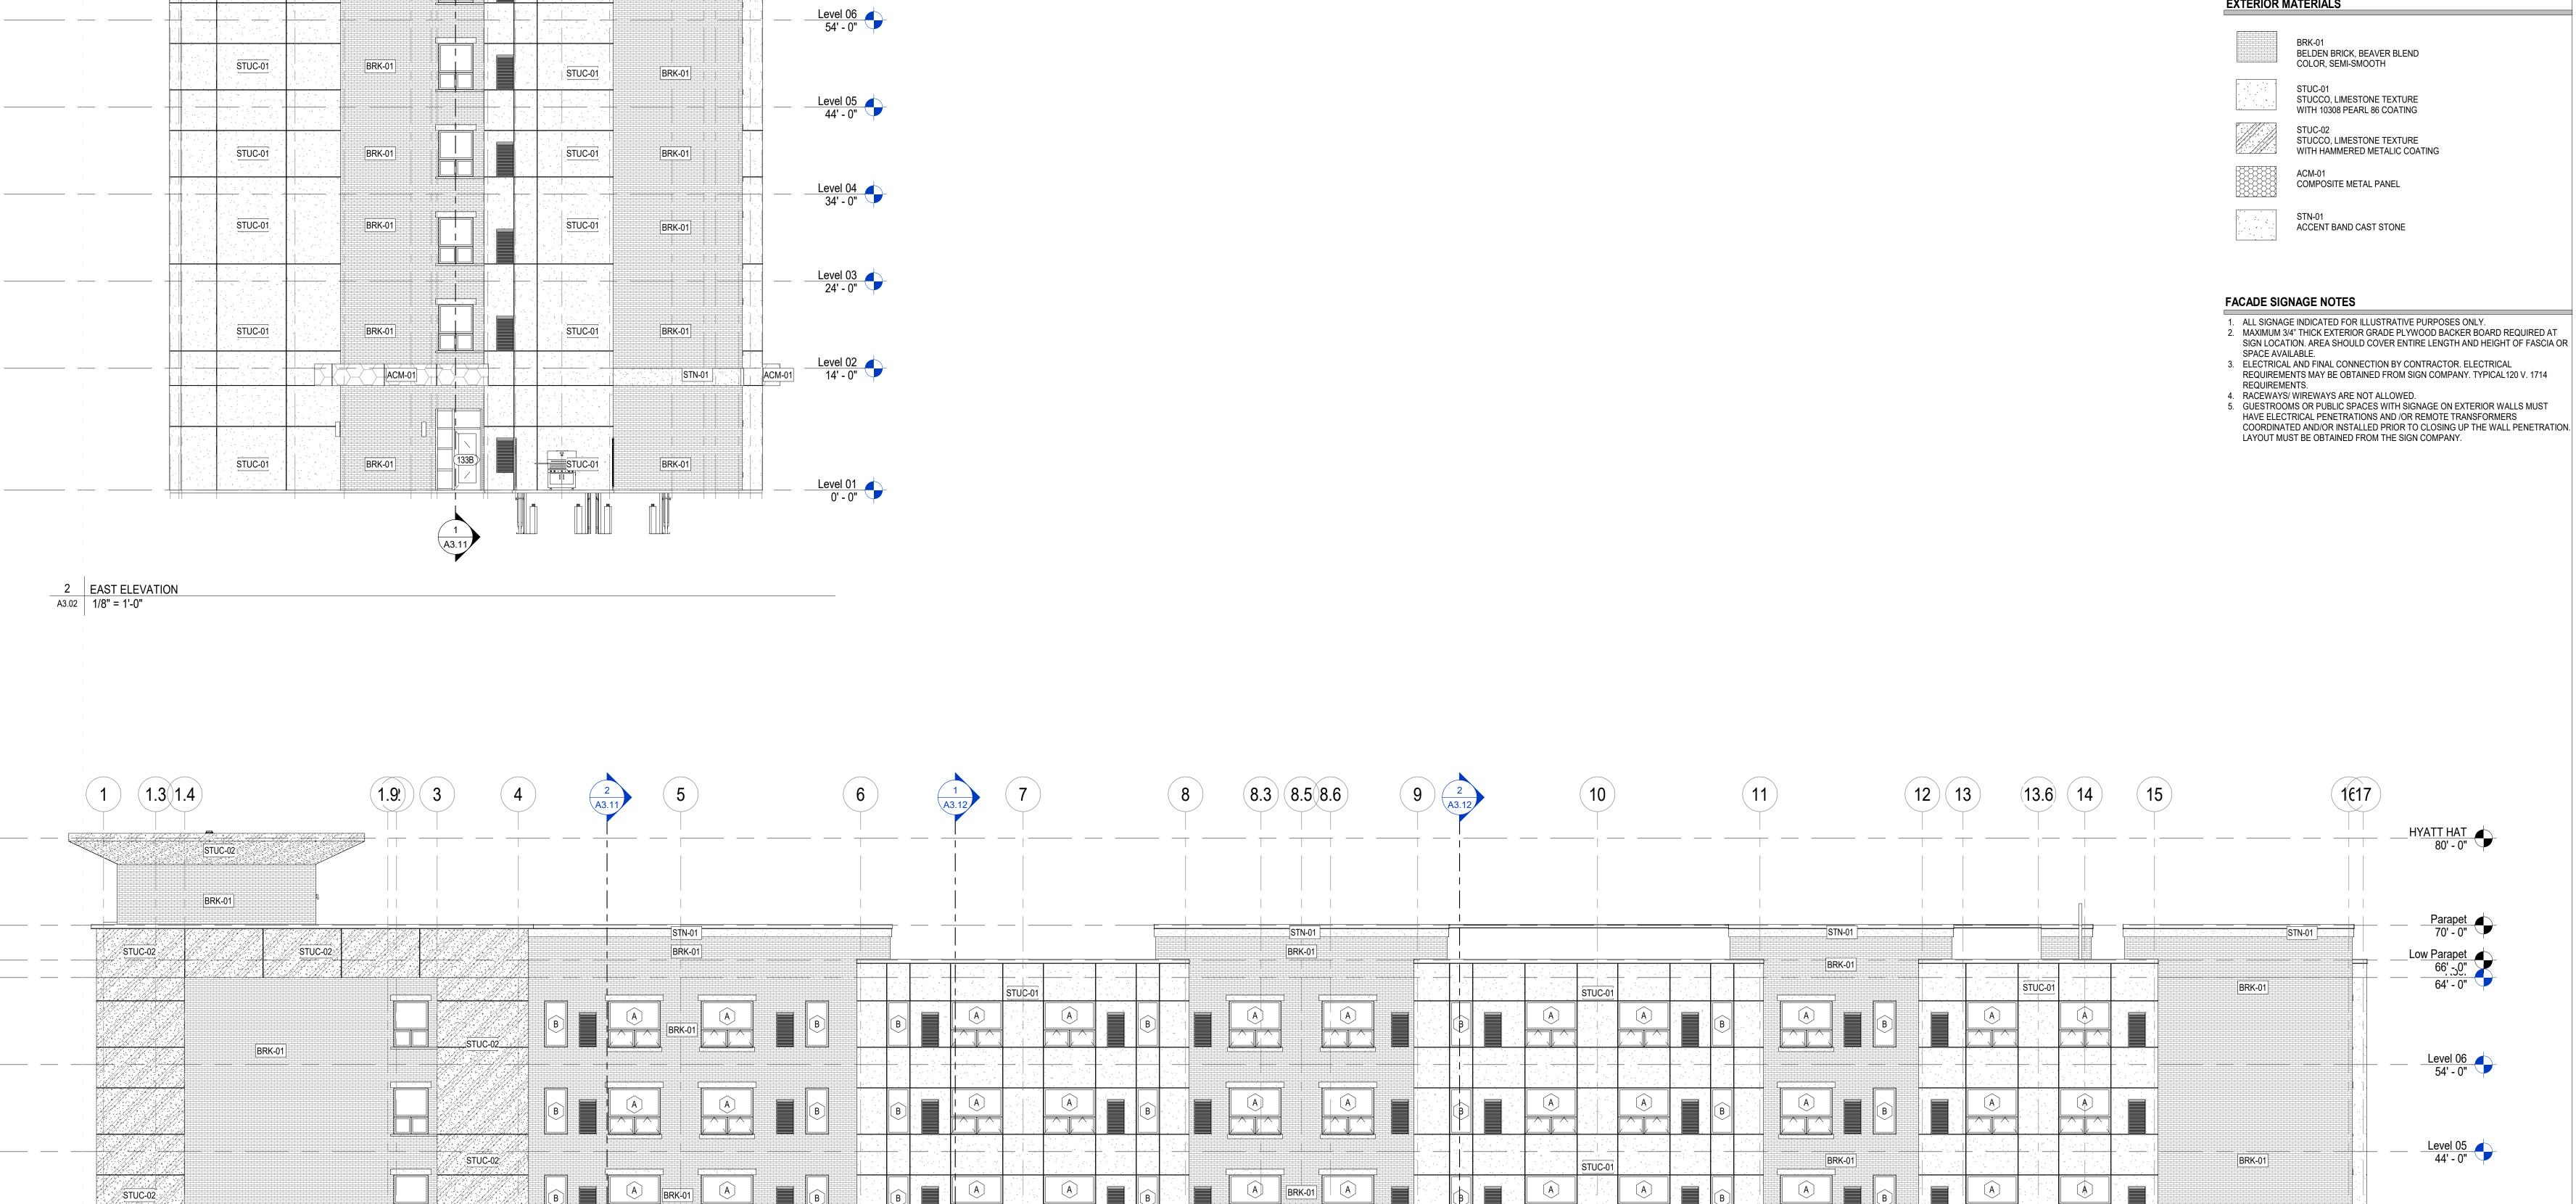

A3.12

RECEIVED

By Stephanie Puglia at 9:55 am, Feb 21, 2024



1 NORTH ELEVATION - COLORED
A3.03 1/8" = 1'-0"

EXTERIOR MATERIALS BRK-01 BELDEN BRICK, BEAVER BLEND COLOR, SEMI-SMOOTH STUC-01 STUCCO, LIMESTONE TEXTURE WITH 10308 PEARL 86 COATING 122-B W. BLAND ST. CHARLOTTE, NC 28203 STUC-02 STUCCO, LIMESTONE TEXTURE WITH HAMMERED METALIC COATING 704.344.9098 ACM-01 COMPOSITE METAL PANEL STN-01 ACCENT BAND CAST STONE HYATT house HYATT HOUSE DORAL DORAL, FL BAYWOOD HOTELS 3785 NW 82 AVE DORAL, FL 33166 1.4 1.3 DESIGN DEVELOPMENT HYATT HAT 80' - 0" ISSUE DATE: 02/14/2024 Parapet 70' - 0" CURRENT REVISION Low Parapet 66' 50" 64' - 0" Level 06 54' - 0" Level 05 44' - 0" Level 04 34' - 0" <u>Level 03</u> 24' - 0" Level 02 14' - 0" PROJECT NUMBER:23-2232 **BUILDING ELEVATIONS -**ILLUSTRATED Level 01 0' - 0" A3.03 2/15/2024 4:23:03 PM

RECEIVED

By Stephanie Puglia at 9:55 am, Feb 21, 2024


E.5 ED CBA $(H_{\bullet})(F.8)(F.3)(F)$ Parapet 70' - 0" Low Parapet 66' 50" 64' - 0" Level 05 44' - 0" Level 01 0' - 0" **EXTERIOR MATERIALS** BRK-01 BELDEN BRICK, BEAVER BLEND COLOR, SEMI-SMOOTH

STUC-01 STUCCO, LIMESTONE TEXTURE WITH 10308 PEARL 86 COATING

STUC-02 STUCCO, LIMESTONE TEXTURE WITH HAMMERED METALIC COATING ACM-01 COMPOSITE METAL PANEL

STN-01 ACCENT BAND CAST STONE

122-B W. BLAND ST. CHARLOTTE, NC 28203 704.344.9098

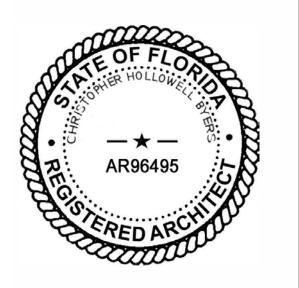




HYATT HOUSE DORAL DORAL, FL

BAYWOOD HOTELS 3785 NW 82 AVE DORAL, FL 33166

DESIGN DEVELOPMENT

ISSUE DATE: 02/14/2024

CURRENT REVISION

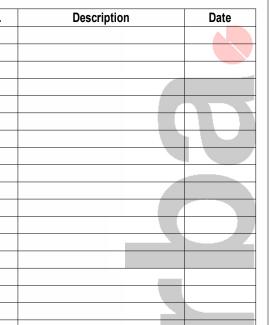

PROJECT NUMBER:23-2232

BUILDING ELEVATIONS -ILLUSTRATED

A3.04


2/15/2024 4:23:21 PM

1 SOUTH ELEVATION - COLORED
A3.04 1/8" = 1'-0"



RECEIVED

By Stephanie Puglia at 9:55 am, Feb 21, 2024

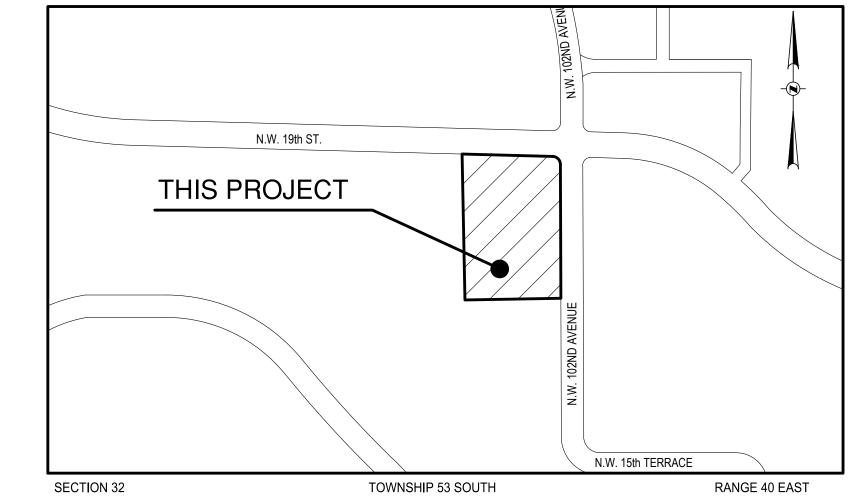

LOCATION SKETCH

SCALE: 1" 300' FOLIO No.: 35-3032-034-0020

LEGAL DESCRIPTION

LAND DESCRIPTION:

EXIST. 12" WHITE

EXIST. 12" WHITE \mathcal{I}

LEXIST. 12" WHITE 7

EXIST. 24" WHITE

— EXIST. (2) 6" YELLOW

← PROP. CONC. SIDEWALK

✓ PROP.〈TYPE "D" CURB

ACCESSIBLE

PROP, PEDESTRIAN

PROP. CR-C SDK. CURB RAMP (PER FY STANDARD PLANS 2021-22 INDEX

YELLOW

F----

─ EXIST. 24" WHITE

TRACT 'B', "GREAT SPRINGS AT I.C.P.", ACCORDING TO THE PLAT THEREOF, AS RECORDED IN PLAT BOOK 158, PG. 94, OF THE PUBLIC RECORDS OF MIAMI/DADE COUNTY, FLORIDA. SECTION 32, TOWNSHIP 53 SOUTH, RANGE 40 EAST, LESS THE WEST 455.34 FEET THEREOF.

GENERAL NOTES

I.C.P.", P.B. 158, PG. 95, M/D.C.R. SAID LINE BEARS N89°38'52"E.

ASSOCIATES, INC. DAVIE, FLORIDA, DATED OCTOBER 01, 2022.

PRODUCT ARE THE RESPONSIBILITY OF THE GENERAL CONTRACTOR.

- 1. ELEVATIONS SHOWN HEREON ARE BASED ON THE NATIONAL GEODETIC VERTICAL DATUM OF 1929 (NGVD29). BASED ON BENCHMARK BEARINGS SHOWN HEREON ARE BASED ON THE NORTH LINE OF "GREAT SPRINGS AT
- 2. HORIZONTAL AND VERTICAL CONTROL SHALL BE PROVIDED BY THE OWNER'S SURVEYOR. LAYOUT IS THE RESPONSIBILITY OF THE CONTRACTOR.
- 3. IT IS THE INTENT OF THESE DRAWINGS TO BE IN ACCORDANCE WITH APPLICABLE CODES AND AUTHORITIES HAVING JURISDICTION. ANY DISCREPANCIES BETWEEN THESE DRAWINGS AND APPLICABLE CODES SHALL BE IMMEDIATELY BROUGHT TO THE ATTENTION OF THE ENGINEER.
- 4. EXISTING UTILITIES SHOWN ARE BASED ON INFORMATION SUPPLIED BY OTHERS. IT SHALL BE THE CONTRACTOR'S RESPONSIBILITY TO MEET WITH ALL APPLICABLE UTILITY COMPANIES TO VERIFY ALL UNDERGROUND FACILITIES PRIOR TO THE START OF CONSTRUCTION. ALL TRENCH EXCAVATION SHALL PROCEED WITH EXTREME CAUTION AT ALL TIMES. IN THE EVENT THAT EXISTING UTILITIES ARE DAMAGED, IT
- 5. EXISTING GRADES WERE TAKEN FROM THE BEST AVAILABLE DATA AND MAY NOT ACCURATELY REFLECT PRESENT CONDITIONS. CONTRACTOR SHALL BE RESPONSIBLE FOR FAMILIARIZING HIMSELF WITH CURRENT SITE CONDITIONS, AND SHALL REPORT ANY DISCREPANCIES TO THE ENGINEER PRIOR TO STARTING WORK.
- 6. CONTRACTOR SHALL BE RESPONSIBLE FOR RESETTING ALL DISTURBED EXISTING MANHOLE COVERS, VALVE BOXES, BLOW-OFF RISERS, ETC. TO NEW ELEVATIONS, AS REQUIRED, WHETHER SPECIFICALLY SHOWN ON DRAWINGS OR NOT.

SHALL BE THE RESPONSIBILITY OF THE CONTRACTOR TO REPAIR OR REPLACE ALL SUCH DAMAGE.

- 7. PROPERTY SHOWN HEREON FALLS WITHIN FEDERAL FLOOD ZONE X & FEDERAL FLOOD HAZARD ZONE AH-8 PER F.I.R.M. COMMUNITY PANEL NO. 120041 0286 L OF MAP, DATED SEPT. 11,
- 8. BOUNDARY AND TOPOGRAPHIC DATA BASED UPON SURVEY PREPARED BYCOUSINS SURVEYORS &

ADA COMPLIANCE NOTES

1. THIS SET OF DOCUMENTS HAS BEEN DESIGNED TO COMPLY WITH FBC 7TH EDITION (2020) AND THE 2012 FLORIDA ACCESSIBILITY CODE FOR BUILDING CONSTRUCTION AND PER APPLICABLE FDOT INDEXES 304, 310 & 515. ALL RELATED SECTIONS OF THE CODE ARE NOTED WITHIN THESE DOCUMENTS AND STRICT COMPLIANCE IS REQUIRED BY ALL CONSTRUCTION TRADES. CONSTRUCTION QUALITY AND COMPLIANCE OF THE FINAL

- 2. ALL ACCESSIBLE ROUTES MUST NOT EXCEED A SLOPE OF 1:20 (5.00%). CURB CUT RAMPS AND RAMPS MUST NOT EXCEED A SLOPE OF 1:12 (8.33%). RAMPS THAT EXCEED 6 FEET IN LENGTH REQUIRE HANDRAILS. ALL CROSS SLOPES MUST NOT EXCEED A SLOPE OF 1:50 (2.00%). RAMPS MUST ALSO COMPLY WITH FBC BUILDING 1010 AND FBC ACCESSIBILITY 405.
- 3. PLANTERS, TREE GRATES AND OTHER ELEMENTS MUST BE FLUSH AND ADA COMPLIANT. PAVERS ON PEDESTRIAN PATH MUST BE FLUSH, FIRM, STABLE AND HAVE NO OPEN JOINTS.
- 4. ALL DETECTABLE WARNINGS TO BE IN ACCORDANCE WITH MIAMI-DADE COUNTY ARTICLE 527 TESTED MATERIAL, TYPE & COLOR, LATEST EDITION (7/7/16).

STRIPING AND SIGNAGE NOTES

- ALL STRIPING IN RIGHT-OF-WAY AND ALL ON-SITE STOP BARS APPLIED TO ASPHALTIC PAVEMENT SHALL BE THERMOPLASTIC WITH A MIXTURE OF 50 PERCENT GLASS SPHERES AND 50 PERCENT SHARP SILICA SAND APPLIED AT A RATE OF 0.20 PSF IN ACCORDANCE
- WITH FDOT SECTION 711. 2. ALL ON-SITE STRIPING APPLIED TO CONCRETE PAVEMENT SHALL BE TRAFFIC PAINT IN ACCORDANCE WITH FDOT SECTION 917.
- 3. ALL SIGNAGE SHALL BE IN ACCORDANCE WITH "THE MANUAL ON UNIFORM TRAFFIC CONTROL DEVICES", LATEST EDITION.
- 4. SIGN POSTS SHALL BE STEEL CHANNEL IN ACCORDANCE WITH MIAMI-DADE COUNTY/CITY OF MIAMI PUBLIC WORKS DEPARTMENT STANDARDS AND SHALL BE BREAK-A-WAY.
- 5. STOP SIGNS SHALL BE MOUNTED WITH 7' CLEAR FROM SIGN BOTTOM TO GRADE. WHERE INDICATED, ADDITIONAL SIGNAGE SHALL BE MOUNTED BELOW STOP SIGN.
- 6. PROVIDE REFLECTIVE PAVEMENT MARKERS, AS REQUIRED BY MIAMI-DADE COUNTY/CITY OF MIAMI PUBLIC WORKS DEPARTMENTS.

INDEX OF DRAWINGS

DESCRIPTION LAYOUT PLAN AND NOTES PEDESTRIAN WALKWAY CONNECTIVITY PLAN PAVING-GRADING-DRAINAGE-WATER-SEWER PLAN AND NOTES FIRE TRUCK PATH PLAN SITE AND DRAINAGE DETAILS

STORMWATER POLLUTION PREVENTION PLAN AND NOTES

SIGN LEGEND

R1-1 30" X 30" STOP SIGN R3-5(R) 30" X 36" RIGHT TURN ONLY SIGN

TOTAL SITE AREA = 56,951 SF (1.30 AC) TOTAL IMPERVIOUS AREA = 33,669 SF (0.77 AC) (59.23%) TOTAL OPEN SPACE = 8,708 SF (0.20 AC) (15.38%) TOTAL BUILDING AREA (GROUND) = 14,574 SF (0.33 AC) (25.38%) PARKING PROVIDED = 81 SPACES TOTAL VEHICULAR AREA = 33,669 SF (0.77 AC) 20% OF VEHICULAR AREA = 6,734 SF (CONCRETE/PAVERS/OTHER) HAVING A SOLAR REFLECTIVE INDEX (SRI) OF 28 OR GREATER



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CERTIFICATE OF AUTHORIZATION NO. 4270

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FOR THE FIRM: NELSON H. ORTIZ PE-57556

AND THE SIGNATURE MUST BE VERIFIED

ON ANY ELECTRONIC COPIES.

PROJECT TITLE:

10234 NW 19 STREET DORAL, FLORIDA Folio No.

HYATT HOUSE

BAYWOOD HOTEL 3785 N.W. 82nd AVENUE, SUITE 204 MIAMI, FLORIDA 33166

NO. DATE 1 02-05-2024 ADDRESS CITY COMMENTS

PROJECT INFORMATION: PROJECT NUMBER: 2023-7020

09-21-2023 CHECKED BY: N.H.O. AS SHOWN

SHEET TITLE:

LAYOUT PLAN AND NOTES

EXIST. 6" YELLOW (T) (TYP.)

A PORTION OF TRACT "B"

"GREAT SPRINGS AT I.C.P." PB 158, PG. 94, M/D.C.R.

===

CONCRETE WALK

CONCRETE WALK

TRACT "A"

"GREAT SPRINGS AT I.C.P."

PB 158, PG. 94, M/D.C.R.

NW 19TH STREET

RESIDENCE INN

EXIST. 6 - STORY

BUILDING

EXIST. 6" WHITE 10'/30' (SKIP) (TYP.) —

EXIST. MONUMENT SIGN ———

(TO BE REMOVED) -

PROP. (2) 6" ———

PROP. LEASE

— EXIST. CURB

(TO BE REMOVED) -

— — — STOOP

(COORD. W/ ARCH DWG'S) -

A PORTION OF TRACT "B"

"GREAT SPRINGS AT I.C.P."

PB 158, PG. 94, M/D.C.R.

CONC HEADER

PROP. LEASE

حلك

====

PROP. LEASE

PROP. 24" WHITE

LAYOUT PLAN

CONC HEADER

LINE _____

====

PROP. TYPE "D" CURB 🕏

YELLOW (T) (TYP.)

EXIST. SIGN ——

EXIST. 6" WHITE 10'/30' (SKIP) (TYP.) —

PROP. ACCESSIBLE SIGN ____ EXIST. 6' CONC. SIDEWALK

└ PROP. ADA RAMP

PROP. ADA RAMP WITH ----DETECTABLE WARNING PER FDOT

FY 2021-22 INDEX 522-002, CR-H

PROP. BUILDING

(126 ROOMS)

D PROP. WHEEL -

└ PROP. TYPE "D"

CURB

10 SPA @ 9' = 90'

PROPERTY LINE —

- EXIST. R1-1 SIGN/ PROP.

EXIST. RPM (TYP.)

12' 6 SPA @ 9' = 54'

W/ 24"X12" WHITE (T)

PROP. CROSSWALK -

W/ 24"X12" WHITE (T)

AREA

∠ PROP. TYPE "D" CURB

LANDSCAPE

LANDSCAPE


MATCH EXIST. -

SIDEWALK

AND GUTTER

RECEIVED

By Stephanie Puglia at 9:56 am, Feb 21, 2024

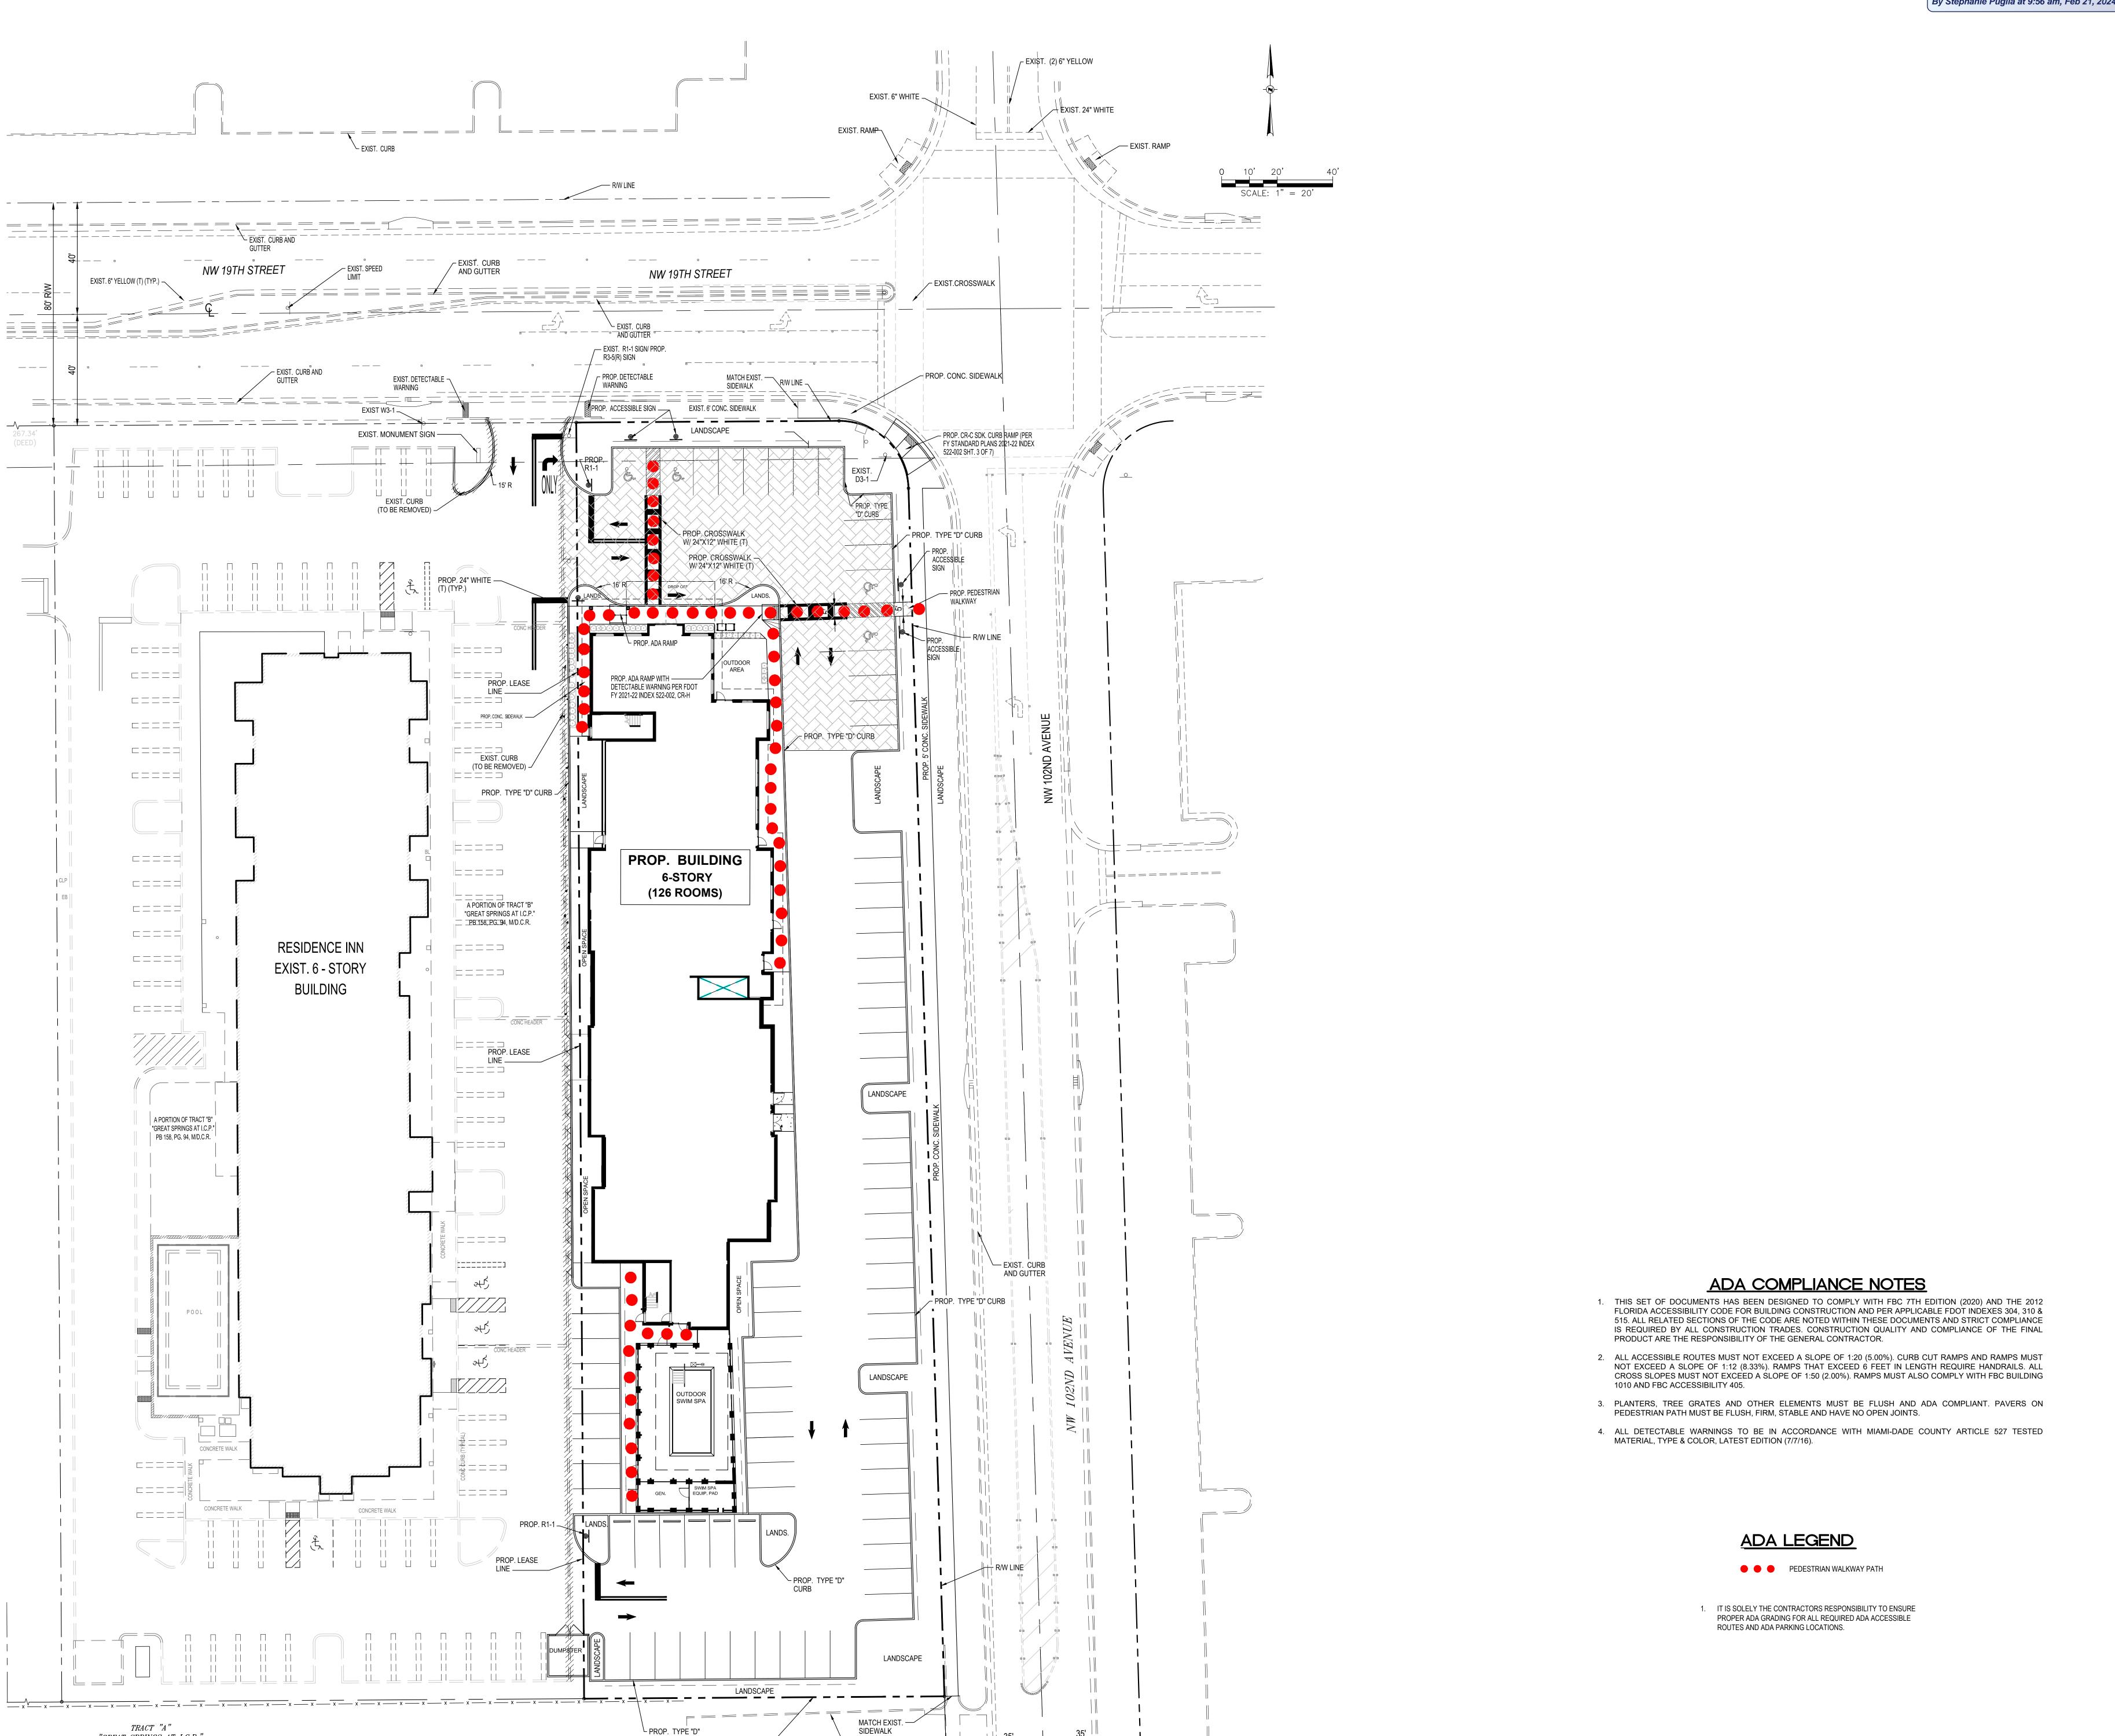

"GREAT SPRINGS AT I.C.P."

PB 158, PG. 94, M/D.C.R.

CURB

PEDESTRIAN WALKWAY CONNECTIVITY PLAN

PROPERTY LINE _


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FOR THE FIRM : PE-57556

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BAYWOOD HOTEL 3785 N.W. 82nd AVENUE, SUITE 204 MIAMI, FLORIDA 33166

NO. DATE

REVISIONS BY

PROJECT INFORMATION:

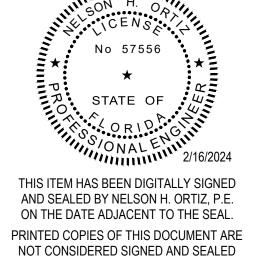PROJECT NUMBER: 2023-7020

DATE: 09-21-2023

DRAWN BY: ZH

CHECKED BY: T.G


APPROVED BY: N.H.O.

AS SHOWN

SHEET TITLE:

PEDESTRIAN WALKWAY CONNECTIVITY PLAN AND NOTES

SHEET NUMBER:

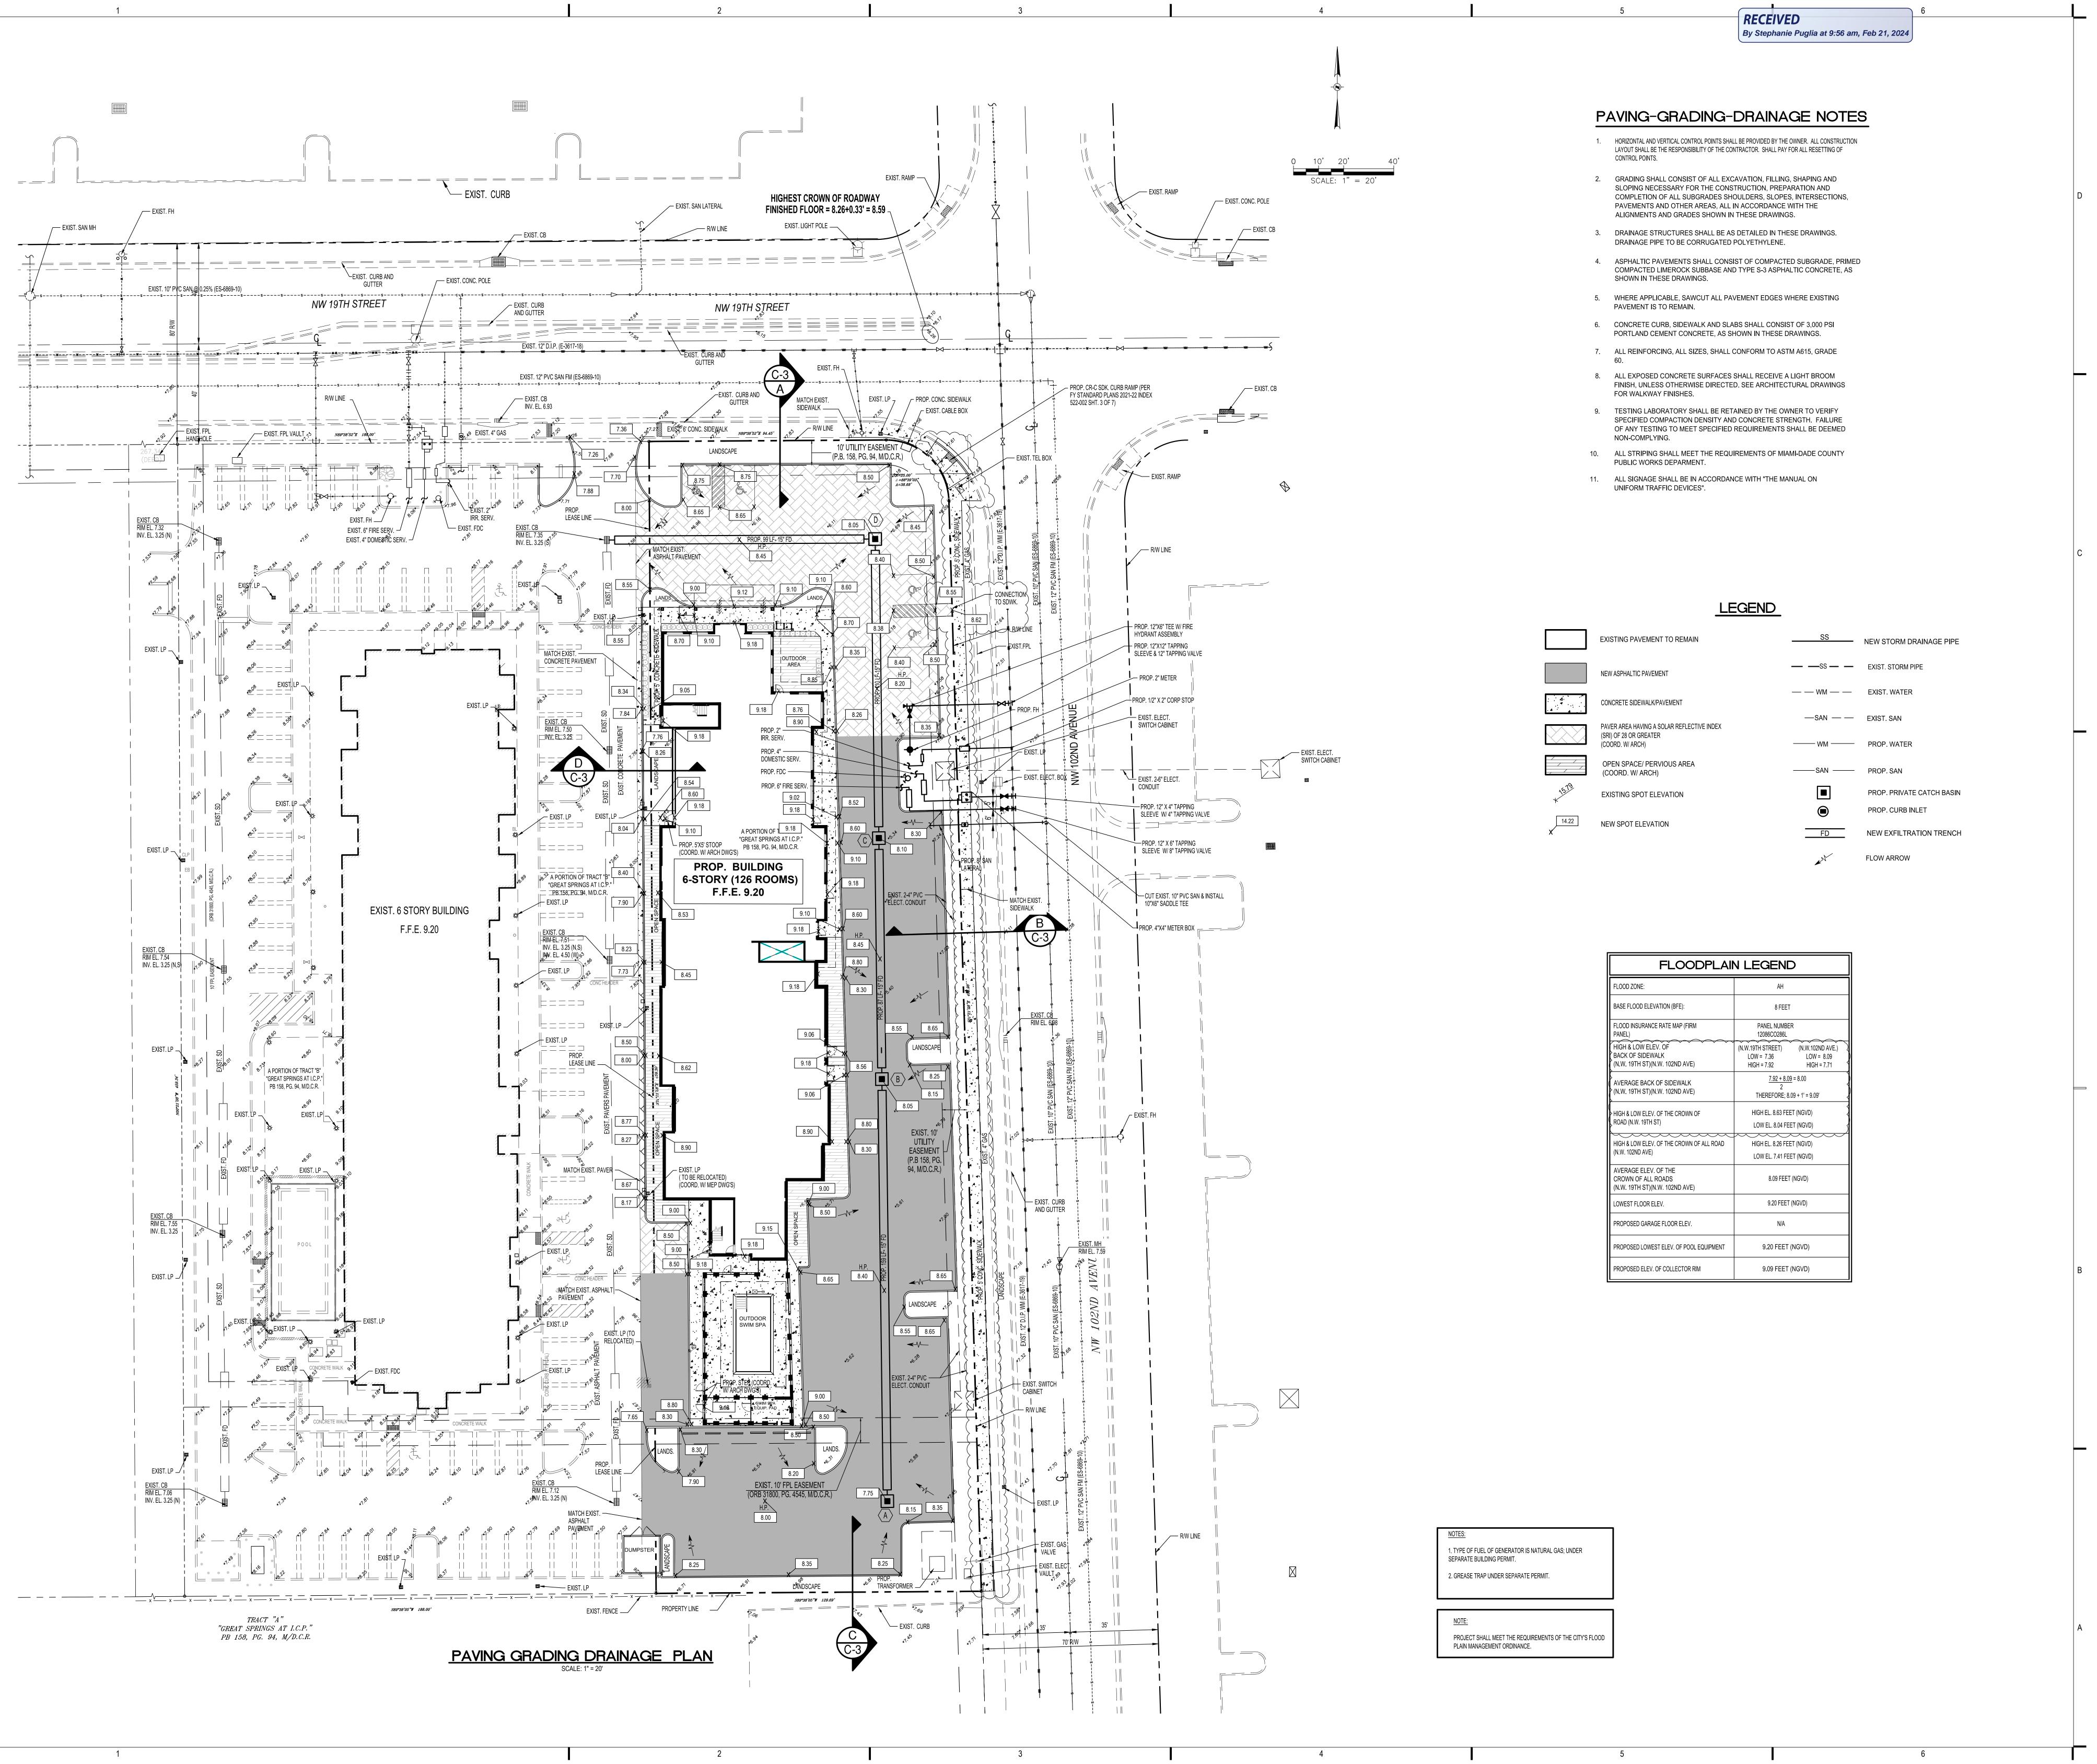



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SEAL / SIGNATURE:

SEAL / SIGNATURE:

No 57556

*

No 57556

*

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OR 1 D

2/16/2024

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PE-57556 (CIVIL)

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PROJECT TITLE:

HYATT HOUSE 10234 NW 19 STREET DORAL, FLORIDA Folio No.

BAYWOOD HOTEL 3785 N.W. 82nd AVENUE, SUITE 204 MIAMI, FLORIDA 33166

NO. DATE REVISIONS BY

1 02-05-2024 ADDRESS CITY COMMENTS

PROJECT INFORM

PROJECT NUMBER: 2023-7020

DATE: 09-21-2023

DRAWN BY: ZH

CHECKED BY: T.G


ECKED BY: T.G
PROVED BY: N.H.O.
ALE: AS SHOWN


SHEET TITLE:

PAVING-GRADING-DRAINAGE PLAN

SHEET NUMBER:

;-2

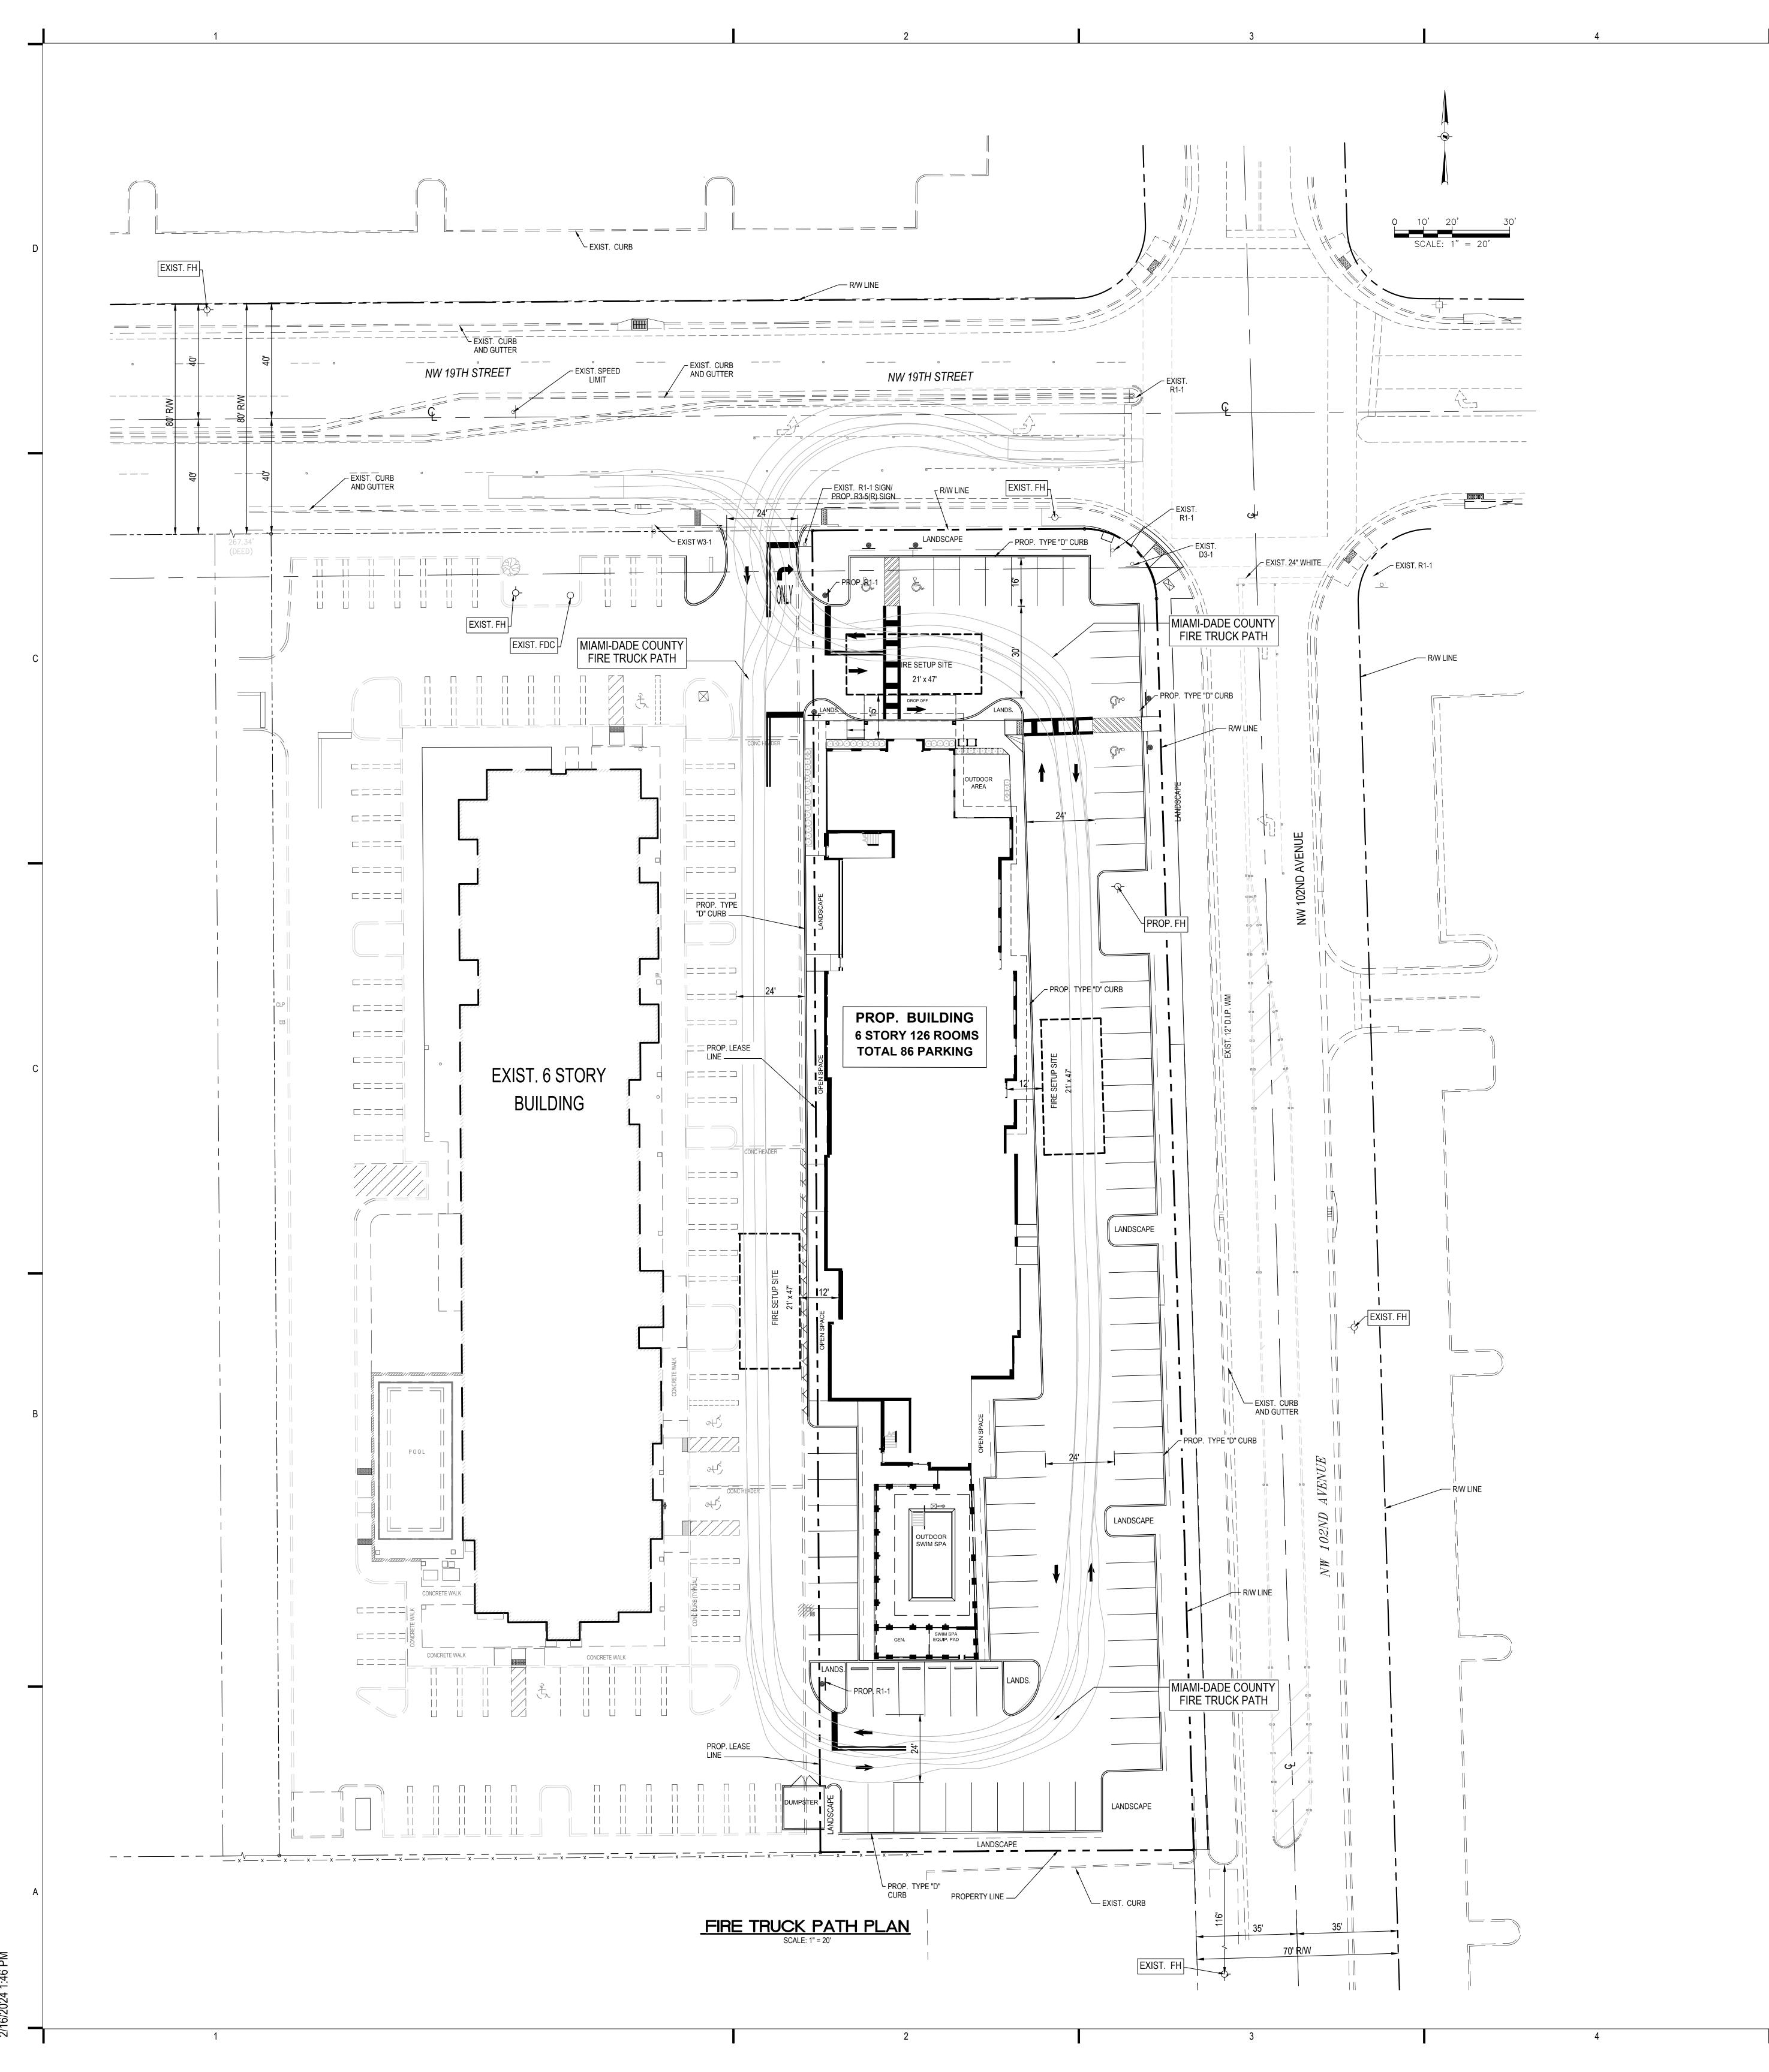

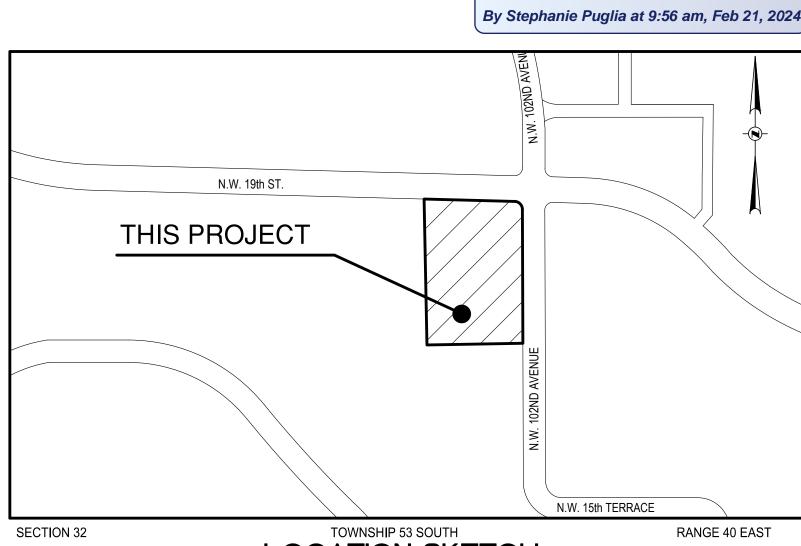


LOCATION SKETCH
SCALE: 1" 300'

FOLIO No.: 35-3032-034-0020


LEGAL DESCRIPTION


LAND DESCRIPTION:

TRACT 'B', "GREAT SPRINGS AT I.C.P.", ACCORDING TO THE PLAT THEREOF, AS RECORDED IN PLAT BOOK 158, PG. 94, OF THE PUBLIC RECORDS OF MIAMI/DADE COUNTY, FLORIDA. SECTION 32, TOWNSHIP 53 SOUTH, RANGE 40 EAST, LESS THE WEST 455.34 FEET THEREOF.

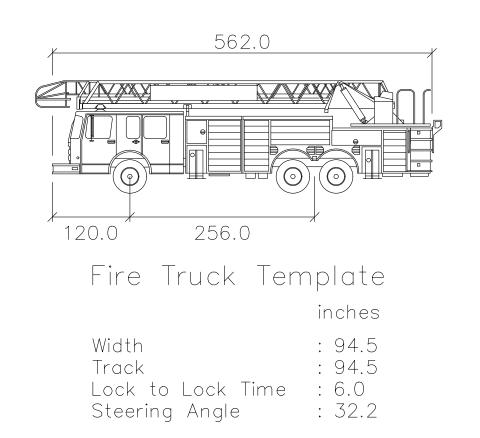

MIAMI-DADE FIRE TRUCK PROFILE N.T.S.

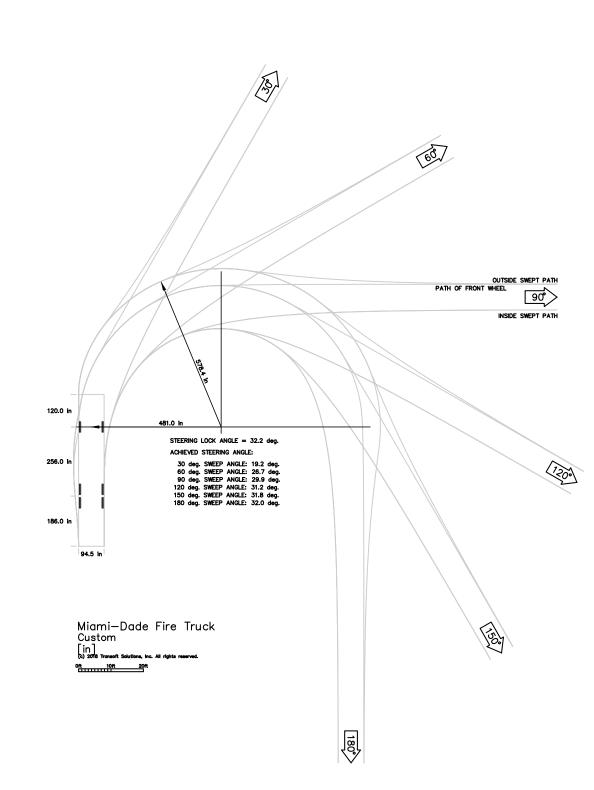

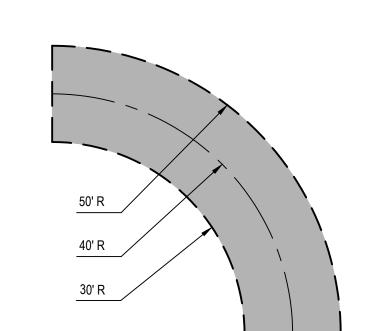

FIRE TRUCK PATH DETAIL



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305 / 279 4553 fax
www.graef-usa.com

CERTIFICATE OF AUTHORIZATION NO. 4270

SEAL / SIGNATURE

SEAL / SIGNATURE

No 57556

STATE OF

ORIDAGE

2/16/2024

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FOR THE FIRM : PE-57556

Folio No.

PROJECT TITLI

HYATT HOUSE 10234 NW 19 STREET DORAL, FLORIDA

BAYWOOD HOTEL 3785 N.W. 82nd AVENUE, SUITE 204 MIAMI, FLORIDA 33166

NO. DATE REVISIONS BY

PROJECT INFORMATION:

PROJECT NUMBER: 2023-7020

DATE: 09-21-2023

DRAWN BY: ZH

CHECKED BY: T.G


SHEET TITLE:

AS SHOWN

FIRE TRUCK PATH PLAN

SHEET NUMB

C-3

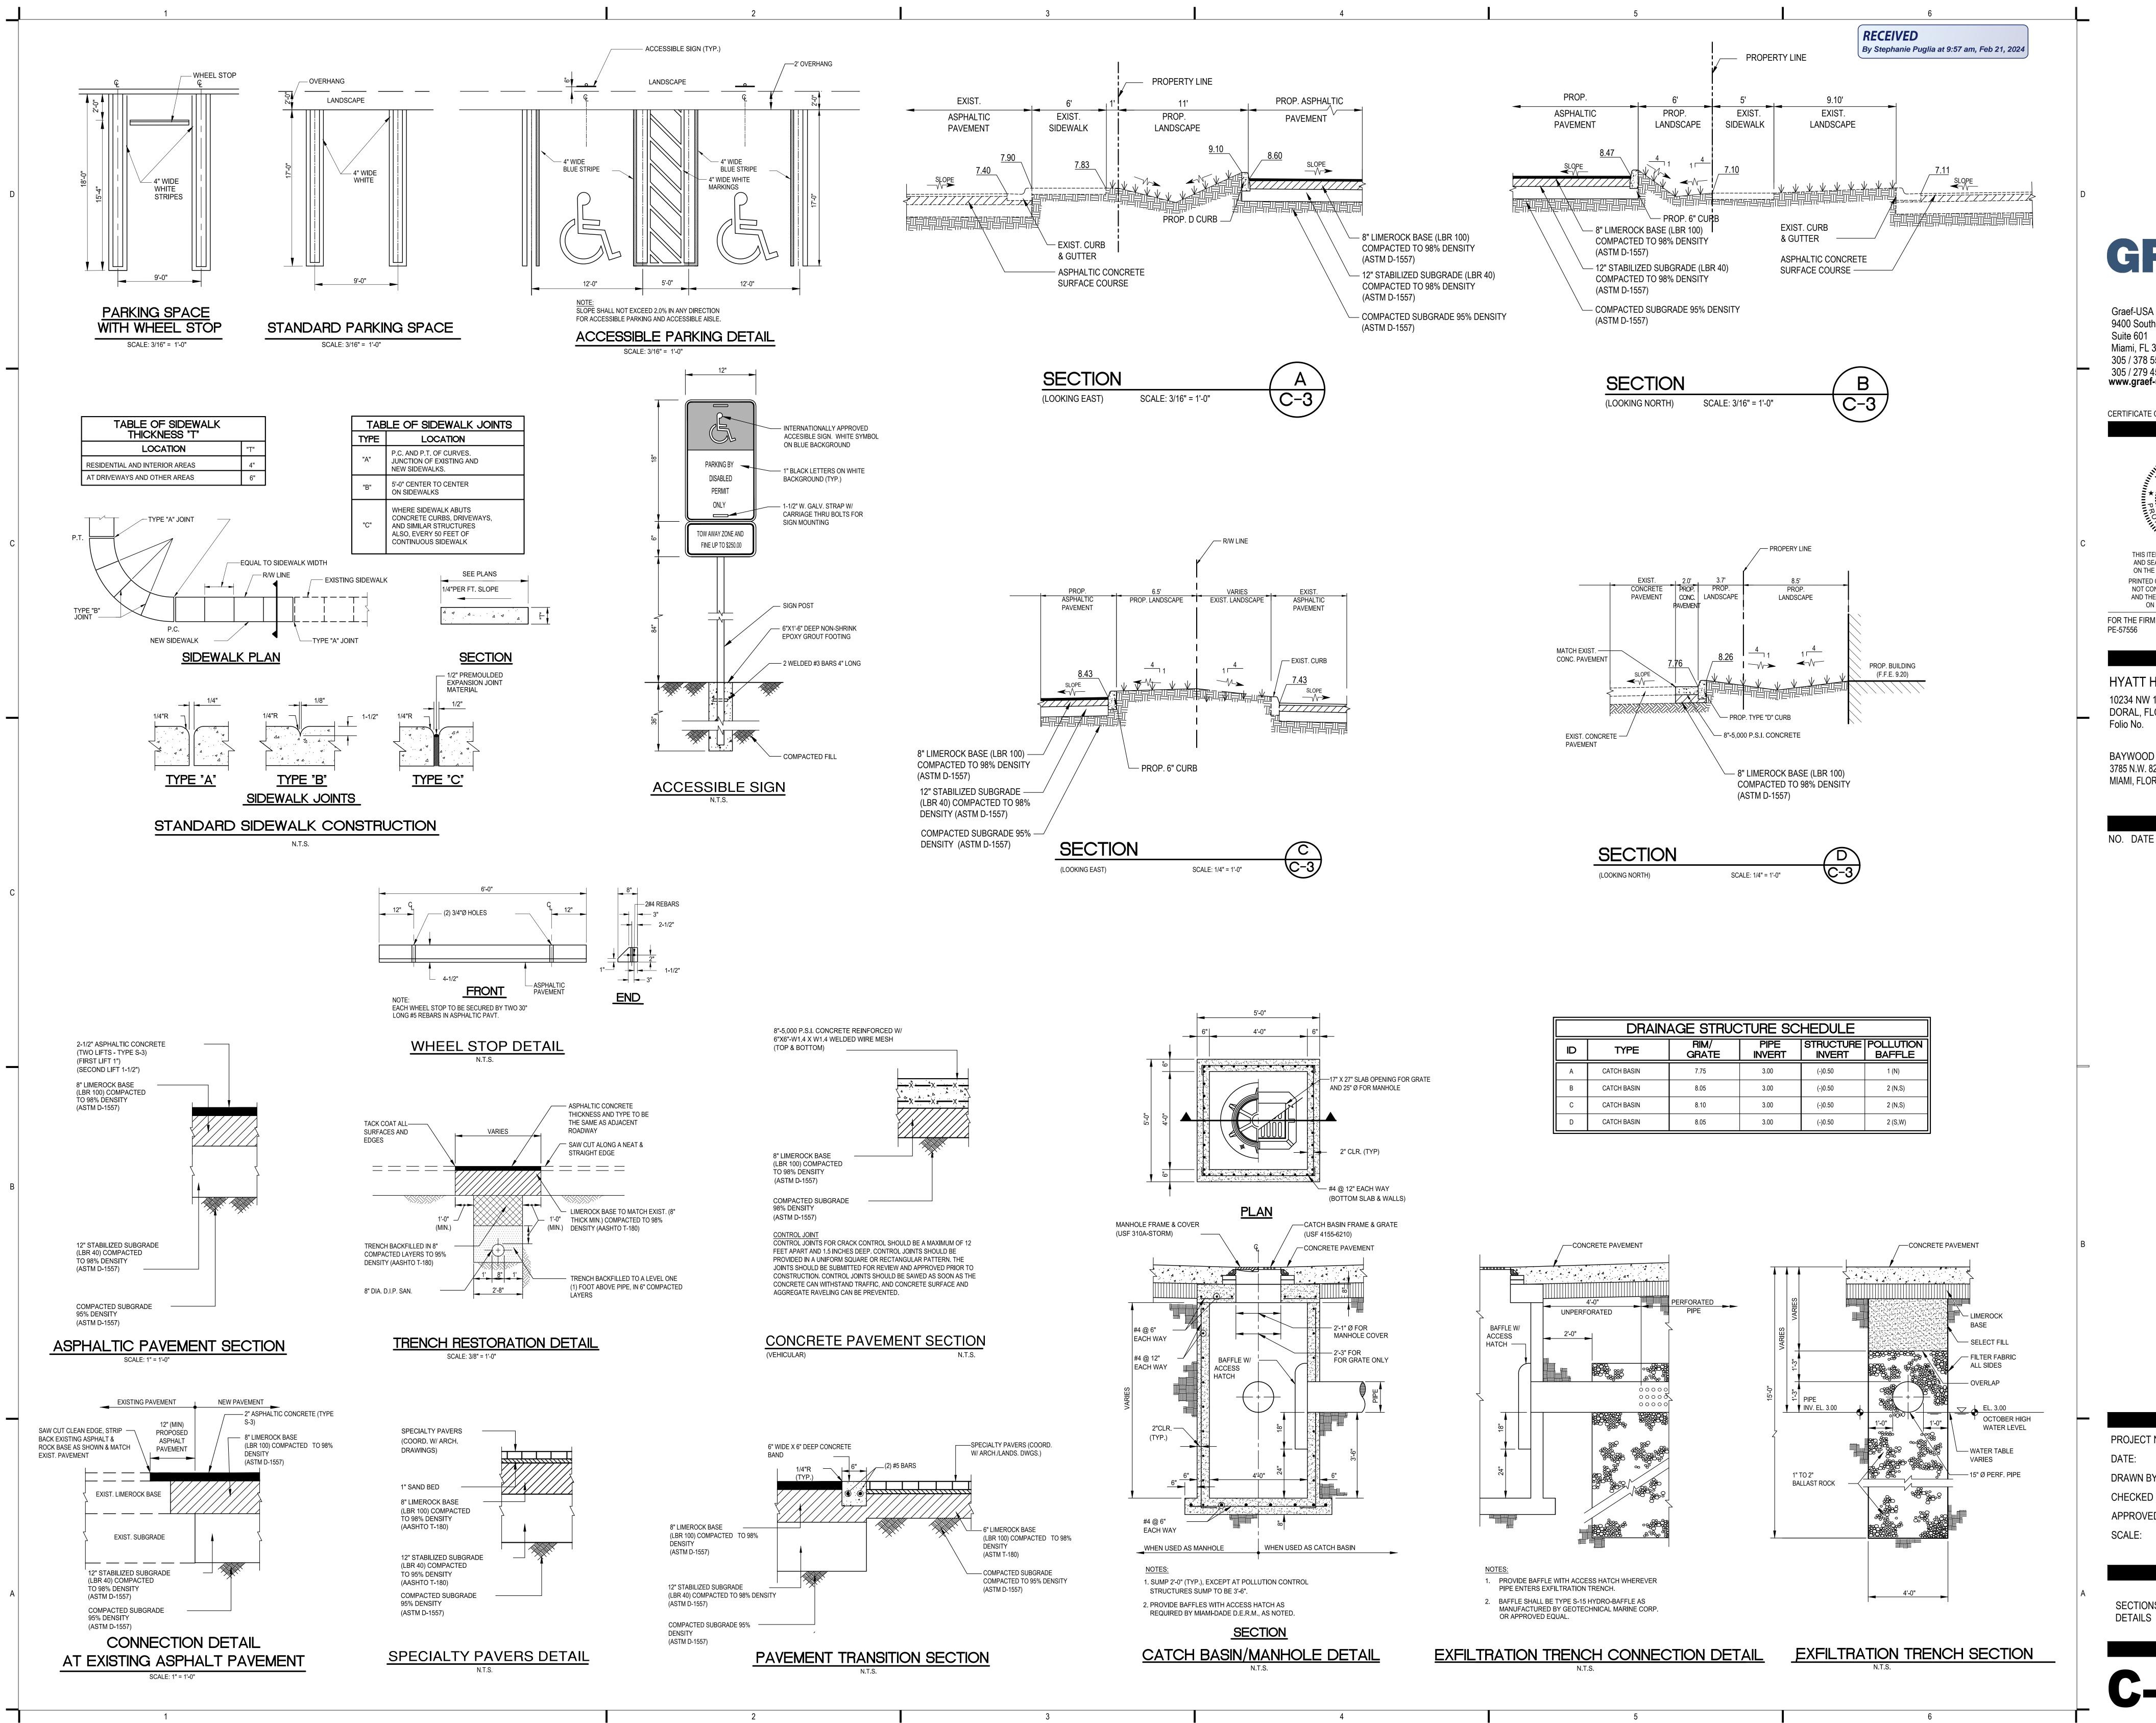

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NELSON H. ORTIZ

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PROJECT TITLE: **HYATT HOUSE**


10234 NW 19 STREET DORAL, FLORIDA Folio No.

BAYWOOD HOTEL 3785 N.W. 82nd AVENUE, SUITE 204 MIAMI, FLORIDA 33166

NO. DATE REVISIONS BY


PROJECT INFORMATION: PROJECT NUMBER: 2023-7020 09-21-2023 CHECKED BY: AS SHOWN


SHEET TITLE: SECTIONS, SITE AND DRAINAGE

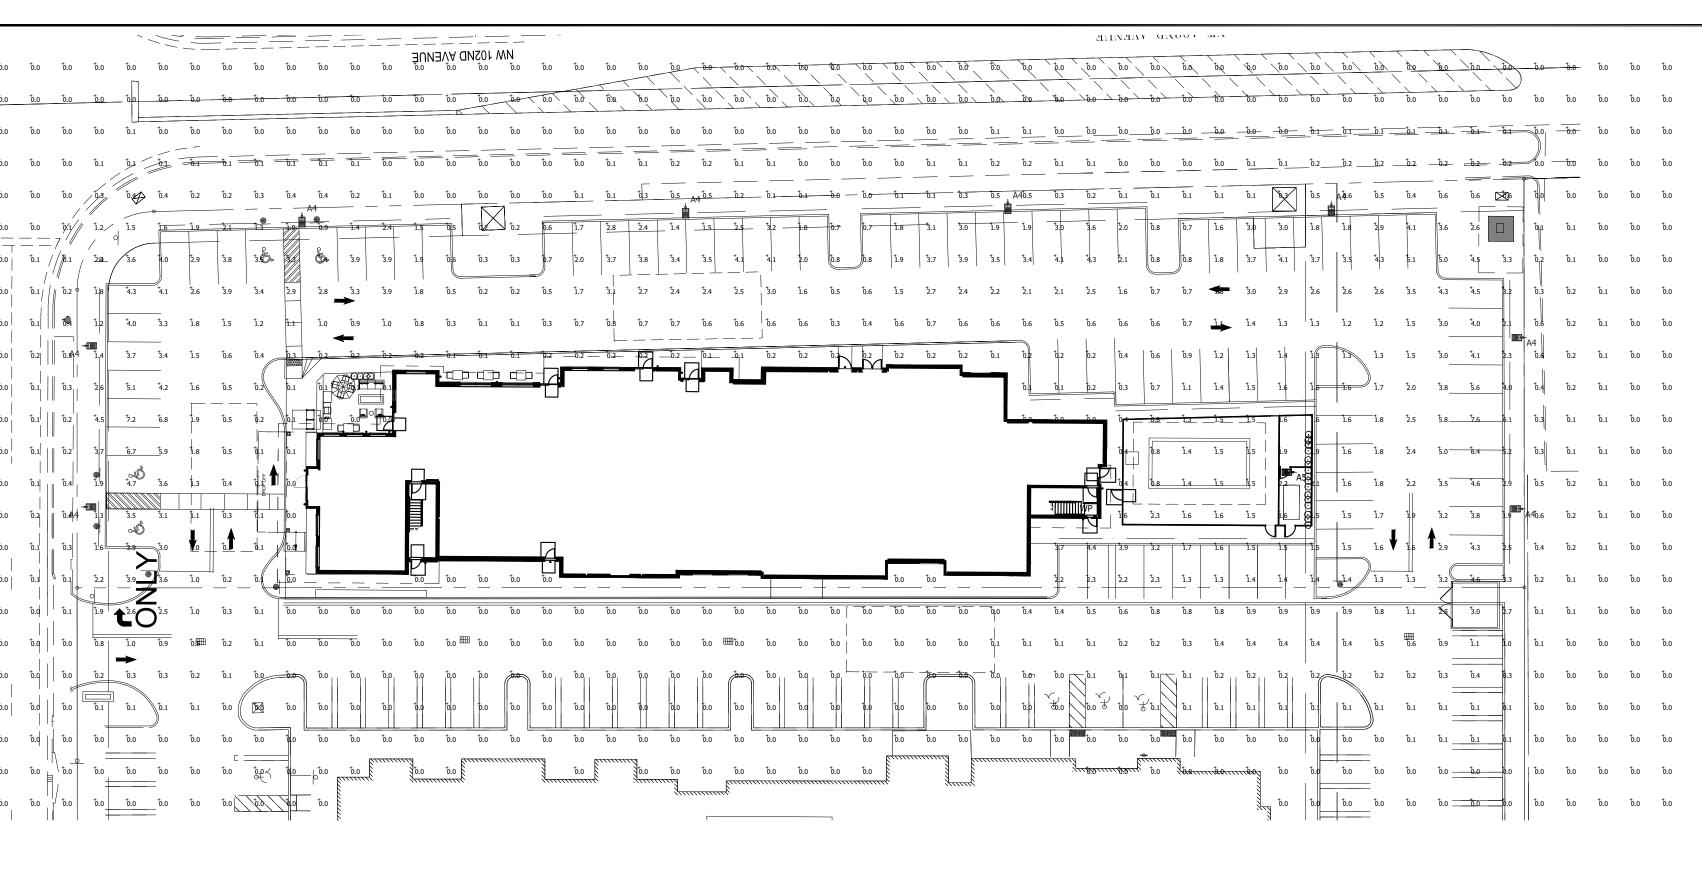

Luminaire Schedule								
Symbol Qty Label Mounting Height LLF Lum. Lumens Lum. Watts Description								
	8	A4	20' - 0" AFG	0.900	8922	115	VP-1-160L-115-3K7-4W-BC	
	1	A5	20' - 0" AFG	0.900	14563	115	VP-1-160L-115-3K7-5QW	
→	1	WP	10' - 0" AFG	0.900	4483	35	RWL1-48L-35-3K7-4W-U	

Calculation Summary							
Label	CalcType	Units	Avg	Max	Min	Avg/Min	Max/Min
Overall Area	Illuminance	Fc	0.47	7.6	0.0	N.A.	N.A.
Parking Area	Illuminance	Fc	2.09	7.6	0.1	20.90	76.00

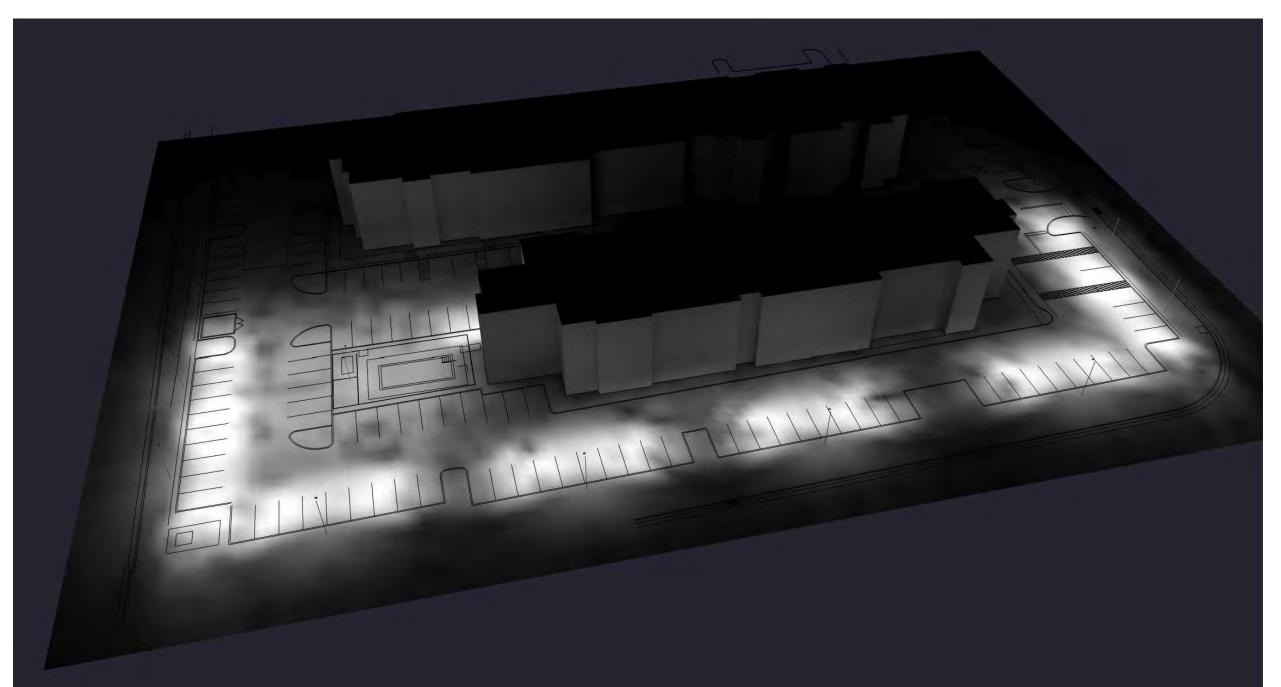

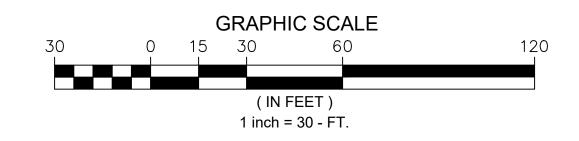



- THIS LIGHTING DESIGN IS BASED ON LIMITED INFORMATION SUPPLIED BY OTHERS TO CURRENT. SITE DETAILS PROVIDED HEREON ARE REPRODUCED ONLY AS A VISUALIZATION AID. FIELD DEVIATIONS MAY SIGNIFICANTLY AFFECT PREDICTED PERFORMANCE. PRIOR TO INSTALLATION, CRITICAL SITE INFORMATION (POLE LOCATIONS, ORIENTATION, MOUNTING HEIGHT, ETC.) SHOULD BE COORDINATED WITH THE CONTRACTOR AND/OR SPECIFIER RESPONSIBLE FOR THE PROJECT.
- LUMINAIRE DATA IS TESTED TO INDUSTRY STANDARDS UNDER LABORATORY CONDITIONS. OPERATING VOLTAGE AND NORMAL MANUFACTURING TOLERANCES OF LAMP, BALLAST, AND LUMINAIRE MAY AFFECT FIELD RESULTS.

S. CONFORMANCE TO FACILITY CODE AND OTHER LOCAL REQUIREMENTS IS THE RESPONSIBILITY OF THE OWNER AND/OR THE OWNER'S REPRESENTATIVE.

HYATT HOUSE DORAL, FL SITE PHOTOMETRIC PLAN

REVISED FROM DR.	AWING NUMBER(S):		DN BY:	DATE: 11/29/23	CHK BY:
			DHK	11/29/23	N/A
		Current @	REV. BY:	DATE:	SCALE: AS NOTED
			QUOTE: N/A	A2322	

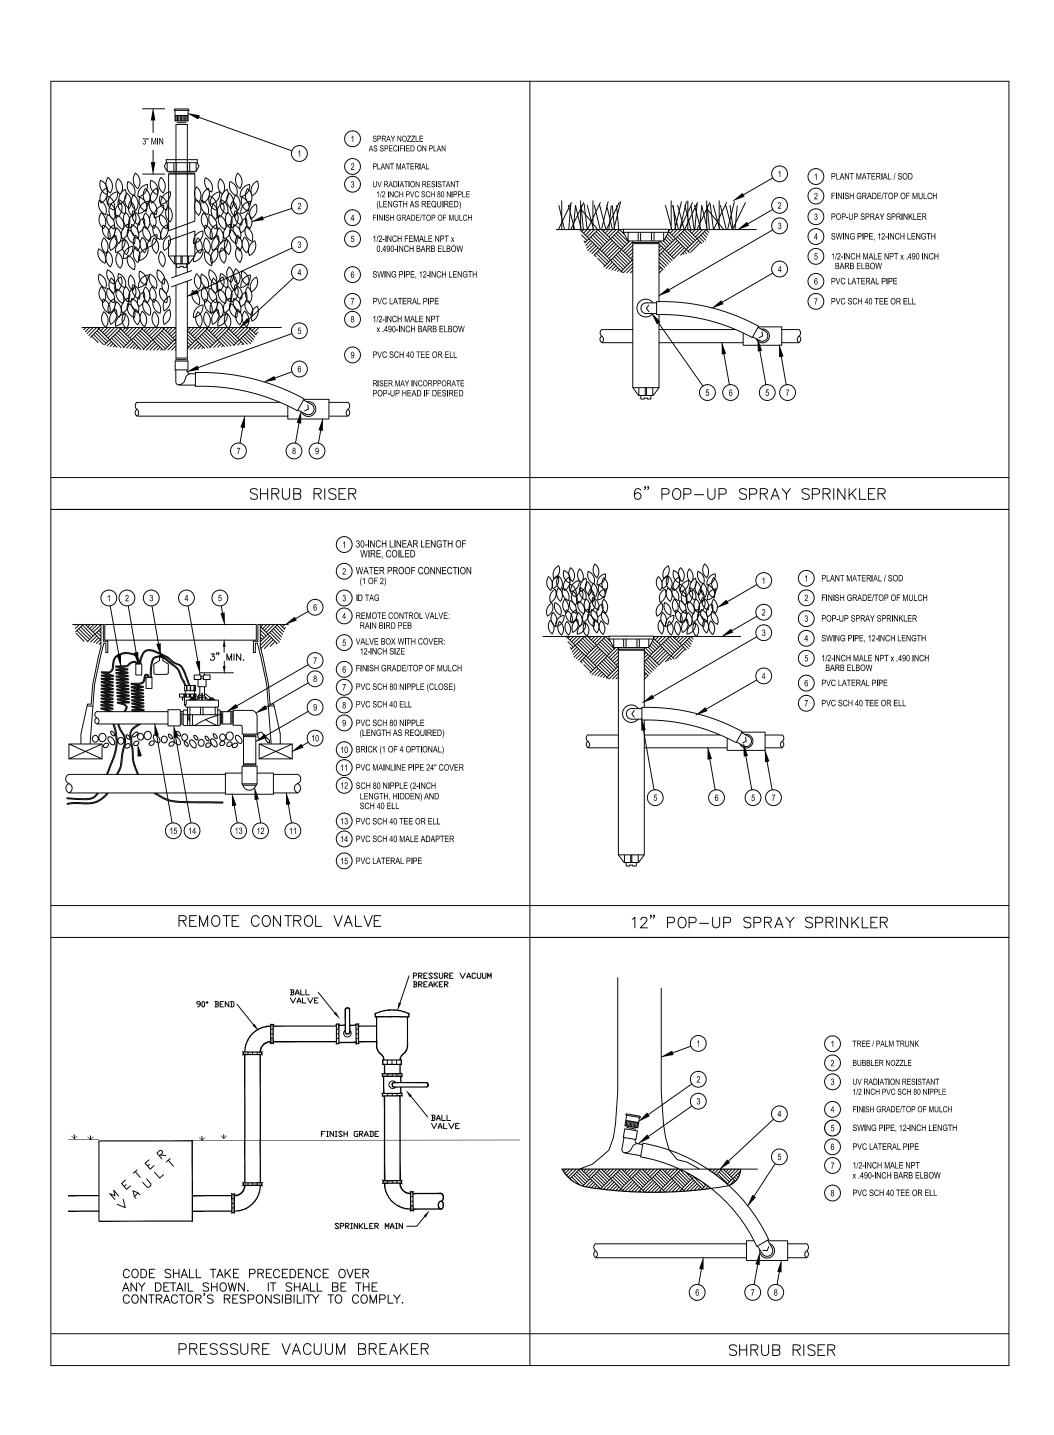

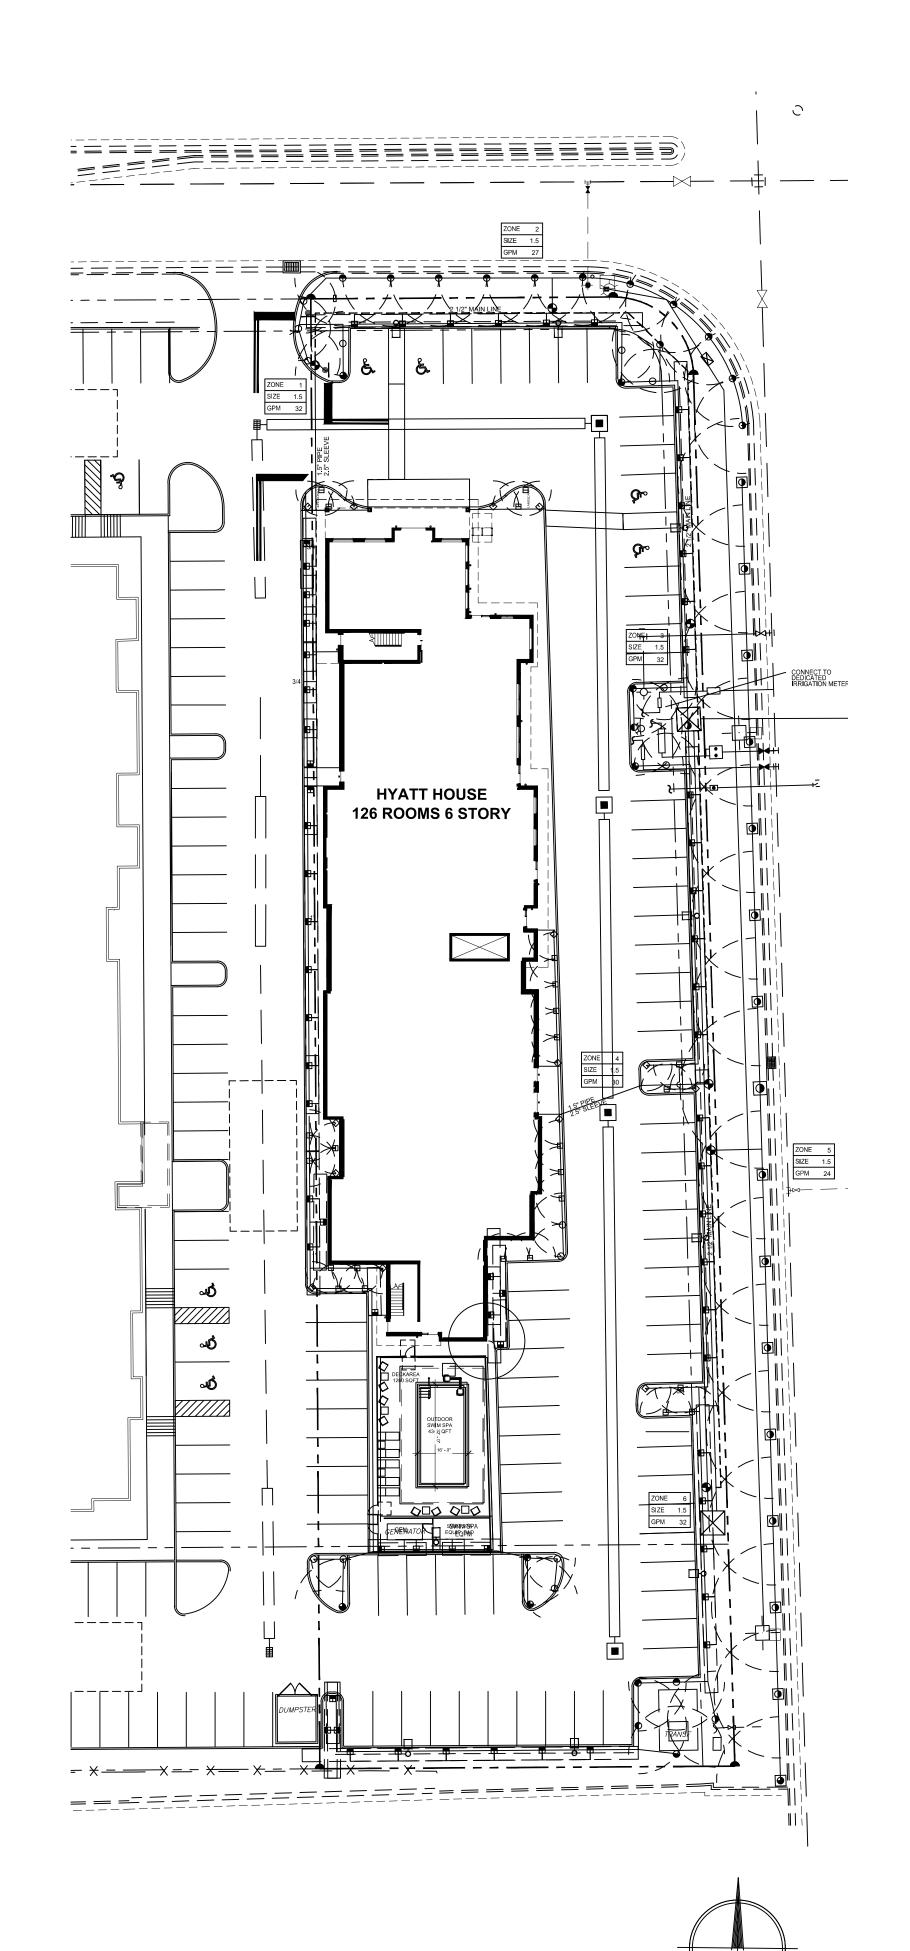

IRRIGATION LEGEND

ROTOR HEADS

5000 SERIES 6" ADJUSTABLE POP-UP ROTOR HEAD EQUAL TO RAINBIRD

PGP 6" POP-UP 20-25'R ROTOR HEAD EQUAL TO RAINBIRD

6" POP-UP MIST HEAD EQUAL TO RAINBIRD WITH THE FOLLOWING NOZZLES: (12" POP-UPS TO BE USED IN GROUNDCOVER BEDS) O O O 15' SERIES NOZZLE.

12' SERIES NOZZLE. ⊕ ⊕ ⊖ ⊕ 10' SERIES NOZZLE. ⊞ ⊞ ⊞ ⊠ 8' SERIES NOZZLE.

☐ 15EST

SHRUB SPRAY

BUBBLER NOZZLES

BUBBLER NOZZLE AS FOLLOWS:

1502-SBH 5 GPM

VALVES

ELECTRONIC ZONE VALVE EQUAL TO IRRITROL, SIZE AS NOTED ON PLAN, IN AMETEK OR CARSON 12"x18" VALVE BOX

AMES BRASS GATE VALVE, SAME SIZE AS MAIN LINE, IN 6" SCH 40 PVC COLLAR EXTENSION AND VALVE BOX.

PROGRAMMABLE IRRIGATION CONTROLLER EQUAL TO HUNTER ACC CONTROLLER - PROVIDE RAIN SENSOR (ET SENSOR - OPTIONAL)

SLEEVES: SCH 40 PVC OR RATED EQUAL CLASS. SLEEVES

2 1/2" MAIN LINE: SCH 40 PVC WITH SCH 80 PVC FITTINGS

IRRIGATION NOTES

- FUNCTION PROPERLY. ALL IRRIGATION SHALL BE INSTALLED IN ACCORDANCE WITH MANUFACTURER'S SPECIFICATIONS AND ALSO STATE AND/OR LOCAL CODES.
- 2. IRRIGATION PLANS ARE SCHEMATIC AND DRAWN FOR GRAPHIC CLARITY. ALL PIPING BELOW PAVEMENT SHALL BE SLEEVED. LAYOUT OF IRRIGATION SYSTEM SHALL BE COORDINATED WITH CORRESPONDING LANDSCAPE PLAN.
- 3. THE CONTRACTOR SHALL BE RESPONSIBLE FOR CONTACTING LOCAL UNDERGROUND UTILITY PROVIDERS TO VERIFY LOCATIONS. THE CONTRACTOR IS ENCOURAGED TO VISIT THE SITE PRIOR TO INSTALLATION AND BECOME FAMILIAR WITH EXISTING CONDITIONS.
- 4. VALVE LOCATIONS ARE SCHEMATIC ONLY AND WILL BE ADJUSTED FOR SITE CONDITIONS, EACH VALVE SHALL BE INSTALLED IN A AMETEK OR CARSON VALVE BOX. THE FLOW ADJUSTMENT FEATURE WILL BE USED TO BALANCE PRESSURE THROUGHOUT THE SYSTEM.
- 5. PIPING SHALL BE SIZED TO MINIMIZE FRICTION LOSS AND MAINTAIN FLOW VELOCITY BELOW 5 FPS. 6. THE IRRIGATION CONTROLLER SHALL BE INSTALLED IN ACCORDANCE WITH LOCAL CODES AND
- MANUFACTURER'S RECOMMENDATIONS, PROPER GROUNDING EQUIPMENT AND SURGE PROTECTION SHALL BE PROVIDED. A RAIN SENSOR SHALL BE INSTALLED TO OVER-RIDE THE CONTROLLER.
- 7. ALL NEW AND RELOCATED TREES AND PALMS TO RECEIVE BUBBLERS. 8. SPRINKLER LOCATIONS ADJACENT TO PAVEMENT, STRUCTURES, FENCES, ETC. SHALL BE OFFSET AS FOLLOWS: 12" MIN FOR POP-UP MIST HEADS, 18" FOR SHRUB RISERS, 18" FOR ROTOR HEADS, AND TYPICALLY 5 FEET FOR ROTORS ALONG UNCURBED ROADWAYS.
- 9. ALL SLEEVING SHALL BE SCH 40 PVC TO SIZE INDICATED ON PLAN, OR IF NOT INDICATED, A MIN. OF 2 PIPE SIZES LARGER THAN SUPPLY LINE CONTAINED. ALL SLEEVES SHALL BE INSTALLED A MIN.
- OF 24" BELOW FINISH GRADE. 10. CONTROL WIRES SHALL BE UL APPROVED PE IRRIGATION CONTROL WIRE. USE 14 GAGE CONTROL WIRE AND 12 GAGE GROUND WIRE, WIRE SHALL BE BUNDLED AND ATTACHED TO THE MAIN LINE IN TRENCH OR THROUGH WIRE SLEEVES AT PAVEMENT CROSSINGS 24" BELOW FIN. GRADE. ALL SPLICES SHALL BE MADE WITH WATERPROOF DIRECT-BURIAL SPLICE KITS AND CONTAINED IN VALVE BOXES. TWO EXTRA CONTROL
- WIRES SHALL BE INSTALLED TO THE FURTHEST VALVES IN EACH DIRECTION FROM THE CONTROLLER. 11. PIPING IN NARROW PLANTING AREAS, PARKING ISLANDS AND PLANTERS SHALL BE SET TO ONE SIDE TO ALLOW ROOM FOR ROOT BALLS. PIPE AS INDICATED ON PLAN IS SCHEMATIC AND SHOULD BE ADJUSTED FOR FIELD CONDITIONS.
- 12. ALL GLUE JOINTS SHALL BE CLEANED, SANDED, AND TREATED WITH A COLORED HIGH ETCH PRIMER AND JOINED USING A SOLVENT CONFORMING WITH ASTM D2564.
- 13. SYSTEM PIPE SIZE 3/4" SHALL BE CLASS 200 PVC; SYSTEM PIPE SIZE 1" OR GREATER SHALL BE CLASS 160 PVC, SYSTEM MAIN WILL BE SCH. 40 PVC TO SIZE INDICATED ON PLAN, ALL FITTINGS WILL BE SOLVENT WELD SCH 40 PVC. MAIN LINE SHALL HAVE 24" MINIMUM COVER; ALL OTHER PIPING WILL HAVE 12" MIN. COVER. ALL BACKFILL FOR PIPE TRENCHES SHALL BE CLEAN AND FREE OF FOREIGN DEBRIS AND SHARP OBJECTS; BACKFILLED TRENCHES SHALL BE PROPERLY COMPACTED. ALL MAIN LINES WILL BE INSTALLED A MIN. OF 3' FROM ANY TREE OR PALM.
- 14. WATERING TIME PER STATION WILL BE DETERMINED IN THE FIELD AND PER LOCAL REQUIREMENTS. REFER TO MANUFACTURER'S INSTRUCTIONS FOR PRECIPITATION RATES OF SPRINKLERS SPECIFIED.
- 15. IRRIGATION SYSTEM TO PROVIDE 100% COVERAGE WITH 50% OVERLAP MIN.
- 16. RUST CONTROL SYSTEM TO BE INSTALLED WITH PUMP STATION (IF FROM WELL). 17. THE IRRIGATION SYSTEM IN THE RIGHT-OF-WAY IS TO INCORPORATE LOW TRAJECTORY SPRAY HEADS
- 18. AS-BUILT DRAWINGS SHALL BE PREPARED BY THE CONTRACTOR AND GIVEN TO THE OWNER



PRIOR TO FINAL ACCEPTANCE.

scale: 1"=30'-0"

Michael J. Phillips Landscape Architecture

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SEAL


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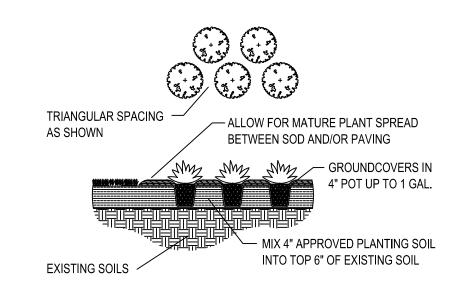
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PLAN DATE 11/30/2023 FILE: LP-1

Irrigation Plan



PLANTING DETAIL - UTILITY SCREENING

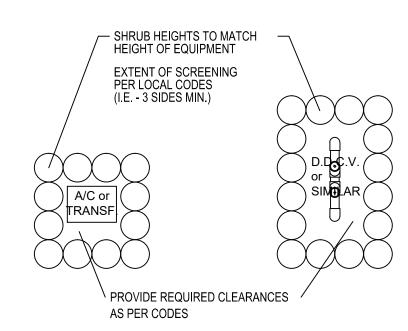

PLANTING DETAIL - GROUNDCOVERS


ALLOW FOR MATURE PLANT SPREAD
BETWEEN DIFFERENT SPECIES,
SOD AREAS AND PAVING

3" SHREDDED MULCH


SHREDDED MULCH

FILL 2/3 WITH APPROVED PLANTING
SOIL, THEN WATER THOROUGHLY.
COMPLETE BACKFILL AFTER WATERING.

PLANTING DETAIL - CONTAINER SHRUBS

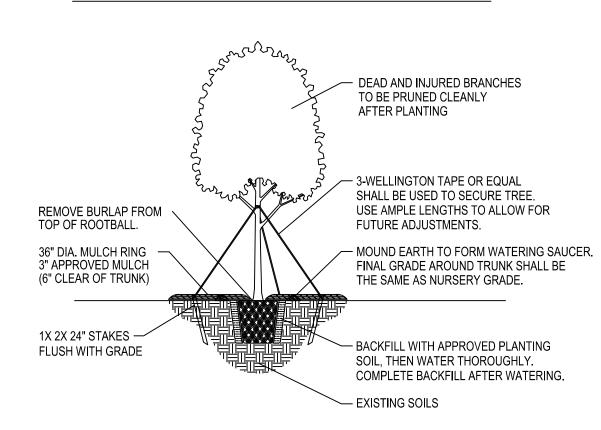

TREE PLANTING & STAKING DETAIL - SMALL TREES

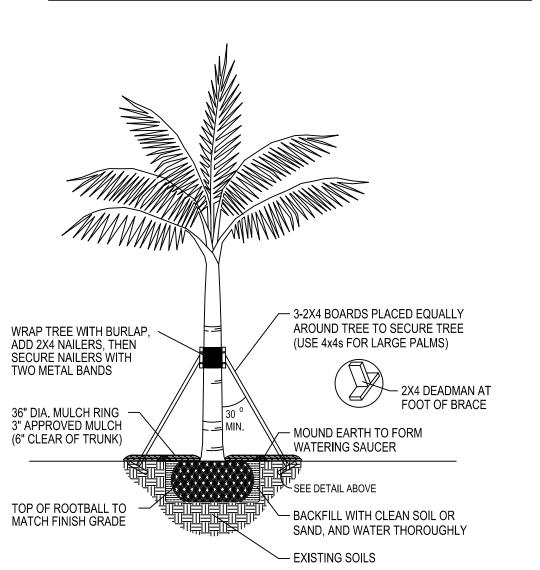

PALM PLANTING & STAKING DETAIL


LANDSCAPE TABLE

LANDSCAPE REQUIREMENTS							
SECTION	DESCRIPTION / REQ	UIREMENTS	QUANTITY	REQUIRED	PROVIDED		
71-105	MINIMUM TREE PER 15 TREES PER ACRE		F. 1.3 ACRES	20	39**		
71-184	NORTH P.L. BUFFERYARD TYPE 1	2 LARGE TREES AND 2 UNDERSTORY PER 100' 20 SHRUBS PER100'	120 L.F.	2 2 25	4 0 60		
71-184	SOUTH P.L. BUFFERYARD TYPE 1	2 LARGE TREES AND 2 UNDERSTORY PER 100' 20 SHRUBS PER100'	130 L.F.	3 3 26	5 0 64		
71-184	EAST P.L. BUFFERYARD TYPE 1	2 LARGE TREES AND 2 UNDERSTORY PER 100' 20 SHRUBS PER100'	459 L.F.	9 9 92	16 0 230		
71-184	WEST P.L. BUFFERYARD TYPE 1	430 L.F.*	N/A	N/A			
71-213	ONE 14' TREE PER P	18 ISLANDS	11	14**			
71-213	ONE 14' TREE PER 2	5' OF LANDSCAPE STRIP	N/A	N/A	N/A		

* minus driveway * * includes palms TOTAL TREES 39

LANDSCAPE LEGEND

ZONING DISTRICT: I	LOT AREA 56,950 s.f.	ACRES 1.3	
OPEN SPACE		REQUIRED/ ALLOWED	PROVIDE
A. Square feet of Open Space as required b Lot Area = (56,951 s.f. x 15%		an: 8,543	8,707
B. Square feet of parking lot open space req as indicated on site plan: Number of parking spaces 100 x 10 s.f.	•	810	810
C. Total square feet of landscaped open spa	ce required by Chapter 33: A + B =	9,353	9,353
LAWN AREA CALCULATION			
A. Square feet of landscaped Open Space re	equired by Chapter 33:	9,353	9,353
B. Maximum lawn area (sod) permitted = (.2) x 9,353 =	1,871	1,860
TREES A. Number of trees required per net lot acre, 15 trees x 1.3 net lot acres =	less existing meeting min requireme	ents 20	20
			0.044
B. % Palms allowed: Number of trees requir	` '	,	38**
C. % Natives required: Number of trees requ	aired x 50% = Minimum	10	70
D. Street Trees (maximum average spacing 554 linear feet along street / 35 =	of 35' o.c.):	16	20
E. Street trees located directly beneath pow spacing 0f 25' o.c.): 329 linear feet along	,	n/a	n/a
F. Total required trees (A+D+E) = SHRUBS		36	40
A. Number of shrubs required: Number of tre	ees required x 10 =	380	659
B. % Native shrubs required: Number of shr	ubs required x 50% =	190	597
** Not counted towards minimum required			
1			

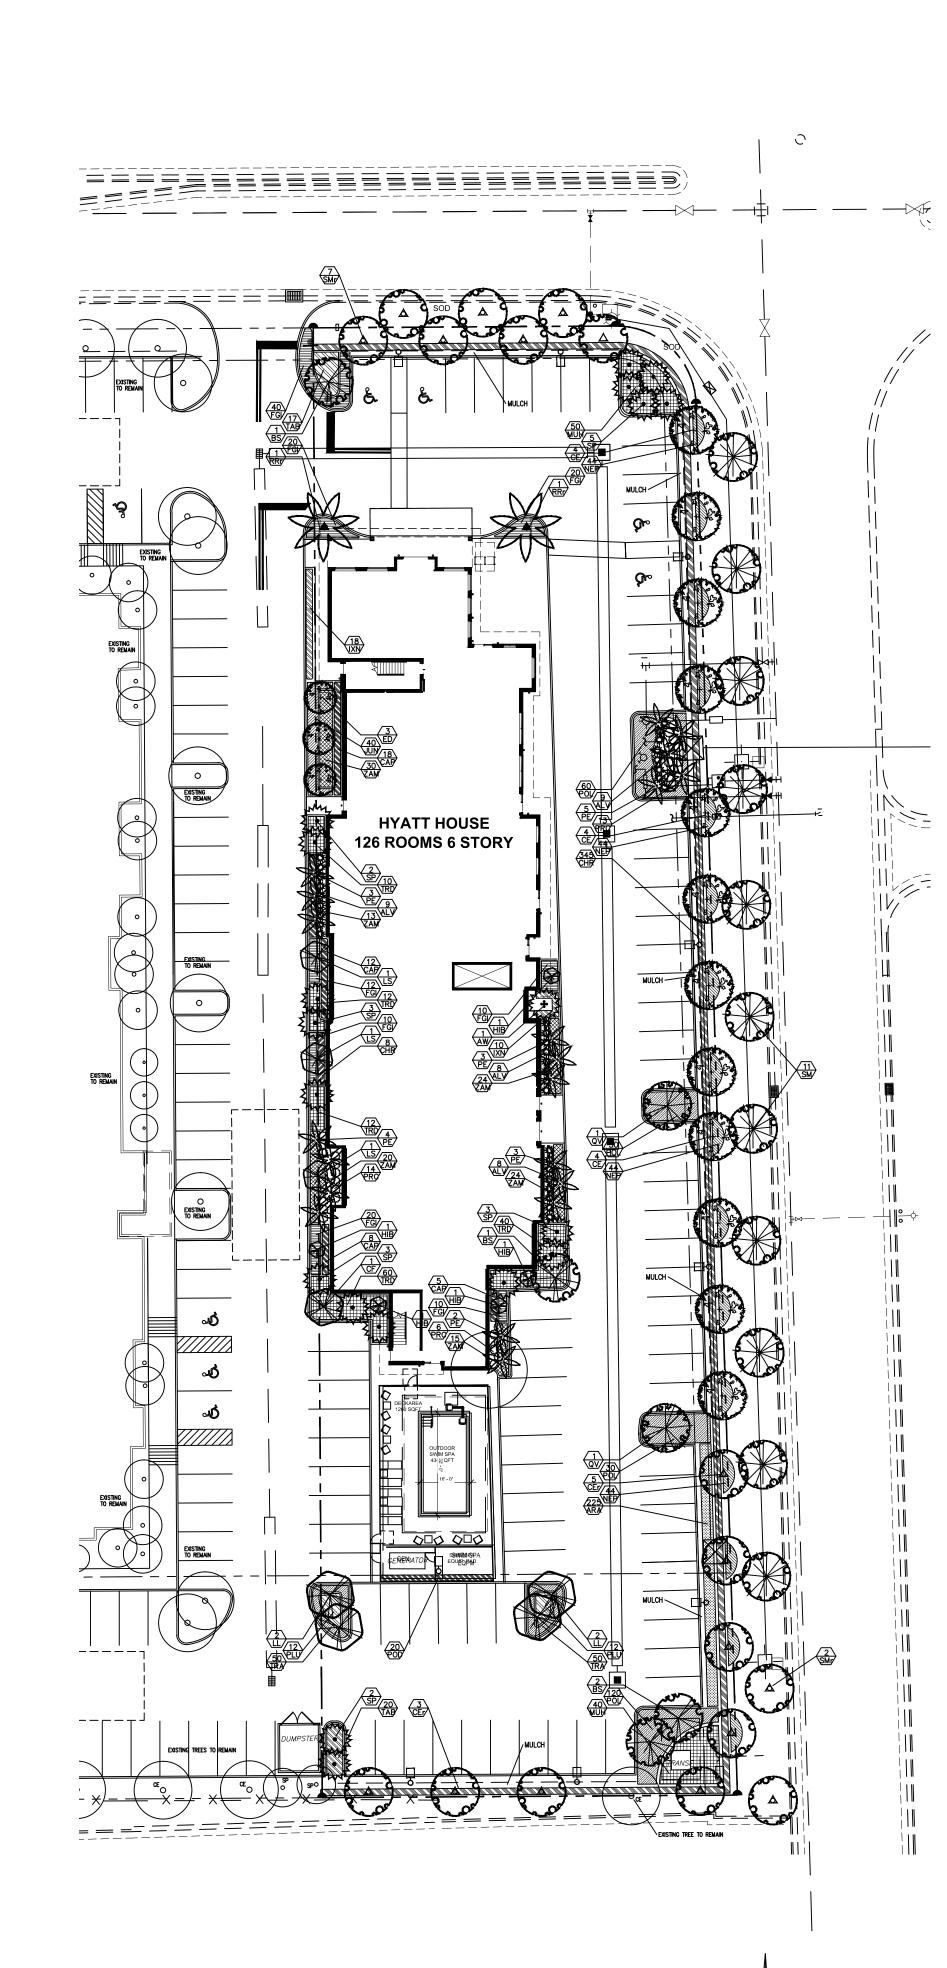

PLANT LIST

	TI	REES ANI	PALMS	
		KEY	QUANTITY	PLANT NAME AND SPECIFICATION
*	N	AW	1	Acoelorhappe wrightii (Everglades Palm) 14' ht., 6' spr., full cluster
**	N	BS	4	Bursera simaruba (Gumbo Limbo) 14' ht., 6' spr., 4" c., full canopy
**	N	CE	12	Conocarpus erectus (Green Buttonwood) 12' ht., 6' spr., 2.5" c., full canopy
**	N	CEr	8	Conocarpus erectus (Green Buttonwood) relocated from site
**		CF	1	Cassia fistula (Shower of Gold) 12' ht., 6' spr., 2.5" c., full canopy
*		ED	3	Elaeocarpus decipiens (Japanese Blueberry) 10' ht., 2.5' c., full canopy
**	N	LL	4	Lysiloma latisiliqua (Wild Tamrind) 14' ht., 6' spr., 4" c., full canopy
*		LS	3	Lagerstroemia speciosa (Queen Crepe Myrtle) 10' ht., 2.5' c., full canopy
*		PE	20	Ptychosperma elegans (Solitaire Palm) 10, 15' & 20' c.t. hts., heavy
**	N	QV	2	Quercus virginiana (Live Oak) 14' ht., 6' spr., 4" c., full canopy
*	N	RRr	2	Roystonea regia (Royal Palm) relocated from site
**	N	SP	18	Sabal palmetto (Cabbage Palm) 16, 20, & 26' staggered c.t. hts., slick
**	N	SM	11	Swietenia mahagonii (West Indies Mahogany) 12' ht., 6' spr., 3" c., full canopy
**	N	SMr	9	Swietenia mahagonii (West Indies Mahogany) relocated from site

	14 Olvii	9	relocated from site
	SHRUBS & G	ROUNDCOVERS	
	KEY	QUANTITY	PLANT NAME AND SPECIFICATION
**	ALV	34	Alpinia z. 'variegata' (Variegated Shell Ginger) 30" ht., 30" spr., full
**	ARA	225	Arachis glabrata (Perennial Peanut) 8" ht., 14" spr., 16" o.c.
**	N CAP	43	Capparis cynophalophora (Jamaican Caper) 24" ht., 20" spr., full, 2' o.c.
**	N CHR	353	Chrysobalanus icaco (Cocoplum) 24" ht., 20" spr., full, 2' o.c.
**	FGI	142	Ficus 'Green Island' 12" ht., 14" spr., full, 18" o.c., ALT: Shore Juniper
*	HIB	5	Hibiscus r. sinesis (Hibiscus Tree) 4-5' ht., 36" spr., full canopy, heavy, tree standard
*	IXN	28	Ixora 'Nora Grant' (Pink Ixora) 20" ht., 20" spr., full, 2' o.c.
**	JUN	40	Juniperus c. (Shore Juniper) 12" ht., 14" spr., 18" o.c.
**	N MUH	90	Muhlenberghia cappilaris (Muhly Grass) 24" ht., 24" spr., full, 30" o.c.
**	N NEP	176	Nephrolepis exalta (Sword Fern) 12" ht., 14" spr., 2' o.c.
**	PLU	24	Plumbago auriculata (Leadwort) 12" ht., 16" spr., full, 2' o.c., color per owner
**	POL	240	Polypodium scolopendria (Wart Fern) 12" ht., 14" spr., 2' o.c.
**	POD	20	(Podocarpus m. (Podocarpus Hedge) 36" ht., 24" spr., full, 20" o.c.
**	PRC	33	Philodendron 'Rojo Congo' 20" ht., 20" spr., full, 2' o.c.
**	TAB	37	Tabernaemontana spp. (Crape Jasmine) 24" ht., 24" spr., full, 2' o.c.
**	TRA	100	Trachelospermum asiaticum 'minima' (Asiatic Jasmine) 12" ht., 14" spr., 18" o.c.
**	N TRD	134	Tripsacum floridanum (Dwarf Fakahatchee Grass) 24" ht., 24" spr., full, 2' o.c.
**	N ZAM	126	Zamia floridanum (Coontie) 16" ht., 16" spr., full, 2' o.c.
'			

- N DENOTES NATIVE SPECIES
- ** DENOTES HIGH DROUGHT TOLERANT SPECIES

 * DENOTES MODERATE DROUGHT TOLERANT SPECIES
- NOTES

scale: 1"=30'-0"

Sod to be St. Augustine 'Floratam', contractor to determine quantity.

All landscape areas to receive 100% coverage from automatic irrigation system using non-potable water source. Bubblers to be provided for large trees and palms.

Contractor is responsible for all conditions and landscape specifications attached to this plan

and plant list. Landscape Plan and specifications shall be considered Contract Documents. PLANTING SPECIFICATIONS

NOMENCLATURE: All plant material used shall be true to name and size, and shall conform to the Florida Nurserymen's Grades and Standards as Florida Grade #1 or better.

PLANT LISTS: Plant quantities, sizes, and locations shall be determined by plan and plant lists. Plant height and spread shall take precedence over container size. Container size noted is to be considered minimum. Spacing of plant material will be determined by plant lists and details. Quantities shown on plant lists are guideline only. Contractor is responsible for the actual quantities indicated on plans. Discrepancies should be brought to the attention of the Landscape Architect.

SUBSTITUTIONS: Landscape Architect to review and approve any plant substitutions. Substitutions shall be provided as an alternate on proposals.

PLANTING SOIL: Topsoil shall be clean, sterile, and free of debris or other foreign material. Topsoil when suitable, shall be used for the planting of trees and shrubs. The existing soils shall be amended with organic material to reduce the pH levels to between 5 and 6. Amendments are to be incorporated into the planting backfill material. Groundcover beds shall be topped with a minimum 4" of planting soil. The planting soil to be mixed into the existing soils during planting. SOIL ADDITIVES: Additives such as water absorbing polymers are welcome additions to soils where water retention is a problem.

FERTILIZER: Slow-release granular fertilizer similar to 12-4-12 formula to be applied at planting at manufacturers recommended application rates. Tree tabs shall be used for all trees and palms. MULCH: A 3' diameter mulch ring with 3" of approved shredded mulch shall be used around all free-standing trees and palms. Shrub beds shall be mulched with 3" of approved shredded mulch as shown on plan.

PLANTING PROCEDURE: All plants shall be planted at soil levels at which they were previously grown. Shrub and hedge material shall be planted a min. 2' away from walls or other obstructions. Large material shall be planted away from overhangs so as not to affect the plant or structure in the future. Unsuitable soil or site conditions are to be brought to the attention of the G.C. and the Landscape Architect.

WATERING: All plant material shall be watered in thoroughly at installation so as to remove air pockets. Watering is the responsibility of the Contractor, and he shall hand water as necessary. A temporary watering systems may be necessary for large material.

GUYING: Proper support of trees and palms during the grow-in period is the responsibility of Contractor. Staking shall be per industry standards. No harm shall be caused by the staking process (i.e. braces are not to be nailed into trees). See attached details for examples.

SOD: Sod shall be dense, green, and well rooted, disease free, and free of weeds, or insects. Sod shall be watered to a depth of 4" after laying. All areas to be sodded shall be raked smooth and all debris removed prior to installation.

GUARANTEE: All plant materials shall be guaranteed for 1 year after completion of project.

Guarantee applies to health, position, and size. Replacement cost will be carried by Contractor.

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REV	DESCRIPTION	DATE

1yatt House 0234 NW 19th Street

PLAN DATE

11/30/2023


FILE: LP-1

Landscape Plan

LP-1

ALL TREES INDICATED WITHIN CONSTRUCTION AREAS ARE TO BE PROTECTED FROM ANY POSSIBLE DAMAGE DURING ACTIVE CONSTRUCTION STAGES BY MEANS OF A TEMPORARY CONSTRUCTION FENCE/BARRIER (SEE DETAIL)


THE BARRIER SHALL EXTEND TO THE LIMITS OF THE EXISTING CANOPY (MINIMUM)

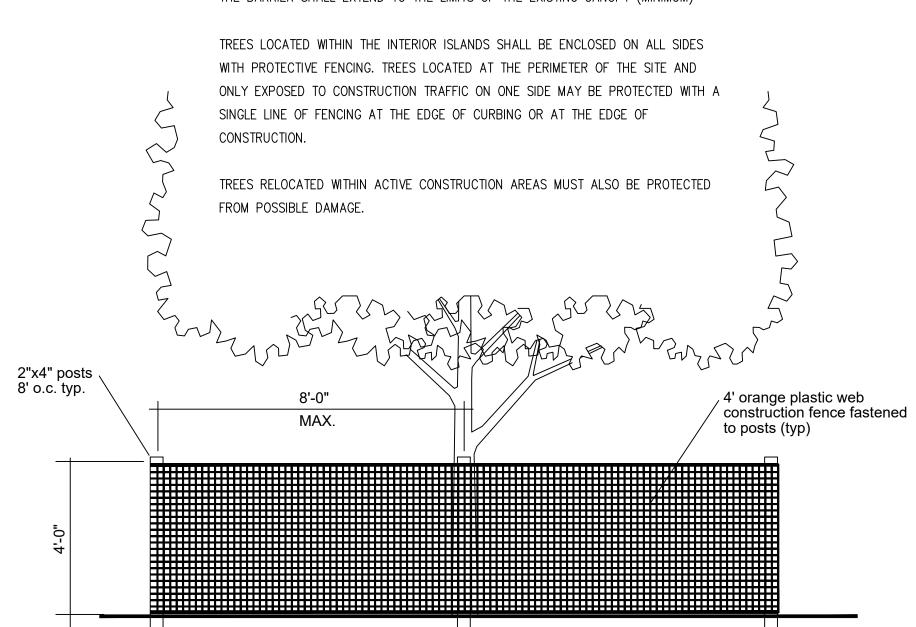


TREE PROTECTION FENCE

EXISTING TREE LIST

NO.	KEY	BOTANICAL AND COMMON NA	AME	DBH	HT / SPR	COMMENTS	DISP0SITION
1	SM	SWIETENIA MAHAGONII M	MAHOGANY	2" d.b.h.	12' ht., 6'sp.	good	RELOCATE
2	SM	SWIETENIA MAHAGONII M	//AHOGANY	2" d.b.h.	12' ht., 6'sp.	good	RELOCATE
3	LC	LIVISTONA CHINENSIS C	CHINESE FAN	12" d.b.h.	30-40' ht.	good	REMOVE
4	LC	LIVISTONA CHINENSIS C	CHINESE FAN	12" d.b.h.	30-40' ht.	good	REMOVE
5	LC	LIVISTONA CHINENSIS C	CHINESE FAN	12" d.b.h.	30-40' ht.	good	REMOVE
6	LC	LIVISTONA CHINENSIS C	CHINESE FAN	12" d.b.h.	30-40' ht.	good	REMOVE
7	SM	SWIETENIA MAHAGONII M	//AHOGANY	2" d.b.h.	12' ht., 6'sp.	good	RELOCATE
8	SM	SWIETENIA MAHAGONII M	MAHOGANY	2" d.b.h.	12' ht., 6'sp.	good	RELOCATE
9	SM	SWIETENIA MAHAGONII M	//AHOGANY	2" d.b.h.	12' ht., 6'sp.	good	RELOCATE
10	SM	SWIETENIA MAHAGONII M	MAHOGANY	2" d.b.h.	12' ht., 6'sp.	good	RELOCATE
11	QL	QUERCUS LAURIFOLIA L	AUREL OAK	11" d.b.h.	25' ht, 20'sp	fair, dieback, branch damage	REMOVE
12	QL	QUERCUS LAURIFOLIA L	AUREL OAK	11" d.b.h.	20' ht, 20'sp	very poor, dieback, br dmg	REMOVE
13	SM	SWIETENIA MAHAGONII M	MAHOGANY	2" d.b.h.	12' ht., 6'sp.	good	RELOCATE
14	SM	SWIETENIA MAHAGONII M	MAHOGANY	2" d.b.h.	12' ht., 6'sp.	good	RELOCATE
15	SM	SWIETENIA MAHAGONII M	MAHOGANY	2" d.b.h.	12' ht., 6'sp.	good	RELOCATE
16	QL	QUERCUS LAURIFOLIA L	AUREL OAK	10" d.b.h.	25' ht, 25'sp	fair, dieback, branch damage	REMOVE
17	QL	QUERCUS LAURIFOLIA L	AUREL OAK	10" d.b.h.	25' ht, 25'sp	poor, dieback, branch damage	REMOVE
18	QL	QUERCUS LAURIFOLIA L	AUREL OAK	13" d.b.h.	30' ht, 30'sp	fair, dieback, branch damage	REMOVE
19	QL	QUERCUS LAURIFOLIA L	AUREL OAK	14" d.b.h.	35' ht, 30'sp	fair, dieback, branch damage	REMOVE
20	CE	CONOCARPUS ERECTUS B	BUTTONWOOD	11" d.b.h.	20' ht, 20'sp	fair, branch damage	REMAIN
21	CE	CONOCARPUS ERECTUS B	BUTTONWOOD	3" d.b.h.	15' ht, 8'sp	good	REMOVE
22	SP	SABAL PALMETTO C	CABBAGE PALM	11" d.b.h.	14 c.t., 11'sp	good	REMOVE
23	CE	CONOCARPUS ERECTUS B	BUTTONWOOD	3" d.b.h.	15' ht, 8'sp	good	RELOCATE
24	RR	ROYSTONEA REGIA R	ROYAL PALM	16" d.b.h.	16' c.t., 18'sp	good	RELOCATE
25	CE	CONOCARPUS ERECTUS B	BUTTONWOOD	3" d.b.h.	15' ht, 8'sp	good	RELOCATE
26	RR	ROYSTONEA REGIA R	ROYAL PALM	16" d.b.h.	16' c.t., 18'sp	good	RELOCATE
27	LS	LAGERSTROEMIA SPECIOSA	Q. CRAPE MYRTLE	2.5" d.b.h.	12' ht, 6'sp	good	RELOCATE
28	RR	ROYSTONEA REGIA R	ROYAL PALM	16" d.b.h.	16' c.t., 18'sp	good	RELOCATE
29	LS	LAGERSTROEMIA SPECIOSA	Q. CRAPE MYRTLE	2.5" d.b.h.	12' ht, 6'sp	good	RELOCATE
30	RR	ROYSTONEA REGIA R	ROYAL PALM	16" d.b.h.	16' c.t., 18'sp	good	RELOCATE
31	LS	LAGERSTROEMIA SPECIOSA	Q. CRAPE MYRTLE	2.5" d.b.h.	12' ht, 6'sp	good	RELOCATE
32	RR	ROYSTONEA REGIA	ROYAL PALM	16" d.b.h.	16' c.t., 18'sp	good	RELOCATE
33	CE	CONOCARPUS ERECTUS B	BUTTONWOOD	3" d.b.h.	15' ht, 8'sp	good	RELOCATE
34	CE	CONOCARPUS ERECTUS B	BUTTONWOOD	3" d.b.h.	15' ht, 8'sp	good	RELOCATE
35	CE	CONOCARPUS ERECTUS B	BUTTONWOOD	3" d.b.h.	15' ht, 8'sp	good	RELOCATE
36	CE	CONOCARPUS ERECTUS B	BUTTONWOOD	3" d.b.h.	15' ht, 8'sp	good	RELOCATE
37	CE	CONOCARPUS ERECTUS B	BUTTONWOOD	3" d.b.h.	15' ht, 8'sp	good	RELOCATE

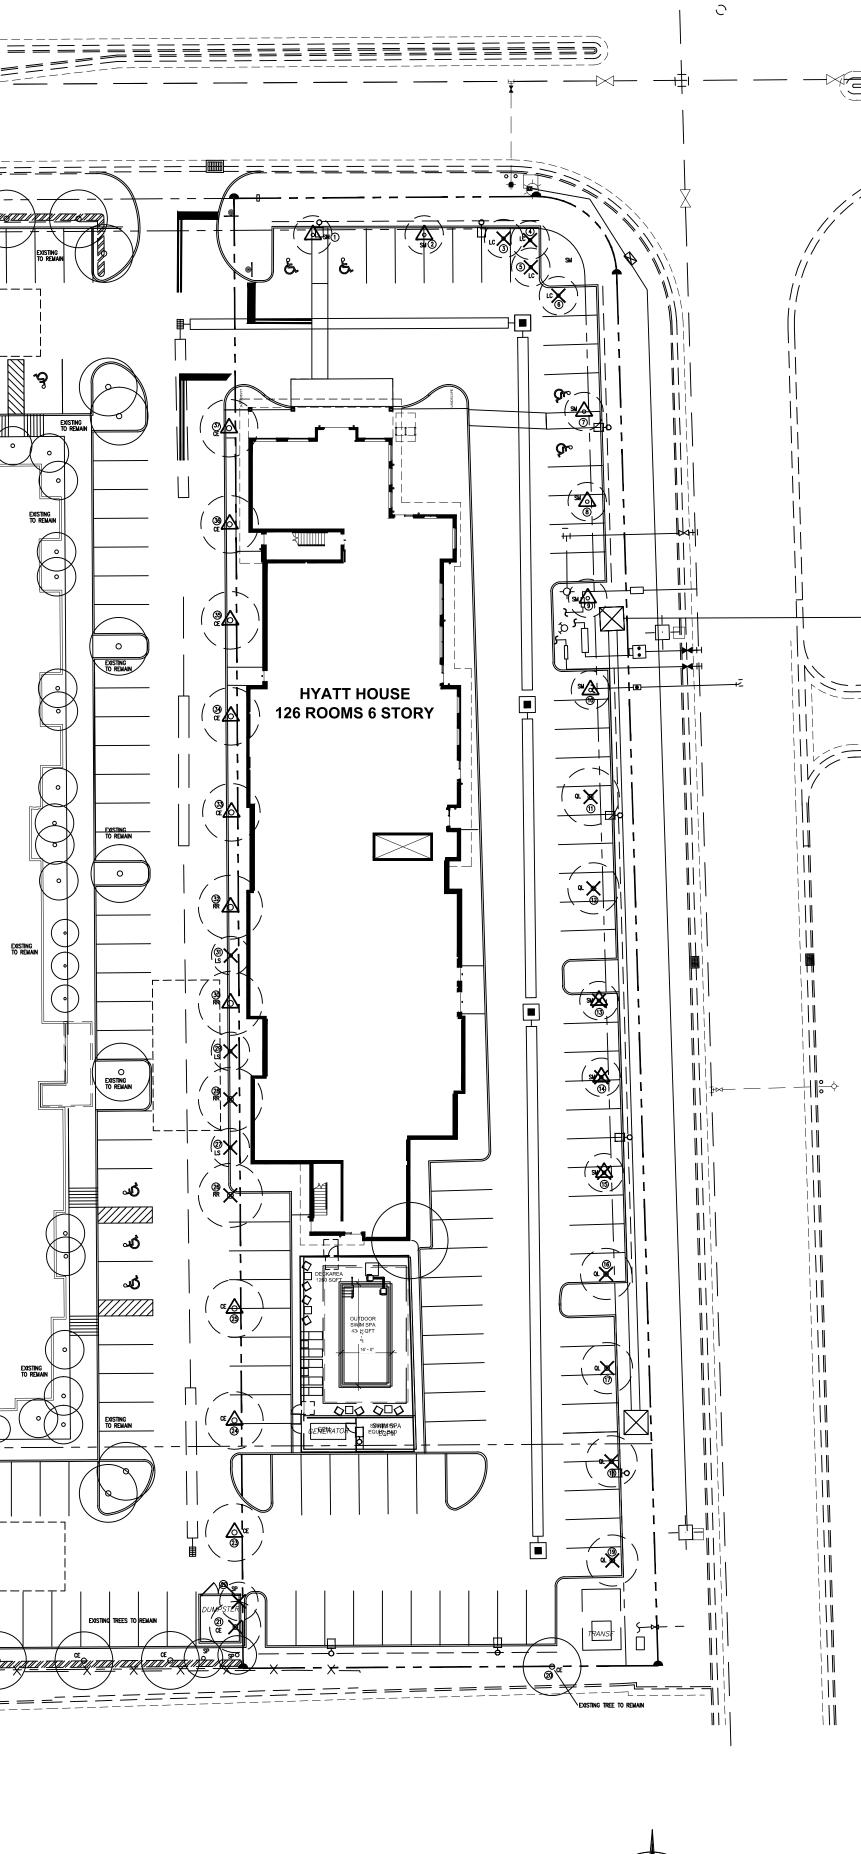

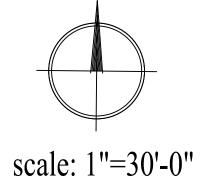

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REV DESCRIPTION DATE

Hyatt House 10234 NW 19th Street

PLAN DATE

11/30/2023

Tree Disposition
Plan
TD-1

LEGEND GRAVEL BED (No. 57 ROCK)

STAKED SILT FENCE

CONTROL.

- 1. PERIMETER CONSTRUCTION FENCE SHALL BE PROVIDED WITH WIND SCREEN TO MAINTAIN SUFFICIENT DUST
- 2. INSTALLATION OF ANY STAKED SILT FENCE SHALL BE IN ACCORDANCE WITH FDOT, INDEX NO. 102, LATEST EDITION.

BE IN ACCORDANCE WITH FDOT, INDEX No. 102, LATEST

- 3. INSTALLATION OF EROSION AND SEDIMENT CONTROLS SHALL
- 4. INSTALLATION OF HAY BALES SHALL BE IN ACCORDANCE
- WITH FDOT, INDEX No. 102, LATEST EDITION. 5. PLACEMENT OF ROCK BAGS (IF USED) SHALL BE IN
- ACCORDANCE WITH FDOT, INDEX No. 102, LATEST EDITION.

STORMWATER POLLUTION PREVENTION PLAN (SWPPP) NOTES

A. GENERAL NOTES

- 1. ENVIRONMENTAL CONTROL FEATURES AS PROVIDED IN PLANS ARE TO BE INSTALLED AT ALL AREAS OF EXCAVATION OR FILL FOR DRAINAGE SYSTEM OR STRUCTURE CONSTRUCTION PRIOR TO SUCH EXCAVATION OR FILL.
- INLET ENTRANCES ARE ALSO TO BE PROTECTED FROM SILTATION AS DETAILED IN THE FDOT STANDARDS.
- 2. ALL ENVIRONMENTAL CONTROL FEATURES ARE TO BE MAINTAINED THROUGHOUT THE LIFE OF THE PROJECT IN ACCORDANCE WITH FDEP'S NPDES REQUIREMENTS. THE CONTRACTOR MUST ENSURE THAT ALL EROSION CONTROL FEATURES FUNCTION PROPERLY AT ALL TIMES.
- 3. ALL EROSION AND MATERIAL DEPOSITS MUST BE CONTAINED WITHIN THE PROJECT LIMITS.
- 4. CONTRACTOR'S SUBMITTALS: THE CONTRACTOR IS RESPONSIBLE FOR SUBMITTING THE FOLLOWING ITEMS TO FDEP IN ORDER FOR THE NPDES PERMIT
- a. IF THIS SWPPP IS ADOPTED BY THE CONTRACTOR, THE SWPPP SHEETS AND OTHER PLAN SHEETS SHALL BE INCLUDED BY REFERENCE IN THE NOTICE OF INTENT
- (NOI) SUBMITTAL. THE CONTRACTOR MAY ELECT TO SUBMIT A REVISED SWPPP THAT IS IN COMPLIANCE WITH THE STORM WATER REGULATIONS AT 40 CFR 122.26(b)(14) AND STATE WATER QUALITY STANDARDS. b. SIGNED CONTRACTOR CERTIFICATION FORMS (2). THESE FORMS MUST BE SIGNED BY BOTH THE PRIME CONTRACTOR AND SUB-CONTRACTOR (IF APPLICABLE) PERFORMING SOIL-DISTURBING ACTIVITIES.
- c. HAZARDOUS MATERIAL SPILL CONTROL PLAN. d. STAGING AREAS, STOCKPILE LOCATIONS AND STABILIZATION PRACTICES.
- e BRIDGE CONSTRUCTION METHOD AND SEQUENCING (IF APPLICABLE). f. DEWATERING PLAN (IF APPLICABLE).

EROSION CONTROLS PROVIDED FOR THOSE INLETS.

- 5. NO SOIL DISTURBING ACTIVITIES CAN BE CONDUCTED UNTIL THE NPDES PACKAGE HAS BEEN MAILED TO THE FDEP.
- 6. ANY DAMAGED OR INEFFECTIVE BAGS ARE TO BE REPLACED WITH NEW ONES. THE LOCATION OF ROCK BAG INSTALLATION IS AS MENTIONED IN EROSION CONTROL PLANS. THE PROJECT ENGINEER MAY SPECIFY OTHER AREAS AS NECESSARY.
- 7. DITCH BOTTOM INLETS SHALL BE PROTECTED FROM SEDIMENT INTAKE UNTIL PROJECT IS COMPLETE. ELEVATION OF GROUND OUTSIDE INLET TOP SHALL NOT BE
- HIGHER THAN INLET TOP. ROCK BAGS SHALL BE INSTALLED AROUND INLET TOP.
- 9. CURB INLETS ALSO SHALL BE PROTECTED FROM SEDIMENT INTAKE UNTIL THE PROJECT IS COMPLETE. ALL FILL EMBANKMENT AND GRADED AREAS SHALL BE PROTECTED AGAINST EROSION BY METHODS STATED IN "SECTION ID4" FDOT STANDARDS SPECIFICATIONS FOR BRIDGE AND ROAD CONSTRUCTION.

8. COMPLETED INLETS IN PAVED AREAS SHALL ALSO BE PROTECTED WITH ROCK BAGS TO PREVENT SEDIMENT INTAKE FROM OTHER AREAS.

- 10. STOCKPILED MATERIALS SHALL NOT BE LEFT IN EROSION PRONE AREAS UNLESS PROTECTED BY COVER AND/OR OTHER APPROPRIATE EROSION CONTROL MEASURES.
- 11. INSPECTION OF EROSION CONTROL MEASURES AND CONDITION OF ADJACENT PROPERTIES SHALL BE PERFORMED DAILY BY THE CONTRACTOR'S REPRESENTATIVE
- AND THE PROJECT ENGINEER. DEFICIENCIES SHALL BE NOTED AND CORRECTED. 12. ANY OFFSITE SEDIMENT DISCHARGE TO A MUNICIPALLY SEPARATE STORM SEWER SYSTEM ARISING FROM THE CONTRACTOR'S ACTIVITIES SHALL HAVE
- 13. THE AGGREGATE LAYER OF ALL CONSTRUCTION ENTRANCE GRAVEL BEDS MUST BE AT LEAST 6 INCHES THICK. IT MUST EXTEND THE FULL WIDTH OF THE VEHICULAR INGRESS AND EGRESS AREA. THE LENGTH OF THE ENTRANCE MUST BE AT LEAST 50 FEET. THE ENTRANCE MUST WIDEN AT ITS CONNECTION TO THE ROADWAY IN ORDER TO ACCOMMODATE THE TURNING RADIUS OF LARGE TRUCKS.

B. SITE DESCRIPTION

- CONSTRUCTION ACTIVITY: LAND DEVELOPMENT, FILLING, DRAINAGE AND UTILITY INSTALLATION, BUILDING AND ROAD CONSTRUCTION.
- PROJECT LIMITS:
- N.W. 19TH STREET ON THE NORTH, PRIVATE PROPERTY ON THE SOUTH & WEST, AND 102ND AVENUE ON THE EAST

PROJECT DESCRIPTION:

- LAND DEVELOPMENT AT THE HYATT DORAL PROJECT SITE WILL INCLUDE CLEARING AND GRUBBING, CONSTRUCTION OF (1) HOTEL BUILDING WITH AT-GRADE PARKING; THE PROPOSED DRAINAGE SYSTEM WILL CONSIST OF EXFILTRATION TRENCHES.
- MAJOR SOIL DISTURBING ACTIVITIES:
- DEMOLITION; CLEARING AND GRUBBING; EXCAVATION FOR STORMWATER FACILITIES AND OTHER UTILITIES; AND, BUILDING FOUNDATIONS &
- 3. TOTAL PROJECT AREA: 1.30 ACRES TOTAL AREA TO BE DISTURBED: 1.30 ACRES
- 4. LOCATIONS OF DRAINAGE AREAS AND OUTFALLS:
- SEE ATTACHED PLAN.
- 5. NO SOIL DISTURBING ACTIVITIES CAN BE CONDUCTED UNTIL THE NPDES PACKAGE HAS BEEN MAILED TO THE FDEP. THE CONTRACTOR'S MODIFIED SWPPP MUST ALSO RECEIVE APPROVAL FROM FDOT PERMITS OFFICE PRIOR TO IMPLEMENTATION.
- 6. AREA OF DISCHARGE FOR THIS PROJECT IS 1.30 ACRES = 56,952 SF
- 7. SOILS ARE CLASSIFIED AS URBAN LAND AND QUALITY OF DISCHARGE IS LIMEROCK FILL AND SAND.
- 8. LATITUDE AND LONGITUDE OF DIRECT DISCHARGE POINT IS NOT APPLICABLE SINCE THIS IS A CLOSED SYSTEM WITH NO DIRECT DISCHARGE TO ADJACENT SURFACE WATERS. HOWEVER, LATITUDE AND LONGITUDE OF THIS PROJECT AS INDICATED IN THE NOI IS 25°47'25.70"N/80°21'39.89"W AND LATITUDE AND LONGITUDE OF THE NEARBY CANAL IS 25°47'21.93"N/80°21'7.45"W.

C. CONTROLS

- NARRATIVE SEQUENCE OF SOIL DISTURBING ACTIVITIES AND IMPLEMENTATION OF CONTROLS.
- CONSTRUCTION OF THE HYATT DORAL PROJECT IS TO BE BOUNDED BY N.W. 19TH STREET ON THE NORTH, PRIVATE PROPERTY ON THE SOUTH AND WEST, N.W. 102ND AVENUE ON THE EAST.
- PRIOR TO COMMENCEMENT OF CONSTRUCTION ACTIVITIES, ALL EROSION CONTROLS MUST BE IMPLEMENTED.

TEMPORARY STABILIZATION:

DISTURBED PORTIONS OF THE SITE (E.G. EMBANKMENT AT TEMPORARY RAMPS) WHERE CONSTRUCTION ACTIVITY CEASES FOR AT LEAST 21 DAYS, SHALL BE STABILIZED WITH TEMPORARY SOD OR TEMPORARY SEEDING AND MULCHING NO LATER THAN 14 DAYS FROM THE LAST CONSTRUCTION ACTIVITY IN THAT AREA.

PERMANENT STABILIZATION: DISTURBED PORTIONS OF THE SITE WHERE CONSTRUCTION ACTIVITY PERMANENTLY CEASES SHALL BE STABILIZED WITH SOD NO LATER THAN 14 DAYS AFTER THE LAST CONSTRUCTION ACTIVITY.

- **EROSION AND SEDIMENT CONTROLS:**
- (1) STABILIZATION PRACTICES: X TEMPORARY SODDING _TEMPORARY GRASSING __PERMANENT SODDING, SEEDING OR SEED & MULCH
- X TEMPORARY MULCHING _____ARTIFICIAL COVERING _____BUFFER ZONES _____PRESERVATION OF NATURAL RESOURCES
- __SAND BAGGING X SILT FENCES _____ROCK BAGS BERMS X DIVERSION, INTERCEPTOR, OR PERIMETER DITCHES _____PIPE SLOPE DRAINS _____FLUMES X ROCK BEDDING AT CONSTRUCTION EXIT _____TIMBER BEDDING AT CONSTRUCTION EXIT ____DITCH LINER ___SEDIMENT TRAPS (DURING DE-WATERING) ___SEDIMENT BASINS X STORM INLET SEDIMENT TRAP

(2) STRUCTURAL PRACTICES:

____STONE OUTLET STRUCTURES ___CURBS AND GUTTERS X STORM SEWERS ——VELOCITY CONTROL DEVICES _____TURBIDITY BARRIER _____RIP RAP

OTHER:

- 2. DESCRIPTION OF STORM WATER MANAGEMENT:
- THE STORMWATER MANAGEMENT SYSTEM CONSISTS OF RAINWATER LEADERS AND AREA DRAINS THAT CONVEY STORMWATER INTO EXFILTRATION TRENCHES AND GRIT TANKS THAT TREAT THE WATER QUALITY REQUIREMENTS AND DRAINAGE WELLS THAT TREAT THE WATER QUANTITY REQUIREMENTS.

3. OTHER CONTROLS (1) WASTE DISPOSAL: IN APPROVED OFFSITE AREAS PROVIDED BY THE CONTRACTOR.

(2) OFFSITE VEHICLE TRACKING: HAUL ROADS DAMPENED FOR DUST CONTROL LOADED HAUL TRUCKS TO BE COVERED WITH TARPAULIN EXCESS DIRT ON ROAD REMOVED DAILY X STABILIZED CONSTRUCTION ENTRANCE

OTHER:

(3) SANITARY WASTE: ALL SANITARY WASTE WILL BE COLLECTED FROM THE PORTABLE UNITS AS NECESSARY OR AS REQUIRED BY LOCAL REGULATION OF A LICENSED SANITARY WASTE MANAGEMENT CONTRACTOR.

(4) FERTILIZERS AND PESTICIDES:

- FERTILIZER TO BE APPLIED ONLY IN THE MINIMUM AMOUNTS RECOMMENDED BY THE MANUFACTURER. ONCE APPLIED, FERTILIZER WILL BE WORKED INTO THE SOIL TO LIMIT EXPOSURE TO STORMWATER. IF STORED ON-SITE, STORAGE WILL BE IN COVERED SHED. THE CONTENT OF ANY PARTIALLY USED BAGS OF FERTILIZER WILL BE TRANSFERRED TO A SEPARATE PLASTIC BIN TO AVOID SPILLS.
- (5) NON-STORM WATER DISCHARGE (INCLUDING SPILL REPORTING) THE CONTRACTOR IS RESPONSIBLE FOR REPORTING SPILLS TO MIAMI-DADE COUNTY DEPARTMENT OF REGULATORY AND ECONOMIC RESOURCES (RER). DEWATERING IS NOT ANTICIPATED.

IF CONTAMINATED SOIL OR GROUNDWATER IS ENCOUNTERED OR HAZARDOUS SPILLS OCCUR DURING CONSTRUCTION THE MIAMI-DADE COUNTY DEPARTMENT OF REGULATORY AND ECONOMIC RESOURCES (RER) SHALL BE CONTACTED AT THEIR HOTLINE: (305) 372-6955.

4. APPROVED STATE, LOCAL PLANS, OR STORM WATER PERMITS: CITY OF DORAL BUILDING DEPARTMENT, MIAMI DADE COUNTY RER, AND FLORIDA DEPARTMENT OF TRANSPORTATION.

By Stephanie Puglia at 9:55 am, Feb 21, 2024

D. MAINTENANCE

SILT FENCE

MAINTENANCE: ALL CONTROLS SHALL BE MAINTAINED IN PROPER WORKING ORDER AT ALL TIMES DURING CONSTRUCTION. IF A REPAIR IS NECESSARY, IT WILL BE INITIATED WITHIN 24 HOURS OF BEING


NOTED IN CONTRACTOR'S DAILY INSPECTION REPORT.

CONSTRUCTION ENTRANCE GRAVEL BED

WHEN THE CONSTRUCTION ENTRANCE GRAVEL BEDS BECOME LOADED WITH SEDIMENTS, REWORK BEDS TO DISPLACE SEDIMENT LOAD AND RE-ESTABLISH EFFECTIVENESS OF THE GRAVEL BEDS.

E. INSPECTION

THE CONTRACTOR SHALL INSPECT ALL EROSION CONTROL FEATURES AT LEAST ONCE EVERY SEVEN CALENDAR DAYS AND WITHIN 24 HOURS OF THE END OF A STORM OF 0.5" OR GREATER. IN ADDITION, A DAILY REVIEW OF THE LOCATION OF SILT FENCES SHALL BE MADE IN AREAS WHERE CONSTRUCTION ACTIVITIES HAVE CHANGED THE NATURAL CONTOUR AND DRAINAGE RUNOFF. IN ORDER TO INSURE THAT SILT FENCES AND OTHER EROSION CONTROL DEVICES ARE PROPERLY LOCATED FOR EFFECTIVENESS. A FORM ACCEPTABLE TO THE FDEP WILL BE USED TO REPORT ALL INSPECTION FINDINGS AND CORRECTIVE ACTIONS TAKEN AS A RESULT OF THE INSPECTION. EACH INSPECTION REPORT SHALL BE SIGNED AND SUBMITTED WEEKLY TO THE PROJECT ENGINEER. IF A REPAIR IS NECESSARY, IT WILL BE INITIATED WITHIN 24 HOURS OF BEING NOTED IN CONTRACTOR'S INSPECTION REPORT.

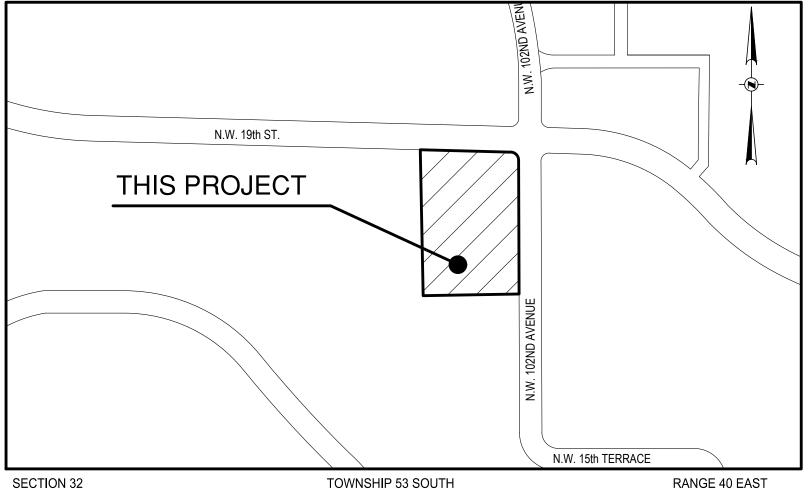


LOCATION SKETCH

FOLIO No.: 35-3032-034-0020 LEGAL DESCRIPTION


LAND DESCRIPTION:

TRACT 'B', "GREAT SPRINGS AT I.C.P.", ACCORDING TO THE PLAT THEREOF, AS RECORDED IN PLAT BOOK 158, PG. 94, OF THE PUBLIC RECORDS OF MIAMI/DADE COUNTY, FLORIDA. SECTION 32, TOWNSHIP 53 SOUTH, RANGE 40 EAST, LESS THE WEST 455.34 FEET THEREOF.

SWPPP - DETAILS

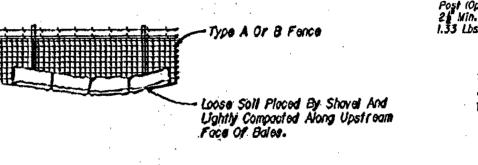

BALES BACKED BY FENCE

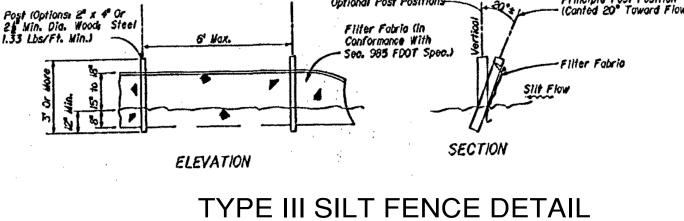

Ditches With Intermittent Flow SILT FENCE APPLICATIONS

1. Type III Silt Fence to be used at most locations. Where used in ditches, the spacing for Type III Silt fence shall be in accordance with Chart 1, Sheet 1 2. Type IV Silt Fence to be used where large sediment loads are anticipated. Suggested use is where fill slope is 1:2 or steeper and length of slope exceeds 25 feet. Avoid use where the detained water may back into travellanes or off the right of way. 3. Do not construct silt fences across permanent flowing watercourses. Silt fences are to be at upland locations and turbidity barriers used at permanent bodies of water.

4. Where used as slope protection, Silt Fence is to be constructed on 0% longitudinal grade to avoid channelizing runoff along the length of the fence. 5. Silt Fence to be paid for under the contract unit price for Staked Silt Fence, (LF).

SILT FENCE APPLICATIONS

LEGEND

GRAVEL BED (No. 25 ROCK)

STAKED SILT FENCE

NOTES: 1. INSTALLATION OF ANY STAKED SILT FENCE SHALL BE IN ACCORDANCE WITH FDOT INDEX No. 102.

2. INSTALLATION OF HAY BALES SHALL BE IN ACCORDANCE WITH FDOT INDEX No. 102. 3. PLACEMENT OF ROCK BAGS (IF USED) SHALL BE

IN ACCORDANCE WITH FDOT INDEX No. 102.





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ON ANY ELECTRONIC COPIES. FOR THE FIRM: NELSON H. ORTIZ PE-57556

AND SEALED BY NELSON H. ORTIZ, P.E.

ON THE DATE ADJACENT TO THE SEAL.

PRINTED COPIES OF THIS DOCUMENT ARE

NOT CONSIDERED SIGNED AND SEALED AND THE SIGNATURE MUST BE VERIFIED

PROJECT TITLE: **HYATT HOUSE**

BAYWOOD HOTEL 3785 N.W. 82nd AVENUE, SUITE 204

10234 NW 19 STREET

DORAL, FLORIDA

Folio No.

MIAMI, FLORIDA 33166

NO. DATE

PROJECT INFORMATION:

PROJECT NUMBER: 2023-7020 09-21-2023 DRAWN BY CHECKED BY:

SHEET TITLE:

STORMWATER POLLUTION PREVENTION PLAN, DETAILS AND NOTES

SHEET NUMBER:

AS SHOWN