RESOLUTION No. 23-186

A RESOLUTION OF THE MAYOR AND THE CITY COUNCIL OF THE CITY OF DORAL, FLORIDA, APPROVING THE SITE PLAN FOR BOING US HOLDCO, INC., FOR THE PROPERTY LOCATED AT 1350 NW 87 AVENUE, DORAL, FLORIDA, PURSUANT TO SECTION 53-184(F) OF THE CITY'S LAND DEVELOPMENT CODE; AND PROVIDING FOR AN EFFECTIVE DATE

WHEREAS, Article III of Chapter 53 of the Land Development Code of the City of Doral ("City") establishes procedures for site plan review and approval by the Mayor and City Council; and

WHEREAS, Boing US Holdco, Inc., (the "Applicant") is seeking site plan approval for the property located at 1350 NW 87 Avenue, further identified by a portion of the Miami-Dade County Property Appraiser by Folio No. 35-3033-001-0170 (the "Property"), as legally described in Exhibit "A" (the "Project"); and

WHEREAS, City staff finds that the proposed site plan, attached hereto as "Exhibit B," complies with the requirements and standards of the City's Land Development Code and Comprehensive Plan; and

WHEREAS, a zoning workshop was held on April 6, 2023, during which the public was afforded an opportunity to examine the Project and provide feedback; and

WHEREAS, after notice of public hearing duly published and notifications of all property owners of record within 500-foot radius, a public hearing was held before the Mayor and City Council on October 18, 2023, during which all interested persons were afforded the opportunity to be heard, and due and proper consideration was given to the matter, including the recommendations contained in the City's Planning and Zoning Staff Report; and

WHEREAS, the City Council reviewed the site plan application, the written and oral recommendations of the Planning and Zoning Department, including the recommended conditions, and hereby finds competent substantial evidence to find the site plan is in compliance with the City's Comprehensive Plan and Land Development Regulations, and that the site plan maintains the basic intent and purpose of the zoning, subdivision or other land use regulations, which is to protect the general welfare of the public, and further finds that the site plan application should be granted, subject to the conditions described herein.

NOW, THEREFORE, BE IT RESOLVED BY THE MAYOR AND THE CITY COUNCIL OF THE CITY OF DORAL, FLORIDA, AS FOLLOWS:

<u>Section 1.</u> Recitals. The foregoing recitals are confirmed, adopted, and incorporated herein and made as part hereof by this reference.

Section 2. Findings and Conclusions. Based upon an analysis of the site plan application and standards for approval of a site plan under the City's Land Development Regulations, the City Council hereby finds and concludes that the Applicant's request for site plan, as more particularly set forth in "Exhibit B," is in compliance with the Comprehensive Plan and the Land Development Regulations of the City, and there is substantial competent evidence to support approval of the Application.

Section 3. Approval. The Mayor and City Council hereby approve the site plan for Boing US Holdco, Inc., for the property located at 1350 NW 87 Avenue, further identified by a portion of folio number 35-3033-001-0170, as legally described in Exhibit "A." A copy of the site plan is provided in "Exhibit B." The approval of the site plan application is subject to the following conditions, which conditions shall be binding on the

Res. No. 23-186 Page **3** of **5**

Applicant, property owners, operators, and all successors in interest and assigns of the Property:

- The Project shall be built in substantial compliance with the plans entitled "Take 5 Car Wash," prepared by Pennoni Associates Inc., dated stamped received April 24, 2023.
- 2. The Project shall be landscaped in accordance with the landscape plan, signed by Michael Jason Sheridan, PE, dated stamped received April 24, 2023, as amended, and included with the site plan submittal.
- 3. The Applicant must comply with Ordinance No. 2015-09 "Public Arts Program," as amended, at the time of building permit.
- 4. The Applicant must comply with Chapter 63, "Green Building Incentives," of the City's Land Development Code at the time of building permit.
- 5. The Applicant must comply with the City's Floodplain Management regulations (Chapter 23, Article II, Floodplain Management) of the City's Code.
- 6. The Applicant must provide the Building Department a certified drainage inspection report prior to the issuance of a certificate of occupancy.
- 7. The Applicant must comply with the City of Doral Public Works Department conditions, specifically ensuring that the queue from the proposed car wash does not extend to public right-of-way or block adjacent land use drive thru.
- 8. The Applicant must comply with all the City of Doral Public Works Department conditions prior to issuance of the building permits.
- 9. The Applicant shall submit a Stormwater Pollution Prevention Plan (SWPPP) at time of building permit. The Plan should provide guidelines for implementing an erosion and sedimentation control program before the site is cleared or graded, including areas where topsoil will be removed, and contours of slopes will be cleared. The Plan shall also include location and type of erosion control measures, storm water and sediment management systems, and a vegetative plan for temporary and permanent stabilization. The Plan shall remain on-site for the duration of the construction activity.
- 10. If more than one (1) acre of land is disturbed during construction the Contractor/Applicant is responsible to obtain NPDES Stormwater permit coverage through the Florida Department of Environmental Protection

(FDEP), Construction Generic Permit (CGP). If the project is less than one (1) acre, but part of a larger common plan of development or sale that will ultimately disturb one or more acres, permit coverage is also required. Instruction to request and obtain a CGP can be found at: http://www.dep.state.fl.us/water/stormwater/npdes/docs/cgp.pdf. Contractor/Applicant should submit the Notice of Intent (NOI) with the appropriate processing fees to the NPDES Stormwater Notices Center. Contractor/Applicant must apply for permit coverage at least two (2) days before construction begins.

- 11. Construction shall be permitted only during the hours set forth in Ordinance No. 2011-01 "Noise Ordinance."
- 12. The Applicant must comply with all applicable conditions and requirements of the Miami-Dade County Department of Regulatory and Economic Resources.
- 13. The Applicant must comply with all applicable conditions and requirements of the Miami-Dade County Fire Rescue Department.
- 14. All applicable local, state and federal permits must be obtained before commencement of the development.
- 15. Issuance of this development permit by the City of Doral does not in any way create any right on the part of an Applicant to obtain a permit from a state or federal agency and does not create any liability on the part of the City of Doral for issuance of the permit if the applicant fails to obtain requisite approvals or fulfill the obligations imposed by a state or federal agency or undertakes actions that result in a violation of state or federal law.
- 16. The Applicant must obtain a Certificate of Occupancy and a Certificate of Use from the City upon compliance with all terms and conditions. The Certificate of Occupancy and Certificate of Use shall be subject to cancellation upon violation of any of the conditions.
- 17. Failure by the city to timely enforce any of the above conditions does not constitute a waiver of the same and if the applicant, its successors, or assigns, does not perform such conditions within five (5) days after written notice, the city retains the right to stop construction, if necessary, until that condition is met. The City reserves the right to enforce these conditions by issuing a code compliance citation, revoking this resolution, and/or availing itself of any and all remedies available at law or in equity. By acting under this approval, the applicant hereby consents to all these terms and conditions.

Res. No. 23-186 Page **5** of **5**

<u>Section 4.</u> <u>Effective Date.</u> This Resolution shall become effective immediately upon its adoption.

The foregoing Resolution was offered by Vice Mayor Pineyro who moved its adoption.

The motion was seconded by Councilmember Puig-Corve and upon being put to a vote, the vote was as follows:

Mayor Christi Fraga Yes
Vice Mayor Rafael Pineyro Yes
Councilwoman Digna Cabral Yes
Councilwoman Maureen Porras Not Present at Time of Vote

Councilman Oscar Puig-Corve Yes

PASSED AND ADOPTED this 18 day of October, 2023.

CHRISTI FRAGA, MAYOR

ATTEST:

CONNIE DIAZ, MMC

CITY CLERK

APPROVED AS TO FORM AND LEGAL SUFFICIENCY FOR THE USE AND RELIANCE OF THE CITY OF DORAL ONLY:

VALERIE VICENTE, ESQ. for

NABORS, GIBLIN & NICKERSON, P.A.

CITY ATTORNEY

EXHIBIT "A"

Legal Description

TO: City of Doral Planning and Zoning

FROM: Jason Sheridan, PE

DATE: October 19, 2022

SUBJECT: Take 5 Car Wash Miami

Lots 7 and 8, Block 2, EXPRESSWAY INDUSTRIAL PARK, according to the Plat thereof as recorded in Plat Book 94, Page 44, of the Public Records of Miami-Dade County, Florida



EXHIBIT "B"

TAKE 5 CAR WASH MIAMI

SITE PLAN

1350 NW 87TH AVE MIAMI MIAMI-DADE COUNTY, FL

> PREPARED FOR: OWNER/DEVELOPER

DRIVEN BRANDS

440 SOUTH CHURCH STREET, SUITE 700 **CHARLOTTE, NC 28202**

LOCATION MAP Scale: 1" = 200'

PREPARED BY: PENNONI ASSOCIATES INC.



5755 Rio Vista Dr Clearwater, FL 33760 **T** 727.451.9561 COA #00007819

CONTACTS:

LAZARO GUERRA **MIAMI DADE WATER & SEWER** 3575 S LEJEUNE RD MIAMI, FL 33146 PHONE: (786) 268-5273

FLORIDA POWER & LIGHT DADE 2 S BISCAYNE BLVD, MIAMI, FL 33131

PHONE: (386) 586-6403 **CENTURY LINK** 1025 ELDORADO BLVD

BROOMFIELD, CO 80021 PHONE: (877) 366-8344

FLORIDA CITY GAS 4045 NW 97TH AVE, DORAL, FL 33178 PHONE: (561) 755-0172 PHONE: (727) 325-1257 SURVEYOR:
ROBERT F. DuBOIS, PSM **PENNONI** 401 THIRD STREET SW,

PENNONI

ENGINEER: JASON SHERIDAN, P.E.

5755 RIO VISTA DRIVE CLEARWATER, FL 33760

WINTER HAVEN, FL 33880

PHONE: (863) 324-1112 APPLICANT: MATTHEW GILBERT **DRIVEN BRANDS**

440 SOUTH CHURCH STREET, ST 700 CHARLOTTE, NC 28202 EMAIL:MATTHEW.GILBERT@DRIVENBRANDS.COM

ARCHITECT: TIFFANY ROTH **ROGUE ARCHITECTS** 513 MAIN STREET, ST. 200 FORT WORTH, TX 76102

EMAIL: TIFFANY@ROGUEARCHITECTS.COM

SHEET INDEX


SHEET #	SHEET DESCRIPTION
CS0001	COVER SHEET
V-0301	ALTA/NSPS LAND TITLE SURVEY
CS0201	EXISTING CONDITIONS PLAN
CS0501	DEMOLITION & EROSION CONTROL PLAN
CS0502	EROSION CONTROL NOTES & DETAILS
CS1000	SITE PLAN
CS1200	CIRCULATION PLAN
CS1501	GRADING AND DRAINAGE PLAN
CS1701	UTILITY PLAN
CS2001	LANDSCAPE PLAN
CS2002	IRRIGATION PLAN
CS2501	LANDSCAPE DETAILS
CS6001	SITE DETAILS
CS6002	SITE DETAILS
CS6003	UTILITY DETAILS
CS6004	UTILITY DETAILS

DATE	XX-XX-XX	XX-XX-XX	XX-XX-XX	XX-XX-XX	XX-XX-XX	XX-XX-XX	
DESCRIPTION							
	×	×	×	×	×	×	

WASH 5

ENGINEER:



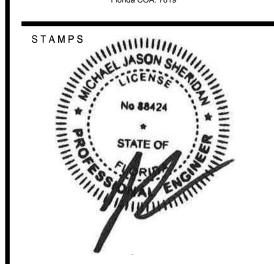


COVER SHEET

PROJECT NUMBER
DRVBR22027

SHEET NO



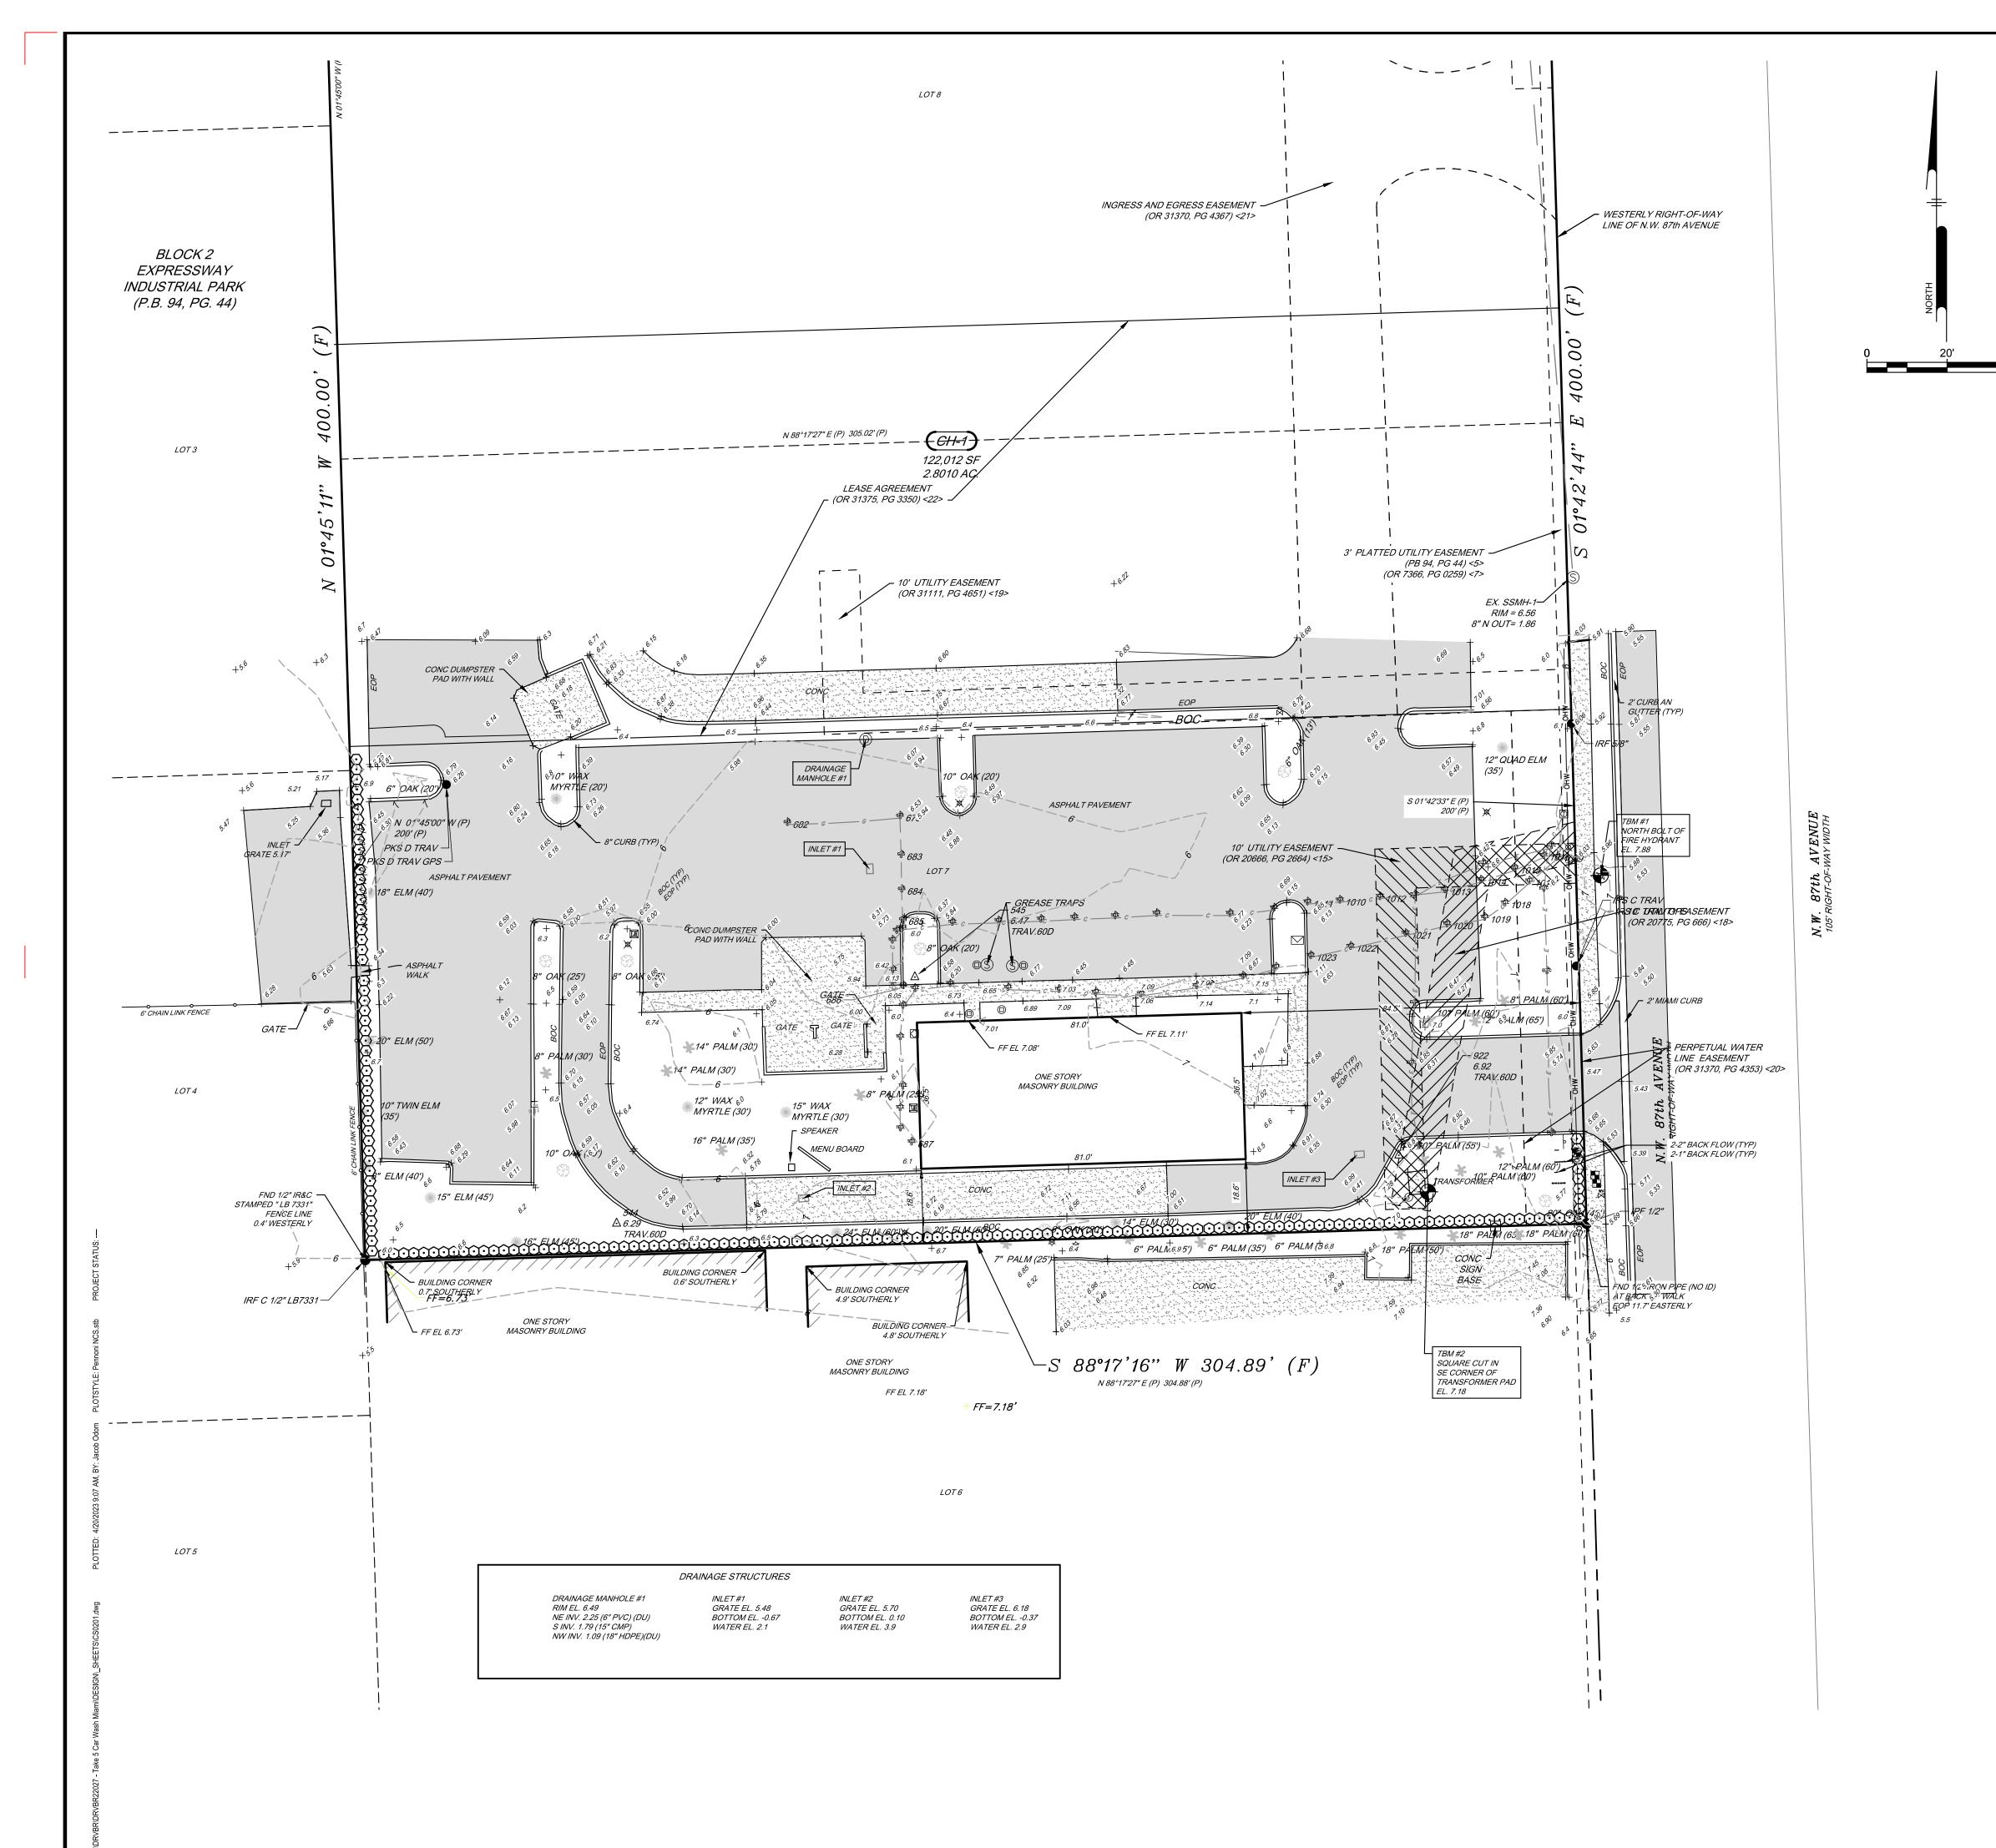

EXISTING LEGEND

EXISTING	LEGEND
	PROPERTY LINE
	PROPERTY ADJOINING
	LEGAL RIGHT-OF-WAY EASEMENT
•	PROPERTY MARKER
	EXISTING BUILDING
	EXISTING CURB
	EXISTING CURB DEPRESSION EXISTING EDGE OF PAVEMENT
	EXISTING EDGE OF PAVEMENT EXISTING EDGE OF GRAVEL
	EXISTING EDGE OF GRAVEE
	EXISTING WOOD FENCE
	EXISTING WEGGET ENCE
<u> </u>	EXISTING GUIDE RAIL
101	EXISTING MINOR CONTOUR
100	EXISTING MAJOR CONTOUR
\times 0.00	EXISTING SPOT ELEVATION
c c c	EXISTING COMMUNICATION, UNDERGROUND
G G	EXISTING NATURAL GAS, UNDERGROUND
E E	EXISTING POWER, UNDERGROUND
sss	EXISTING SANITARY SEWER, UNDERGROUND
D D	EXISTING STORM SEWER, UNDERGROUND
w w	EXISTING WATER, UNDERGROUND
——————————————————————————————————————	EXISTING OVERHEAD UTILITY
(C) (G) (E) (S)	EXISTING MANHOLES
$\mathbb{S}\mathbb{D} \mathbb{W} \mathbb{U}$	EXISTING WANTELES
	EXISTING VALVES
	EXISTING JUNCTION BOX
4	EXISTING POWER, TRANSFORMER
\bigcap	EXISTING SANITARY SEWER, CLEAN-OUT
	EXISTING STORM SEWER, ROOF DRAIN
	EXISTING STORM SEWER, INLET
- / - \(\(\)	EXISTING WATER STRUCTURES
.mmmmmmmmmmmmmmmmmmmmmmmmmmmmmmmmmmmmm	EXISTING TREE LINE
(\cdot)	EXISTING EXISTING TREES
	EXISTING BOLLARD
-	EXISTING SIGN
\sim	EXISTING UTILITY POLE
<u> </u>	EXISTING GUY POLE
•	BORING LOCATION
9 →	EXISTING FLAG POLE
~ \\ -	EXISTING LIGHT
	EXISTING LIGHT POLE SINGLE ARM

SITE INFORMATION:

1350 NW 87TH AVENUE MIAMI, FL 33172

DRIVEN BRANDS (BOING US HOLDCO, INC) APPLICANT:

440 SOUTH CHURCH STREET, SUITE 700 CHARLOTTE, NC 28202

OWNER: LAPCIUC GROUP INC

6699 NW 36 AVE

MIAMI FL 33147

ENGINEER: PENNONI

JASON SHERIDAN, PE

5755 RIO VISTA DRIVE CLEARWATER, FL 33760

GENERAL NOTES:

- 1. BOUNDARY AND TOPOGRAPHICAL INFORMATION OBTAINED FROM "ALTA/NSPS LAND TITLE SURVEY" PERFORMED BY PENNONI ASSOCIATES.
- 2. LOCATIONS OF ON AND OFF SITE UTILITIES AS SHOWN ARE APPROXIMATE AND MAY OR MAY NOT BE COMPLETE. THE NATURE AND EXACT LOCATION OF EXISTING UTILITIES SHOULD BE VERIFIED PRIOR TO INITIATING ANY ACTIVITY THAT MAY AFFECT THEIR USE OR LOCATION.
- 3. THE LOCATION OF THE EXISTING UNDERGROUND UTILITIES SHOWN ON THIS PLAN HAVE BEEN TAKEN FROM EXISTING UTILITY RECORDS AVAILABLE AT THE TIME THESE PLANS WERE PREPARED AND FROM SURFACE OBSERVATION OF THE SITE.
- 4. COMPLETENESS OR ACCURACY OF LOCATION AND DEPTH OF UNDERGROUND UTILITIES AND STRUCTURES IS NOT GUARANTEED.
- 5. IN ACCORDANCE WITH "UNDERGROUND FACILITY DAMAGE PREVENTION AND SAFETY ACT" FLORIDA STATUTES, CHAPTER 556. THE CONTRACTOR SHALL NOTIFY ALL UTILITIES WITHIN THE WORK AREA VIA THE SUNSHINE ONE CALL SYSTEM, INC. (800-432-4770) A MINIMUM OF 2 WORKING DAYS BEFORE THE START OF EXCAVATION
- 6. THE CONTRACTOR SHALL VERIFY LOCATIONS AND DEPTHS OF ALL UNDERGROUND UTILITIES AND STRUCTURES BEFORE THE START OF WORK.
- 7. THIS SITE IS CURRENTLY ZONED IC- INDUSTRIAL
- COMMERCIAL
- 8. VERTICAL DATUM IS BASED ON FLORIDA DEPARTMENT OF TRANSPORTATION, DISTRICT 6, BENCHMARK NUMBER "N-465-R-NEW", WITH A PUBLISHED ELEVATION OF 7.97 FEET, AS REFERENCED TO THE NORTH AMERICAN VERTICAL DATUM 1988 (NAVD'88)
- 9. HORIZONTAL COORDINATE DATUM IS IN FLORIDA STATE PLANE COORDINATE SYSTEM WEST ZONE, NORTH AMERICAN DATUM 1983 BASED ON GPS OBSERVATION.
- 10. ELEVATIONS BASED ON NORTH AMERICAN VERTICAL DATUM 1988 (NAVD 88). FLORIDA DEPARTMENT OF TRANSPORTATION, DISTRICT 6, BENCHMARK NUMBER "N-465-R-NEW", ELEVATION 7.97 FEET, CONVERSION EQUATION TO NATIONAL GEODETIC VERTICAL DATUM 1929 (NGVD 29): NAVD88 + 1.18' = NGVD 29.

FLOOD ZONE INFORMATION:

THE PROPERTY SHOWN LIES IN ZONE "AH" (EL. 8), AS SHOWN ON THE FLOOD INSURANCE RATE MAP, COMMUNITY PANEL NO. 12086C0287L WITH AN EFFECTIVE DATE OF 9/11/2009, AS PREPARED BY THE FEDERAL EMERGENCY AGENCY.

CLIENT




XX-XX-XX	XX-XX-XX	XX-XX-XX	XX-XX-XX	XX-XX-XX	
×	×	×	×	×	
2	3	4	2	9	
	×	× ×	× × ×	× × × ×	× × × × ×

ENGINEER:



PENNONI ASSOCIATES INC. 5755 Rio Vista Drive Clearwater, FL 8772 Florida COA: 7819

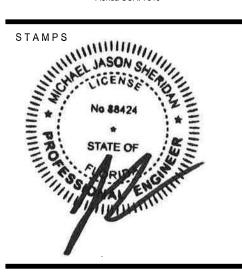


EXISTING CONDITIONS

PROJECT NUMBER **DRVBR22027**

SHEET NO

08-01-2022 DATE AS NOTED SCALE DRAWN CHECKED

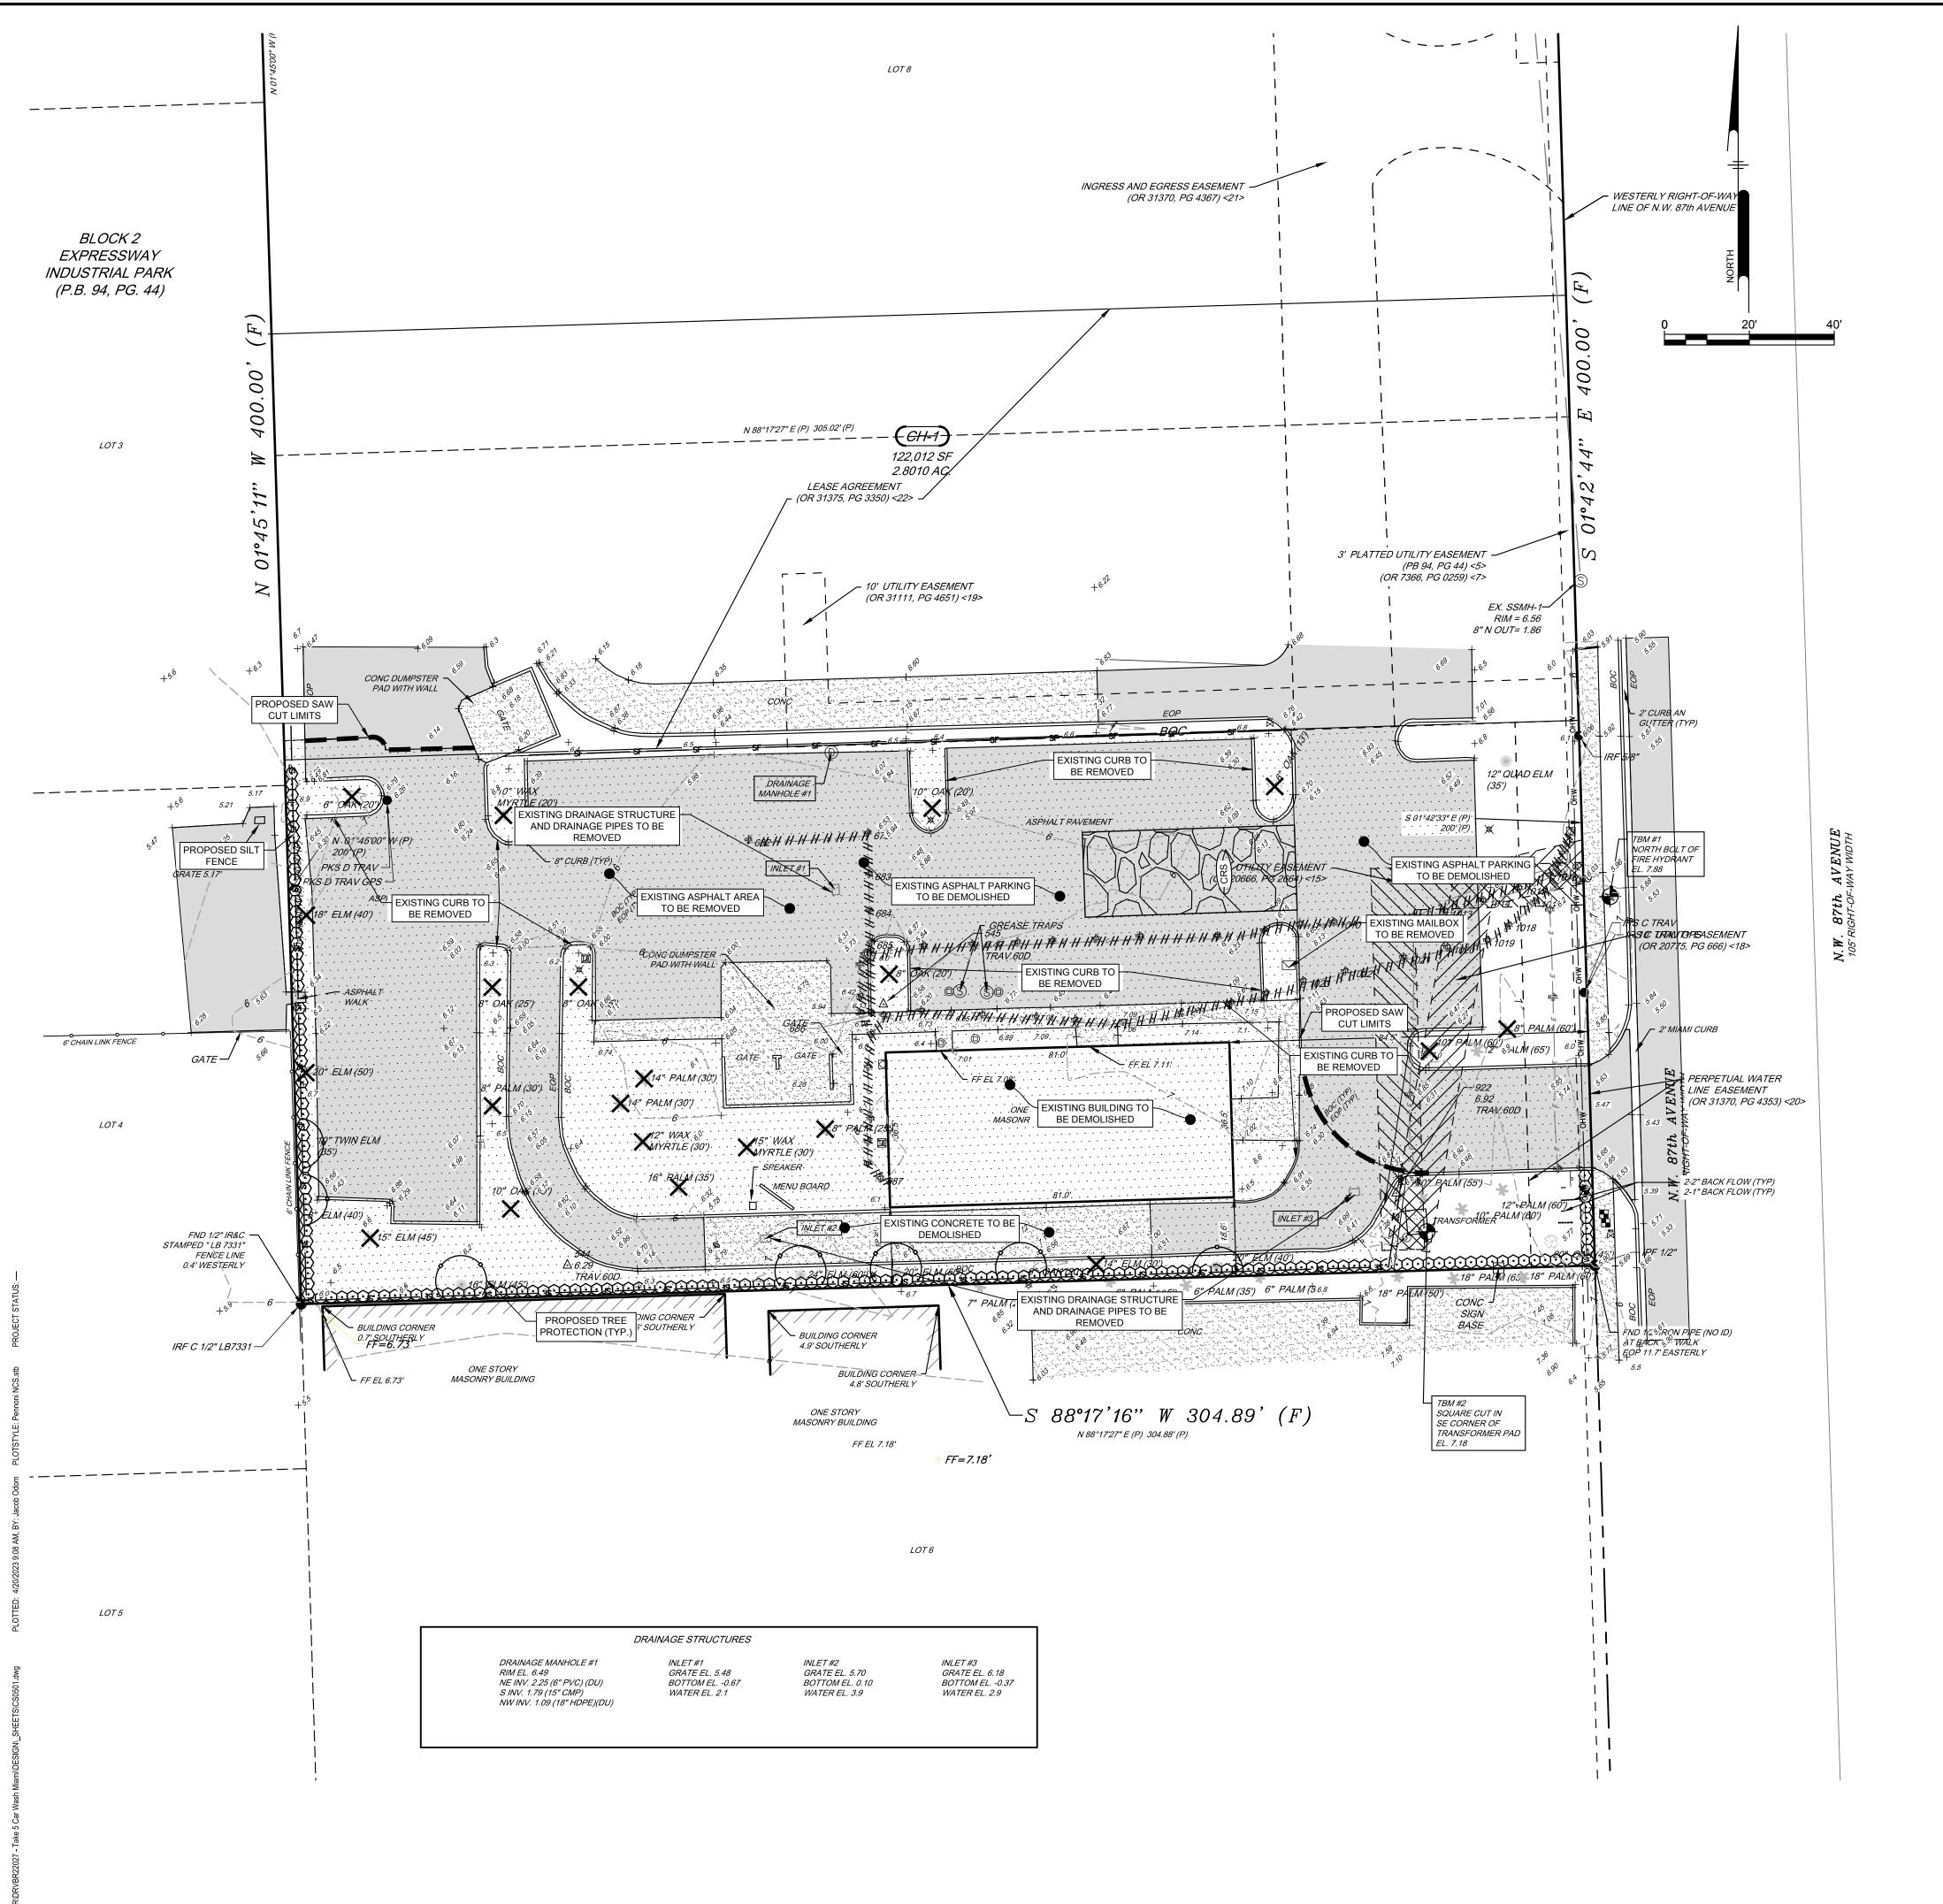

EXISTING LEGEND

	PROPERTY LINE
	PROPERTY ADJOINING
	LEGAL RIGHT-OF-WAY
	EASEMENT
	PROPERTY MARKER
7/////////////	EXISTING BUILDING
	EXISTING CURB
	EXISTING CURB DEPRESSION
	EXISTING EDGE OF PAVEMENT
	EXISTING EDGE OF GRAVEL
	EXISTING FENCE
	EXISTING WOOD FENCE
	EXISTING METAL FENCE
	EXISTING GUIDE RAIL EXISTING MINOR CONTOUR
101	EXISTING MAJOR CONTOUR
	EXISTING MAJOR CONTOOR EXISTING SPOT ELEVATION
c c c	EXISTING COMMUNICATION, UNDERGROUND
G G G	EXISTING NATURAL GAS, UNDERGROUND
E E E	EXISTING POWER, UNDERGROUND
sss	EXISTING SANITARY SEWER, UNDERGROUND
D D	EXISTING STORM SEWER, UNDERGROUND
w w	EXISTING WATER, UNDERGROUND
——————————————————————————————————————	EXISTING OVERHEAD UTILITY
(C) (G) (E) (S)	EXISTING MANHOLES
(\widehat{SI}) (\widehat{D}) (\widehat{W}) (\widehat{U})	EXISTING WANHOLES
	EXISTING VALVES
	EXISTING JUNCTION BOX
4	EXISTING POWER, TRANSFORMER
\bigcirc	EXISTING SANITARY SEWER, CLEAN-OUT
	EXISTING STORM SEWER, ROOF DRAIN
	EXISTING STORM SEWER, INLET
- ⟨ - ⟨ ⟨ ⟨ ⟨ ⟨ ⟨ ⟨ ⟨ ⟨ ⟨ 	EXISTING WATER STRUCTURES
	EXISTING TREE LINE
	EXISTING EXISTING TREES
•	EXISTING BOLLARD
- 0-	EXISTING SIGN
Ø	EXISTING UTILITY POLE
-①	EXISTING GUY POLE
•	BORING LOCATION
	EXISTING FLAG POLE
÷	EXISTING LIGHT
~~~	EXISTING LIGHT POLE SINGLE ARM
$\sim$	L.USTING LIGHT OLD SHIGLE / WINT

**DEMOLITION NOTES:** 

REMOVED.


- 1. SITE CONTRACTOR SHALL BE RESPONSIBLE FOR DISCONNECTION OF ALL UTILITIES ON SITE TO BE
- 2. ALL DEMOLITION TO BE PERFORMED BY A QUALIFIED, LICENSED CONTRACTOR IN ACCORDANCE WITH ALL APPLICABLE LOCAL, STATE, AND FEDERAL CODES AND REGULATIONS. ALL DEBRIS TO BE REMOVED FROM THE SITE AND DISPOSED OF IN ACCORDANCE WITH ALL APPLICABLE LOCAL, STATE, AND FEDERAL REGULATIONS.
- 3. ALL UTILITIES SHALL BE DISCONNECTED AND REMOVED IN ACCORDANCE WITH ALL APPLICABLE LOCAL, STATE, AND FEDERAL REGULATIONS.
- 4. ANY PUBLIC UTILITIES DAMAGED DURING DEMOLITION AND CONSTRUCTION SHALL BE REPAIRED AND/OR REPLACED IN KIND BY THE CONTRACTOR AT HIS OWN EXPENSE. UTILITY REMOVAL SHALL BE IN
- ACCORDANCE WITH THE REQUIREMENTS OF THE UTILITY COMPANY. 5. ALL OPENINGS IN STORM SEWER STRUCTURES RESULTING FROM PIPE REMOVAL SHALL BE FILLED WITH
- SEWER BRICK AND MORTAR OR REPLACED, AS DIRECTED BY THE CITY ENGINEER. 6. STORMWATER AND SANITARY LINES, STRUCTURES AND APPURTENANCES SHALL BE REMOVED IN THEIR
- 7. ALL EXISTING BUILDING CONCRETE FOUNDATIONS AND FOOTINGS ARE TO BE REMOVED IN THEIR ENTIRETY. ALL SITE STRUCTURES AND IMPROVEMENTS WITHIN THE LIMIT OF DEMOLITION SHALL BE
- REMOVED IN THEIR ENTIRETY, INCLUDING FOUNDATIONS UNLESS NOTED OTHERWISE. 8. TREES TO BE REMOVED SHALL INCLUDE REMOVAL AND DISPOSAL OF TREES AND STUMPS.
- 9. DUST CONTROL DEMOLITION CONTRACTOR IS RESPONSIBLE FOR WETTING DUST GENERATING DEBRIS FROM TIME OF FIRST CONTACT UNTIL PLACING INTO APPROPRIATE WASTE OR HAULING CONTAINERS OR TRUCKS. DEBRIS SHALL NOT BE ALLOWED TO DRY BEFORE REMOVAL FROM SITE.
- 10. WATER FOR DUST CONTROL DEMOLITION CONTRACTOR IS RESPONSIBLE FOR PROVIDING WATER TANK / PUMP TRUCKS IF ON-SITE WATER FLOW OR PRESSURE IS NOT SUFFICIENT FOR OPERATIONS.
- 11. CONTAMINATED SOIL IF UNUSUAL STAINS OR ODORS ARE DETECTED IN SOILS, CEASE OPERATIONS AND NOTIFY THE EHS IMMEDIATELY. 12. ANY EXCAVATION OR IMPACTS TO THE ROOT SYSTEM OF ANY TREE TO REMAIN MAY REQUIRE ROOT
- PRUNING, EVEN IF IT IS OUTSIDE OF THE TREE BARRICADE AREA. DO NOT TRENCH UNDER TREES. 13. EROSION CONTROL IS PERFORMANCE BASED. ADDITIONAL EROSION CONTROL MAY BE REQUIRED IF ANYTHING OTHER THAN CLEAN STORMWATER IS LEAVING THE SITE.
- 14. A PRE-CONSTRUCTION MEETING SHALL BE SET UP TO DISCUSS THESE AND OTHER ISSUES RESULTING IN THIS CONSTRUCTION PROJECT. THIS SHALL BE COORDINATED THROUGH THE CONSTRUCTION SITE PROJECT MANAGER.
- 15.FIRE DEPARTMENT ACCESS AND WATER SUPPLY SHALL BE ESTABLISHED BEFORE ANY VERTICAL CONSTRUCTION BEINGS. THE CONNECTION SHALL MEET THE REQUIREMENTS OF NFPA 1 2015 EDITION, CHAPTER 18.
- 16. CONSTRUCTION SHALL MEET THE REQUIREMENTS OF NFPA 1 2013 EDITION CHAPTER 16 FIRE SPRINKLER PROTECTION. SAFEGUARDING CONSTRUCTION, ALTERATION, AND DEMOLITION OPERATIONS TO INCLUDE BUT NOT BE LIMITED TO COMPLYING WITH NFPA 241. ESTABLISHING A FIRE PROTECTION PLAN. PROVIDING AND MAINTAINING ADEQUATE ESCAPE FACILITIES, PROVIDING AND MAINTAINING FIRE DEPARTMENT ACCESS ROADS THROUGHOUT THE ENTIRE PROJECT, PROVIDING STAIRS, STANDPIPE, AND FIRE SPRINKLER PROTECTION AS THE BUILDING PROGRESSES. A PRE-CONSTRUCTION MEETING SHALL BE SET UP TO DISCUSS THESE AND OTHER ISSUES RESULTING IN THIS CONSTRUCTION PROJECT. THIS SHALL BE COORDINATED THROUGH THE CONSTRUCTION SITE PROJECT MANAGER. WHERE UNDERGROUND WATER MAINS AND HYDRANTS ARE TO BE INSTALLED, THEY SHALL BE INSTALLED, COMPLETED AND IN SERVICE PRIOR TO CONSTRUCTION AS PER NFPA-241.ALL UNDERGROUND FIRE LINES MUST BE INSTALLED PER NFPA-24 2013 EDITION BY A LICENSED CLASS 1, 2, OR 5 FIRE PROTECTION SYSTEM CONTRACTOR WITH SEPARATE PERMIT AND PLANS.

CLIENT



PENNONI ASSOCIATES INC. 5755 Rio Vista Drive Florida COA: 7819


STAMPS

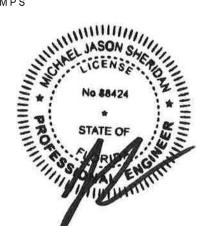


**DEMOLITION & EROSION CONTROL PLAN** 


PROJECT NUMBER **DRVBR22027** 08-01-2022 DATE AS NOTED SCALE


DRAWN CHECKED SHEET NO

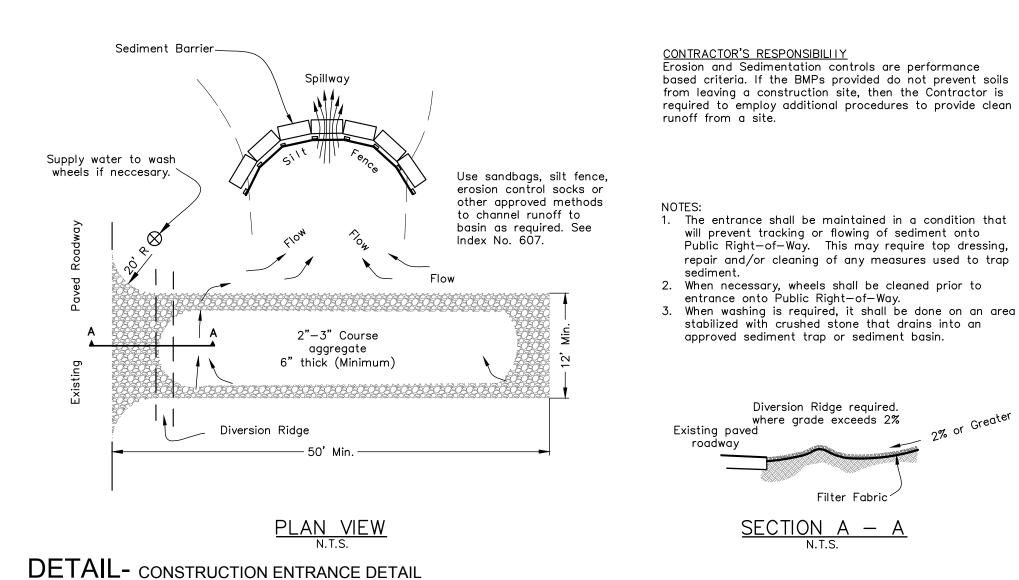

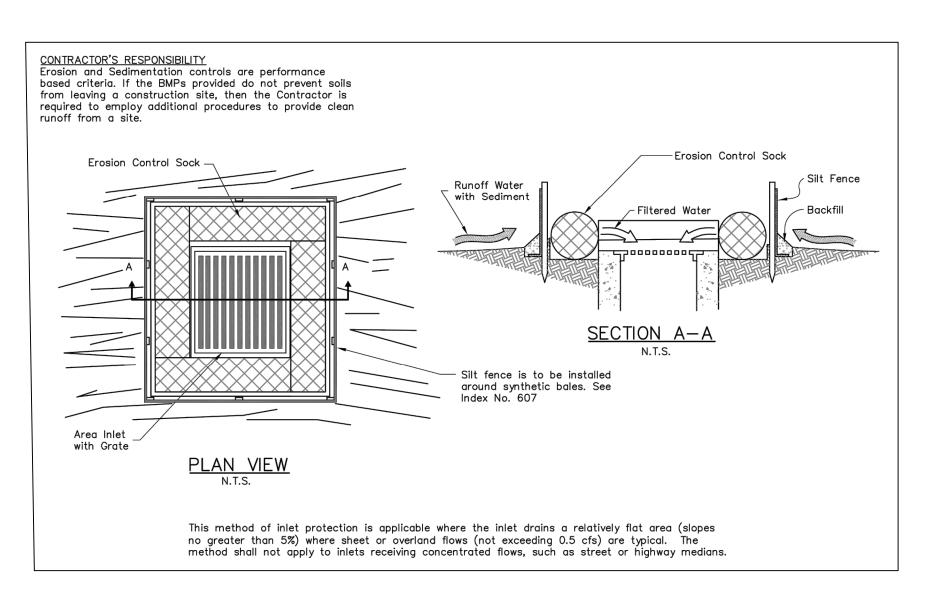

#### **DETAIL-** INLET SEDIMENT BARRIER(INDEX 608)

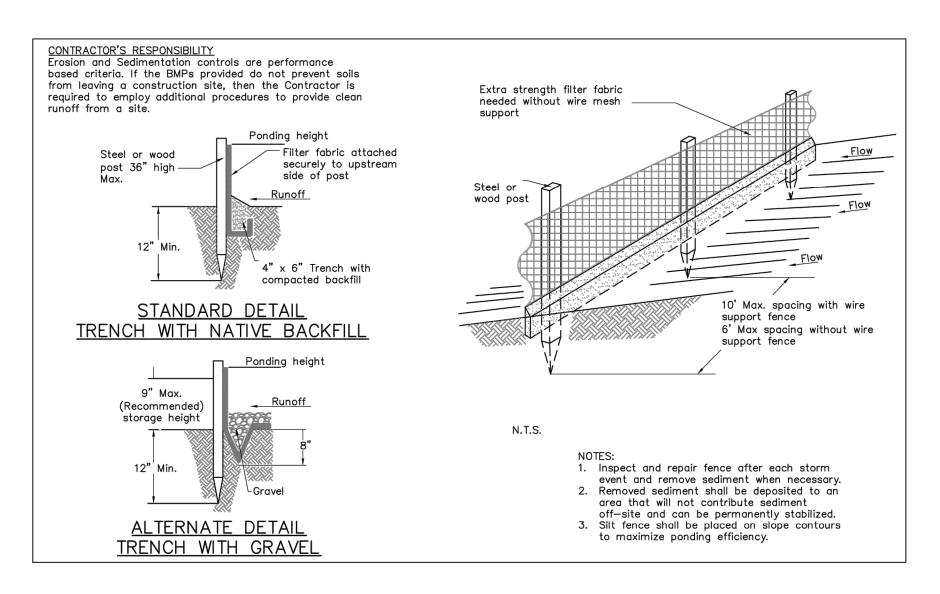


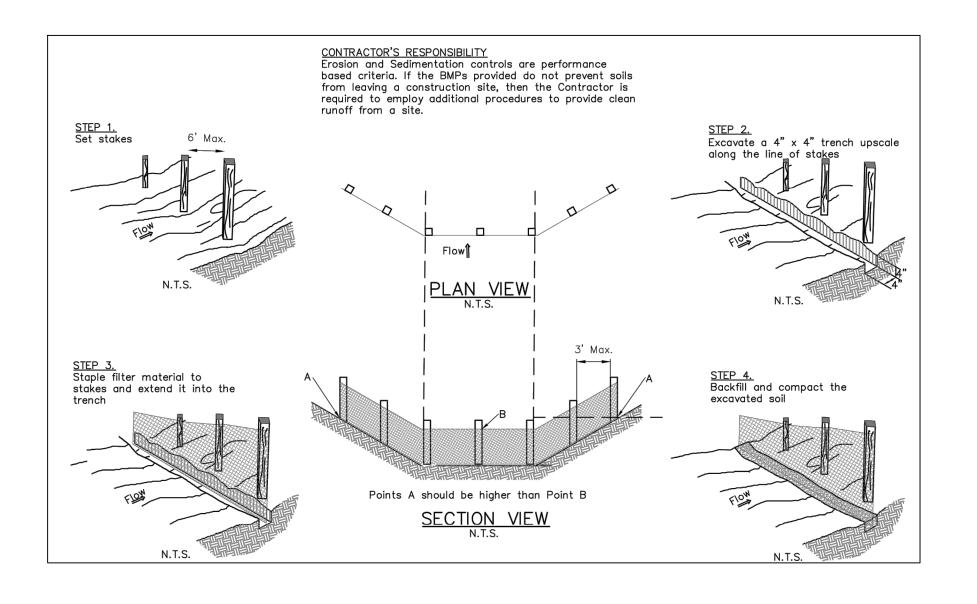

#### **DETAIL-** STAKED SILT BARRIER

N.T.S.

N.T.S.

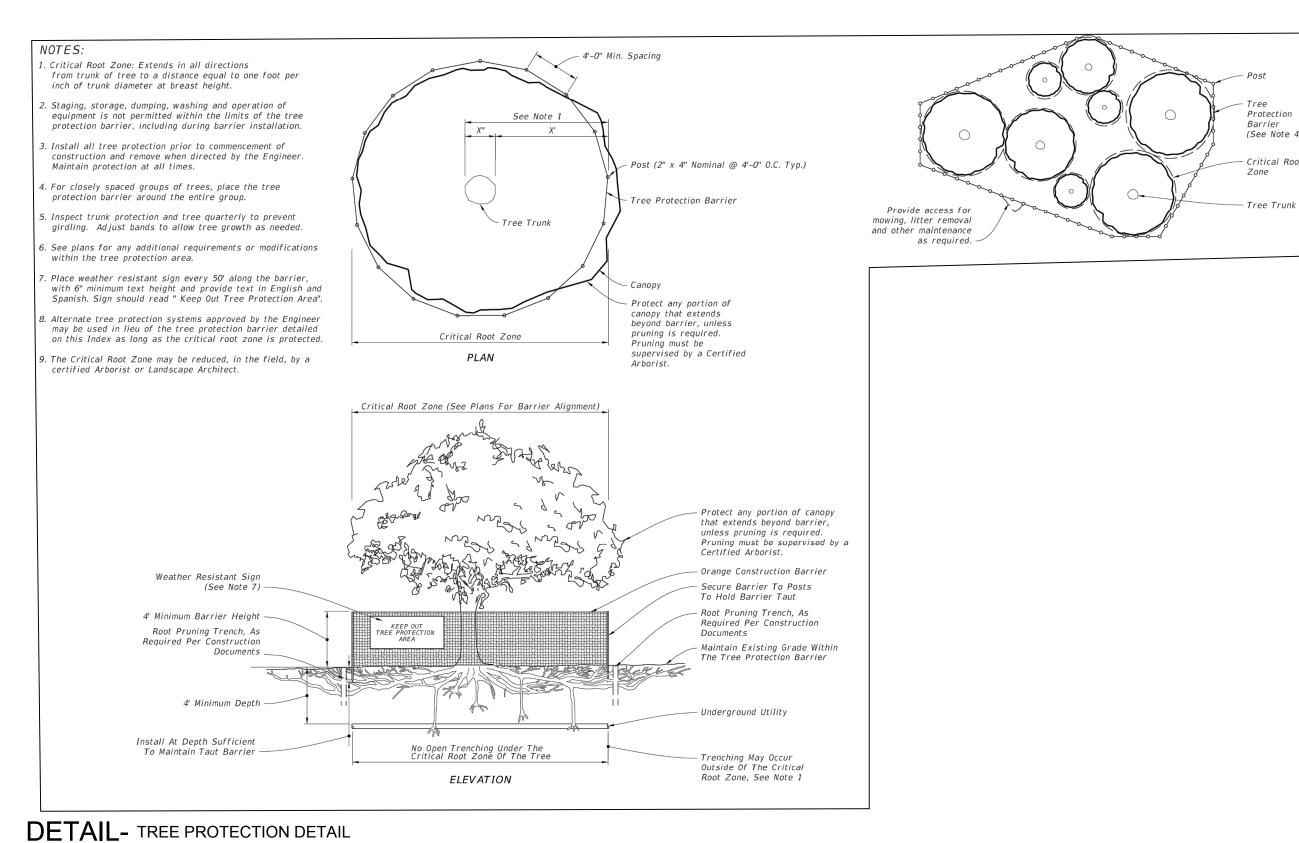

#### **EROSION AND SEDIMENTATION CONTROL NOTES**

- 1. IT IS THE RESPONSIBILITY OF THE CONTRACTOR TO CONTROL AND PREVENT EROSION AND THE TRANSPORTATION OF SEDIMENT TO SURFACE DRAINS AND OUTFALLS. REFER TO CONSTRUCTION PLANS, DETAILS, SPECIFICATIONS AND APPROVED PERMITS FOR DETAILS. SEDIMENT DEPOSITS SHALL BE REMOVED WHEN THEY REACH SIX INCHES ON AN EROSION DEVICE.
- 2. DURING THE CONSTRUCTION OF DRAINAGE STRUCTURES, AND OTHER STRUCTURES REQUIRING EXCAVATION, THE CONTRACTOR SHALL PLACE APPROVED BARRIERS OR OTHER APPROVED DEVICES AROUND SUCH STRUCTURES TO PREVENT EROSION AND THE MIGRATION OF SEDIMENT TO POINTS OUTSIDE THE CONSTRUCTION AREA. THE APPROVED BARRIERS OR OTHER APPROVED DEVICES SHALL BE PLACED IN ACCORDANCE WITH REQUIREMENTS OF F.D.O.T. INDEX NO. 102, FDEP, OR AS DIRECTED BY THE ENGINEER.
- 3. REQUIRED EROSION CONTROL MEASURES MUST REMAIN INTACT THROUGHOUT CONSTRUCTION. FAILURE TO INSTALL OR PROPERLY MAINTAIN REQUIRED EROSION CONTROL WILL RESULT IN ENFORCEMENT. ALL EROSION CONTROL MEASURES, SAND, SILT, AND DEBRIS SHALL BE REMOVED FROM ALL DRAINAGE PIPES AND STRUCTURES AFTER CONSTRUCTION HAS BEEN COMPLETED AND PRIOR TO CITY FINAL WALK-THROUGH.
- 4. OUTFALL PROTECTION PROJECT PIPE OR DITCH DISCHARGES INTO OFF-SITE OUTFALLS SHALL BE INSPECTED DAILY FOR POSSIBLE SEDIMENT BUILDUP OR TRANSPORT. OUTFALLS SHALL BE PROTECTED THROUGH USE OF EROSION CONTROL FEATURES AS NECESSARY TO CONTAIN ANY SEDIMENT LOSS TO THE IMMEDIATE AREA OF THE PROJECT. ANY SEDIMENT BUILDUP OR TRANSPORT OFF-SITE SHALL BE THE CONTRACTOR'S RESPONSIBILITY TO REMEDY. THE CONTRACTOR SHALL USE APPROPRIATE MEASURES AS DIRECTED BY THE PROJECT ENGINEER FOR OUTFALL PROTECTION.
- 5. APPROVED BARRIERS (OR OTHER APPROVED SEDIMENT CONTROL DEVICES): THESE SHALL BE PLACED AT THE BASE OF ANY SLOPE WHERE A RAINFALL EVENT COULD ERODE A SLOPE AND TRANSPORT SEDIMENTS OFF-SITE. APPROVED BARRIERS SHALL BE DOUBLE STAKED IN ACCORDANCE WITH F.D.O.T. INDEX NO. 102 OR FDEP. IF EROSION DEPOSITS REACH THE TOP ELEVATION OF EXISTING APPROVED BARRIERS, THEN SEDIMENTS SHOULD BE REMOVED. ANY DAMAGED OR INEFFECTIVE APPROVED BARRIERS ARE TO BE REPLACED WITH NEW ONES. THE LOCATION AND INSTALLATION OF APPROVED BARRIERS SHALL BE AS DIRECTED BY THE PROJECT ENGINEER.
- 6. BACK OF SIDEWALK INLETS OR MEDIAN INLETS: THESE SHALL BE PROTECTED FROM SEDIMENT INTAKE UNTIL PROJECT IS COMPLETE. ELEVATION OF GROUND OUTSIDE INLET TOP SHALL NOT BE HIGHER THAN INLET TOP. APPROVED BARRIERS OR OTHER APPROVED SEDIMENT CONTROL DEVICES SHALL BE INSTALLED AROUND INLET TOP. A SECOND ROW OF APPROVED BARRIERS OR OTHER APPROVED SEDIMENT CONTROL DEVICES SHALL BE PLACED AROUND INLET APPROXIMATELY 4" OUTSIDE FIRST ROW. BETWEEN ROWS THERE SHALL BE A DEPRESSION TO ACT AS A SEDIMENT BASIN. COMPLETED INLETS IN PAVED AREAS SHALL ALSO BE PROTECTED WITH A SINGLE LINE OF APPROVED BARRIERS OR OTHER APPROVED SEDIMENT CONTROL DEVICES TO PREVENT SEDIMENT INTAKE FROM OTHER AREAS.
- 7. STOCKPILED MATERIALS SHALL BE PROTECTED BY COVER, APPROVED BARRIERS OR OTHER APPROVED SEDIMENT CONTROL DEVICES.
- 8. ALL DISTURBED AREAS SHALL BE STABILIZED WITHIN 3 DAYS AFTER 1/2" RAIN EVENT DISTURBANCE.
- 9. CONTRACTOR IS RESPONSIBLE FOR OBTAINING THE NECESSARY DEWATERING PERMITS FROM THE LOCAL WATER MANAGEMENT DISTRICT OR OTHER REGULATORY AGENCY.
- 10. A DEWATERING PLAN MUST BE SUBMITTED AND APPROVED BY THE ENGINEER PRIOR TO DISCHARGE.
- 11. IF WIND EROSION BECOMES SIGNIFICANT DURING CONSTRUCTION, THE CONTRACTOR SHALL STABILIZE THE AFFECTED AREA USING SPRINKLING, IRRIGATION, OR OTHER ACCEPTABLE
- 12. THERE IS TO BE NO DISCHARGE (I.E. PUMPING, SHEET FLOW, SWALE, DITCH, ETC.) INTO EXISTING DITCHES OR CANALS WITHOUT THE USE OF SETTLING PONDS OR DEVICES. IF THE CONTRACTOR DESIRES TO DISCHARGE INTO EXISTING DITCHES OR CANALS A SETTLING PLAN PREPARED BY THE CONTRACTOR MUST BE SUBMITTED TO AND APPROVED BY THE ENGINEER OF RECORD AND LOCAL REGULATORY AGENCY PRIOR TO CONSTRUCTION.
- 13. WHERE APPLICABLE, SOIL TRACKING PREVENTION DEVICES SHALL BE PROVIDED AND MAINTAINED PER F.D.O.T. INDEX NO. 106 OR FDEP.
- 14. ALL EROSION CONTROL FENCES, BARRIERS, AND SILTATION DEVICES SHALL BE ERECTED PRIOR TO ANY LAND ALTERATIONS, SHALL BE MAINTAINED IN GOOD WORKING ORDER DURING CONSTRUCTION, AND REMOVED FOLLOWING SOIL STABILIZATION AND FINAL DRESSING. BUILT-UP SEDIMENT WILL BE REMOVED FROM SILT FENCES AND STAKED TURBIDITY BARRIERS WHEN IT HAS REACHED ONE THIRD THE HEIGHT OF THE FENCE/BARRIER. STOCKPILE AREAS SHALL INCLUDE SILT FENCE AROUND THE PERIMETER.
- 15. THE CONTRACTOR SHALL NOT RESTRICT OR BLOCK THE EXISTING DRAINAGE FLOW OVERLAND OR WITHIN RESHAPED SWALES. FLOW WITHIN EXISTING DRAINAGE PIPES SHALL BE MAINTAINED AT ALL TIMES. STORMWATER WILL BE CONVEYED VIA EXISTING SWALES, DITCHES, OR PROPOSED DITCHES, EXISTING AND PROPOSED STORM SEWERS.
- 16. DURING DEWATERING OPERATIONS, THE CONTRACTOR SHALL NOT DISCHARGE DIRECTLY TO RECEIVING WATERS, EXISTING CONVEYANCES TO RECEIVING WATERS, OR WETLAND SYSTEMS. TEMPORARY SEDIMENT BASINS, TRAPS, OR SILTATION REDUCTION DEVICES SHALL BE UTILIZED TO COLLECT THE DISCHARGE FROM DEWATERING ACTIVITIES TO ELIMINATE THE POTENTIAL FOR OFF-SITE SEDIMENT TRANSPORT AND TO INSURE THAT DIRECT DISCHARGE DOES NOT
- 17. BANKS SHALL BE PROTECTED FROM EROSION OR COLLAPSE DURING CONSTRUCTION. BANK PROTECTION MATERIAL SHALL BE CAREFULLY PLACED FROM THE BANK AND NOT DUMPED FROM ABOVE IN AN UNCONTROLLED MANNER. EROSION CONTROL FABRIC SHALL BE USED FOR EROSION PROTECTION WHERE SOD WILL NOT HOLD OR BECOME ESTABLISHED IN TIME TO PROTECT THE BANKS. UNLESS OTHERWISE SPECIFIED IN THE PLANS, UPON COMPLETION OF CONSTRUCTION, ALL BANKS AND WATERWAYS SHALL BE RESTORED TO THEIR PRECONSTRUCTION CONFIGURATION AND PROTECTION FROM EROSION.



DATE	XX-XX-XX	XX-XX-XX	XX-XX-XX	XX-XX-XX	XX-XX-XX	XX-XX-XX	
DESCRIPTION							
	×	×	×	×	×	×	
DELTA	_	2	3	4	2	9	


1350 NW 87TH AVENUE MIAMI, FL

Pennoni

<

PENNONI ASSOCIATES INC.

5755 Rio Vista Drive
Clearwater, FL 8772
Florida COA: 7819

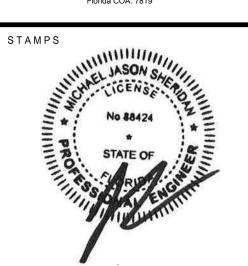


EROSION CONTROL NOTES AND DETAILS

DRVBR22027

DATE 08-01-2022

SCALE AS NOTED
DRAWN JO
CHECKED JS
SHEET NO

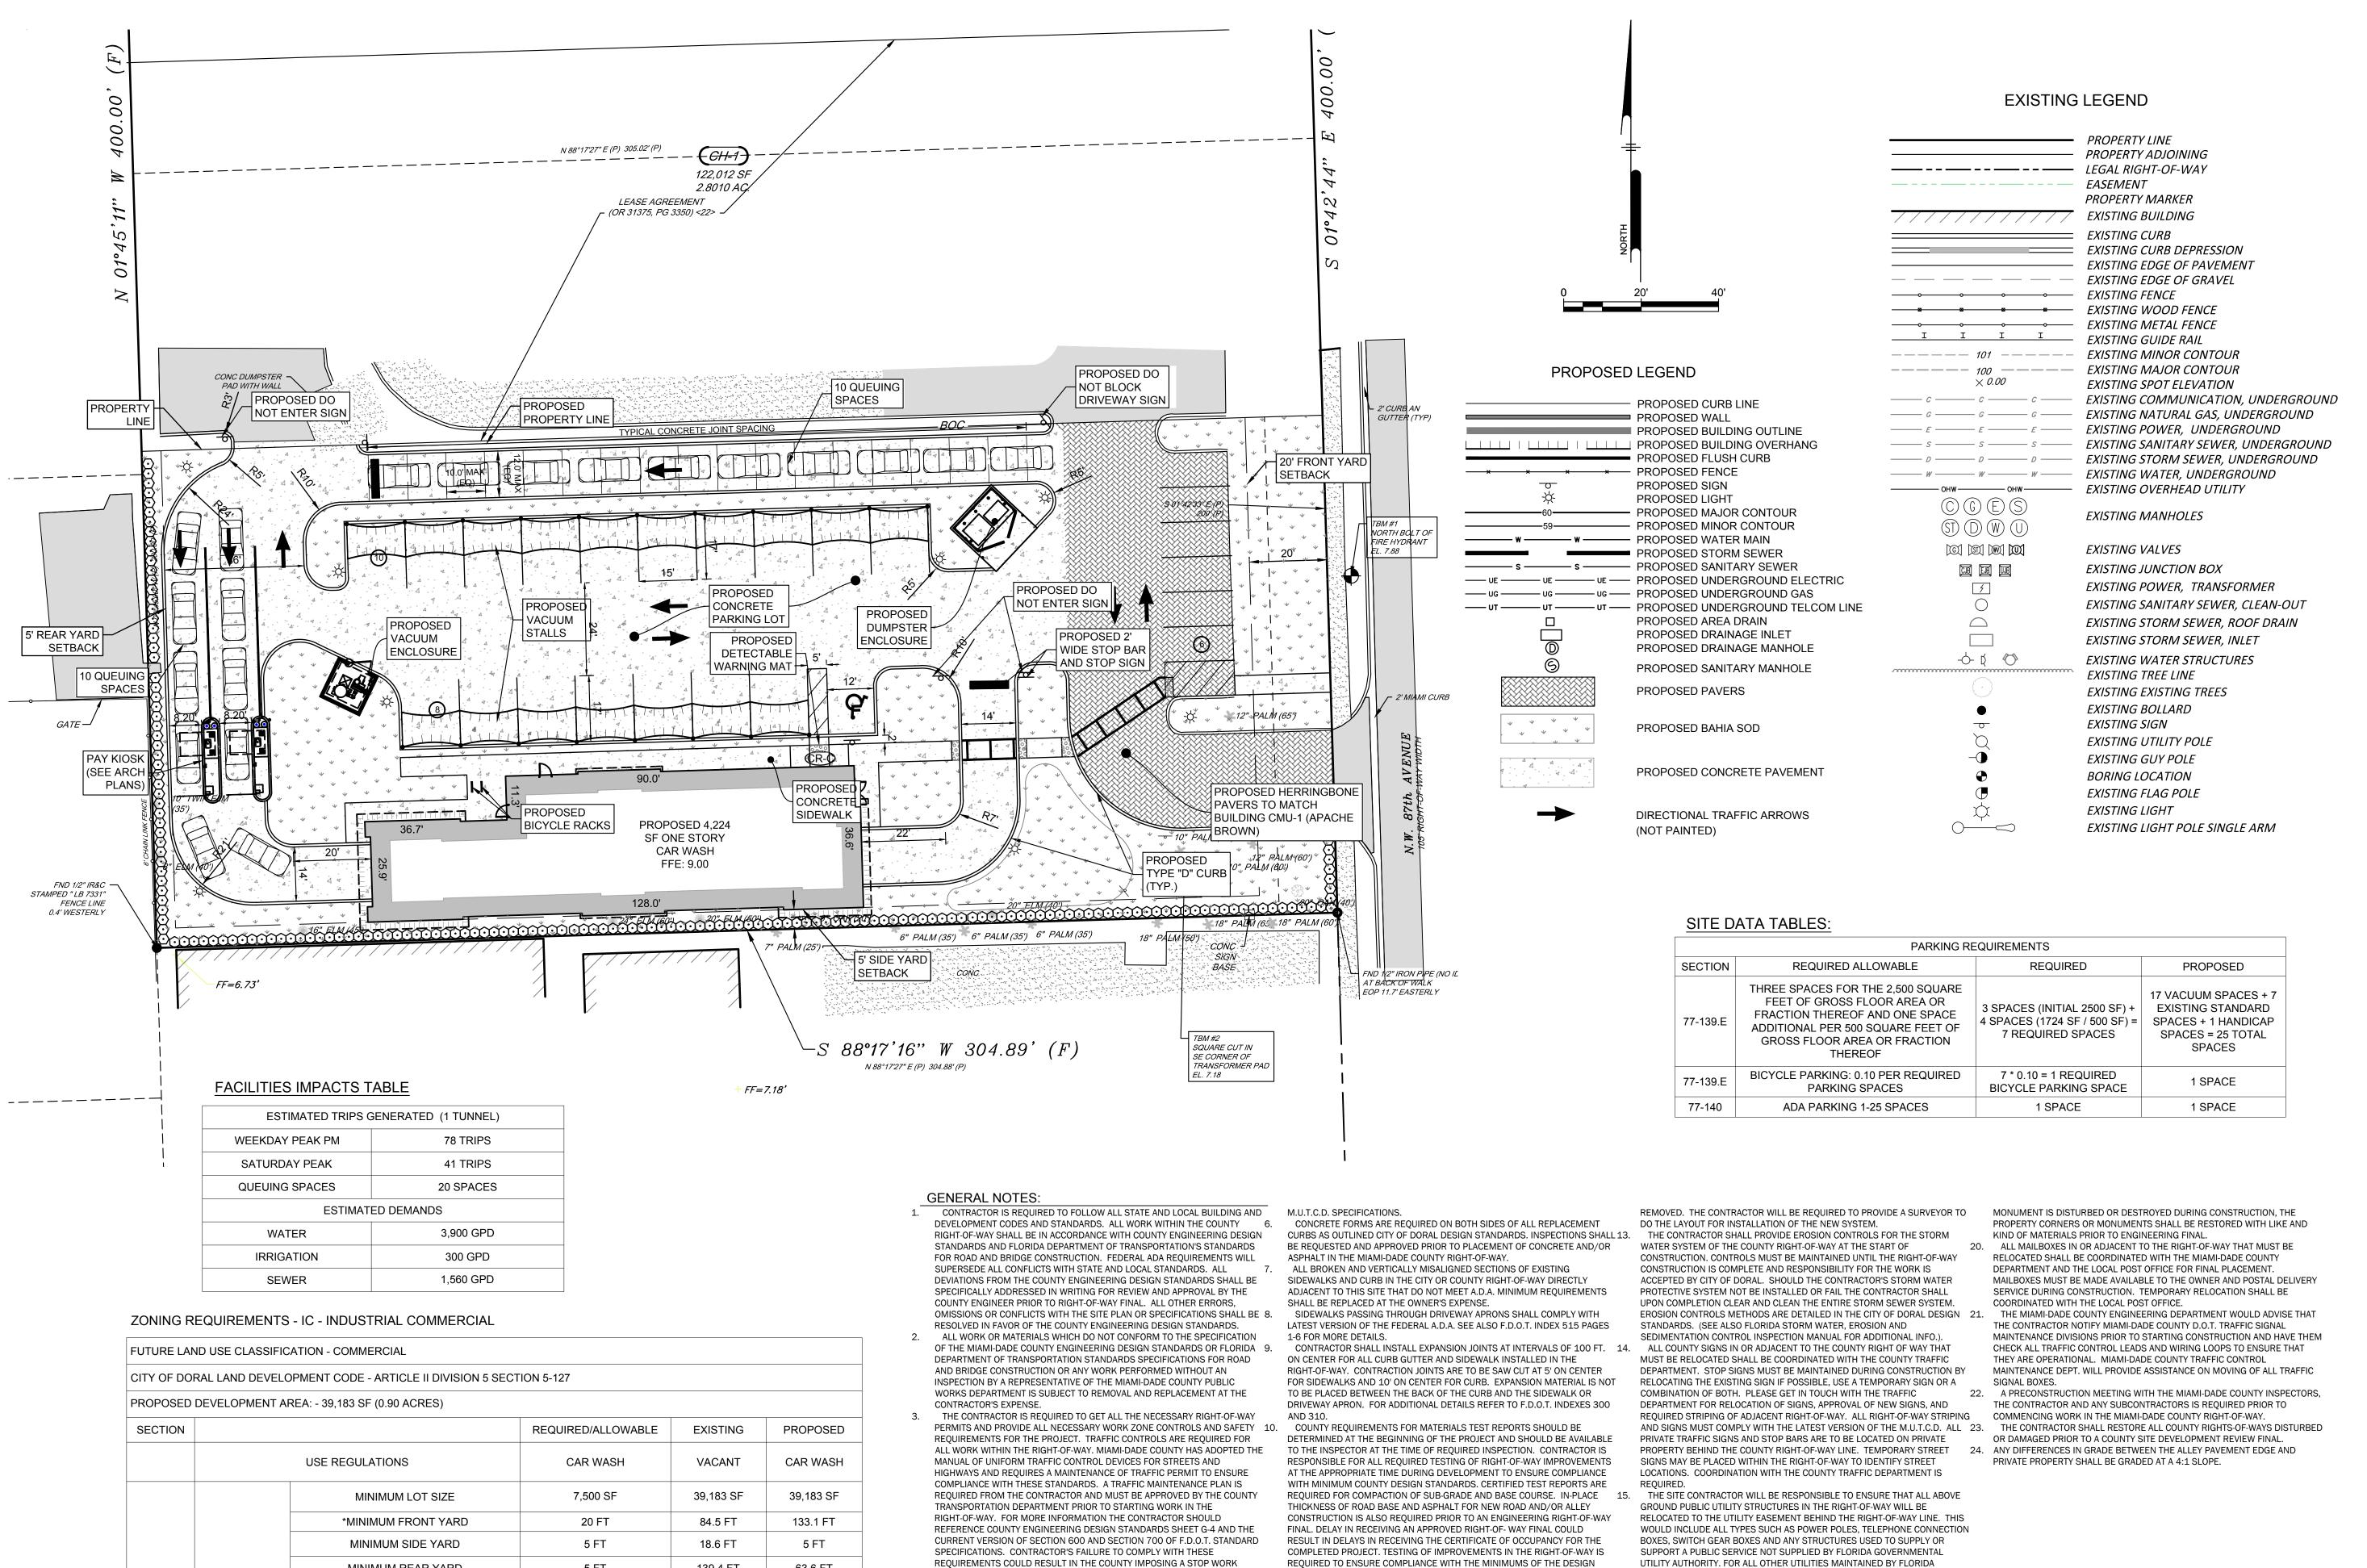

CROSS SECTIONS.

PART OF THE PROJECT.

LENGTH OF THE ASPHALT WIDENING TO BE CONSTRUCTED AND ANY OF THE 12. THE CONTRACTOR WILL BE REQUIRED TO CONTACT THE SITE DEVELOPMENT

WAY DISTURBED OR DAMAGED DURING CONSTRUCTION UP AND TO THE POINT

AND OTHER DIFFERENCES IN GRADE INCLUDING PRIVATE PROPERTY SHOULD

BE GRADED AT A 4:1 SLOPE. THESE AREAS SHALL BE COVERED WITH HYDRO

EXISTING PAVEMENT AND 10-FEET IN ALL DIRECTIONS AROUND STORM WATER

INLETS. THIS INCLUDES PROPERTIES LOCATED ACROSS ALLEYS IMPROVED AS

FOR REROUTING OF THE COUNTY STORM WATER SYSTEM. AFTER ALL OF THE

NEW PIPES AND STRUCTURE HAVE BEEN INSTALLED AND APPROVED BY THE

COUNTY, THE OLD PIPES AND ANY STRUCTURES ON THE PROPERTY MUST BE

GOVERNMENTAL UTILITY AUTHORITY

3000 P.S.I. MINIMUM.

FINISHED GRADE UPON COMPLETION OF PAVING OR RELATED CONSTRUCTION

CONNECT TO UNDERGROUND RETENTION SYSTEMS THAT PARALLEL THE

REPRESENTATIVE ARE SUBJECT TO REMOVAL, OR REPLACEMENT AT THE

STANDARDS, OR THAT ARE NOT PROPERLY INSPECTED BY A COUNTY

RIGHT-OF-WAY AND SHALL BE ATTACHED TO INLETS AS PER DETAILS SHOWN.

CONTRACTOR'S EXPENSE. ALL CONCRETE WITHIN COUNTY R.O.W. MUST BE

ARE TO BE IN PLACE AND MARKED PRIOR TO REQUESTING SERVICES FOR

SURVEYING LAY OUT AND/OR INSPECTIONS. ALL PROPERTY CORNERS AND

SURVEY MONUMENTS SHALL BE PRESERVED. IF A PROPERTY CORNER OR

CONTRACTOR IS RESPONSIBLE FOR RESTORATION OF ALL COUNTY RIGHT-OF- 16. ALL FRAMES, COVERS, VALVE BOXES AND MANHOLES SHALL BE ADJUSTED TO

AND REVIEW DIVISION TO COORDINATE THE INSTALLATION AND INSPECTIONS 19. ALL PROPERTY SURVEY MONUMENTS IN MIAMI-DADE COUNTY RIGHT-OF-WAY

THAT FINAL APPROVAL IS RECEIVED FROM THE COUNTY. RIGHT-OF-WAY, SWALE 17. ROUND STORM DRAINS ADJACENT TO INLETS ARE SUMP WELLS THAT

SEED OR SOD. SOD ONLY IS TO BE PLACED ALONG THE EDGE OF NEW OR 18. ALL WORK/MATERIALS THAT DO NOT CONFORM TO LOCAL OR STATE

5 FT

128 FT (R-O-W WIDTH)

31,346 SF

80%

N/A

N/A

7,837 SF

20%

MINIMUM REAR YARD

MAXIMUM BUILDING HEIGHT

MAXIMUM IMPERVIOUS COVERAGE (SF)

MAXIMUM IMPERVIOUS COVERAGE (%)

GROSS FLOOR AREA (SF)

VEHICULAR USE AREA (SF)

MINIMUM OPEN SPACE AREA (SF)

MINIMUM OPEN SPACE AREA (%)

**DIMENSIONAL** 

STANDARDS

5.13

63.6 FT

28.5 FT

27,709 SF

70.7%

4,224 SF

21,273 SF

11,474 SF

29.3%

ORDER ON THE PROJECT.

CHANGES IF ANY.

4. CONTRACTOR TO NOTE THAT DESIGN ELEVATIONS FOR THE RIGHT-OF-WAY 11.

PLAN. THE COUNTY'S SURVEY DEPARTMENT WILL SET THE GRADES FOR CURB

SHOWN, ON THE PLANS MAY DIFFER FROM THE COUNTY'S MASTER DESIGN

DEPARTMENT TO OBTAIN RIGHT-OF-WAY DESIGN INFORMATION AND LATEST

5. THE CONTRACTOR SHALL ENSURE THAT WITH ALL ROAD IMPROVEMENTS, THE

EXISTING ASPHALT ROAD EDGE IS CUT BACK A MIN. OF 1 FT FOR THE ENTIRE

EXISTING THERMOPLASTIC STRIPING REMAINING ALONG THE CUT EDGE WILL

BE GROUND OFF. THE SUB-BASE AND CUT EDGE ARE TO BE TACK COATED

STRIPING SHALL BE THERMOPLASTIC AND PLACED ALONG THE CURB PER

PRIOR TO THE INSTALLATION OF THE NEW ASPHALT, AND THAT ALL NEW

AS PER THE COUNTY'S CURB AND ROAD WIDENING MASTER PLAN. THE

CONTRACTOR SHOULD CHECK WITH THE COUNTY'S ENGINEERING

139.4 FT

+/- 25 FT

27,037 SF

69.0%

2,957SF

20,874 SF

12,146 SF


31.0%

CLIENT

LTA	DESC	DESCRIPTION	DATE
	×	X-XX	XX-XX-XX

ENGINEER:

PENNONI ASSOCIATES INC. 5755 Rio Vista Drive Florida COA: 7819

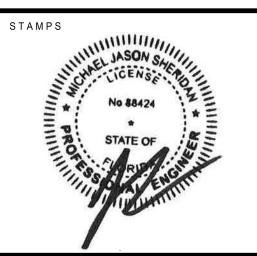


SITE PLAN

PROJECT NUMBER **DRVBR22027** 


08-01-2022 DATE AS NOTED. SCALE DRAWN CHECKED SHEET NO

**CS1000** 

*20 TOTAL QUEUING SPACES ARE PROVIDED

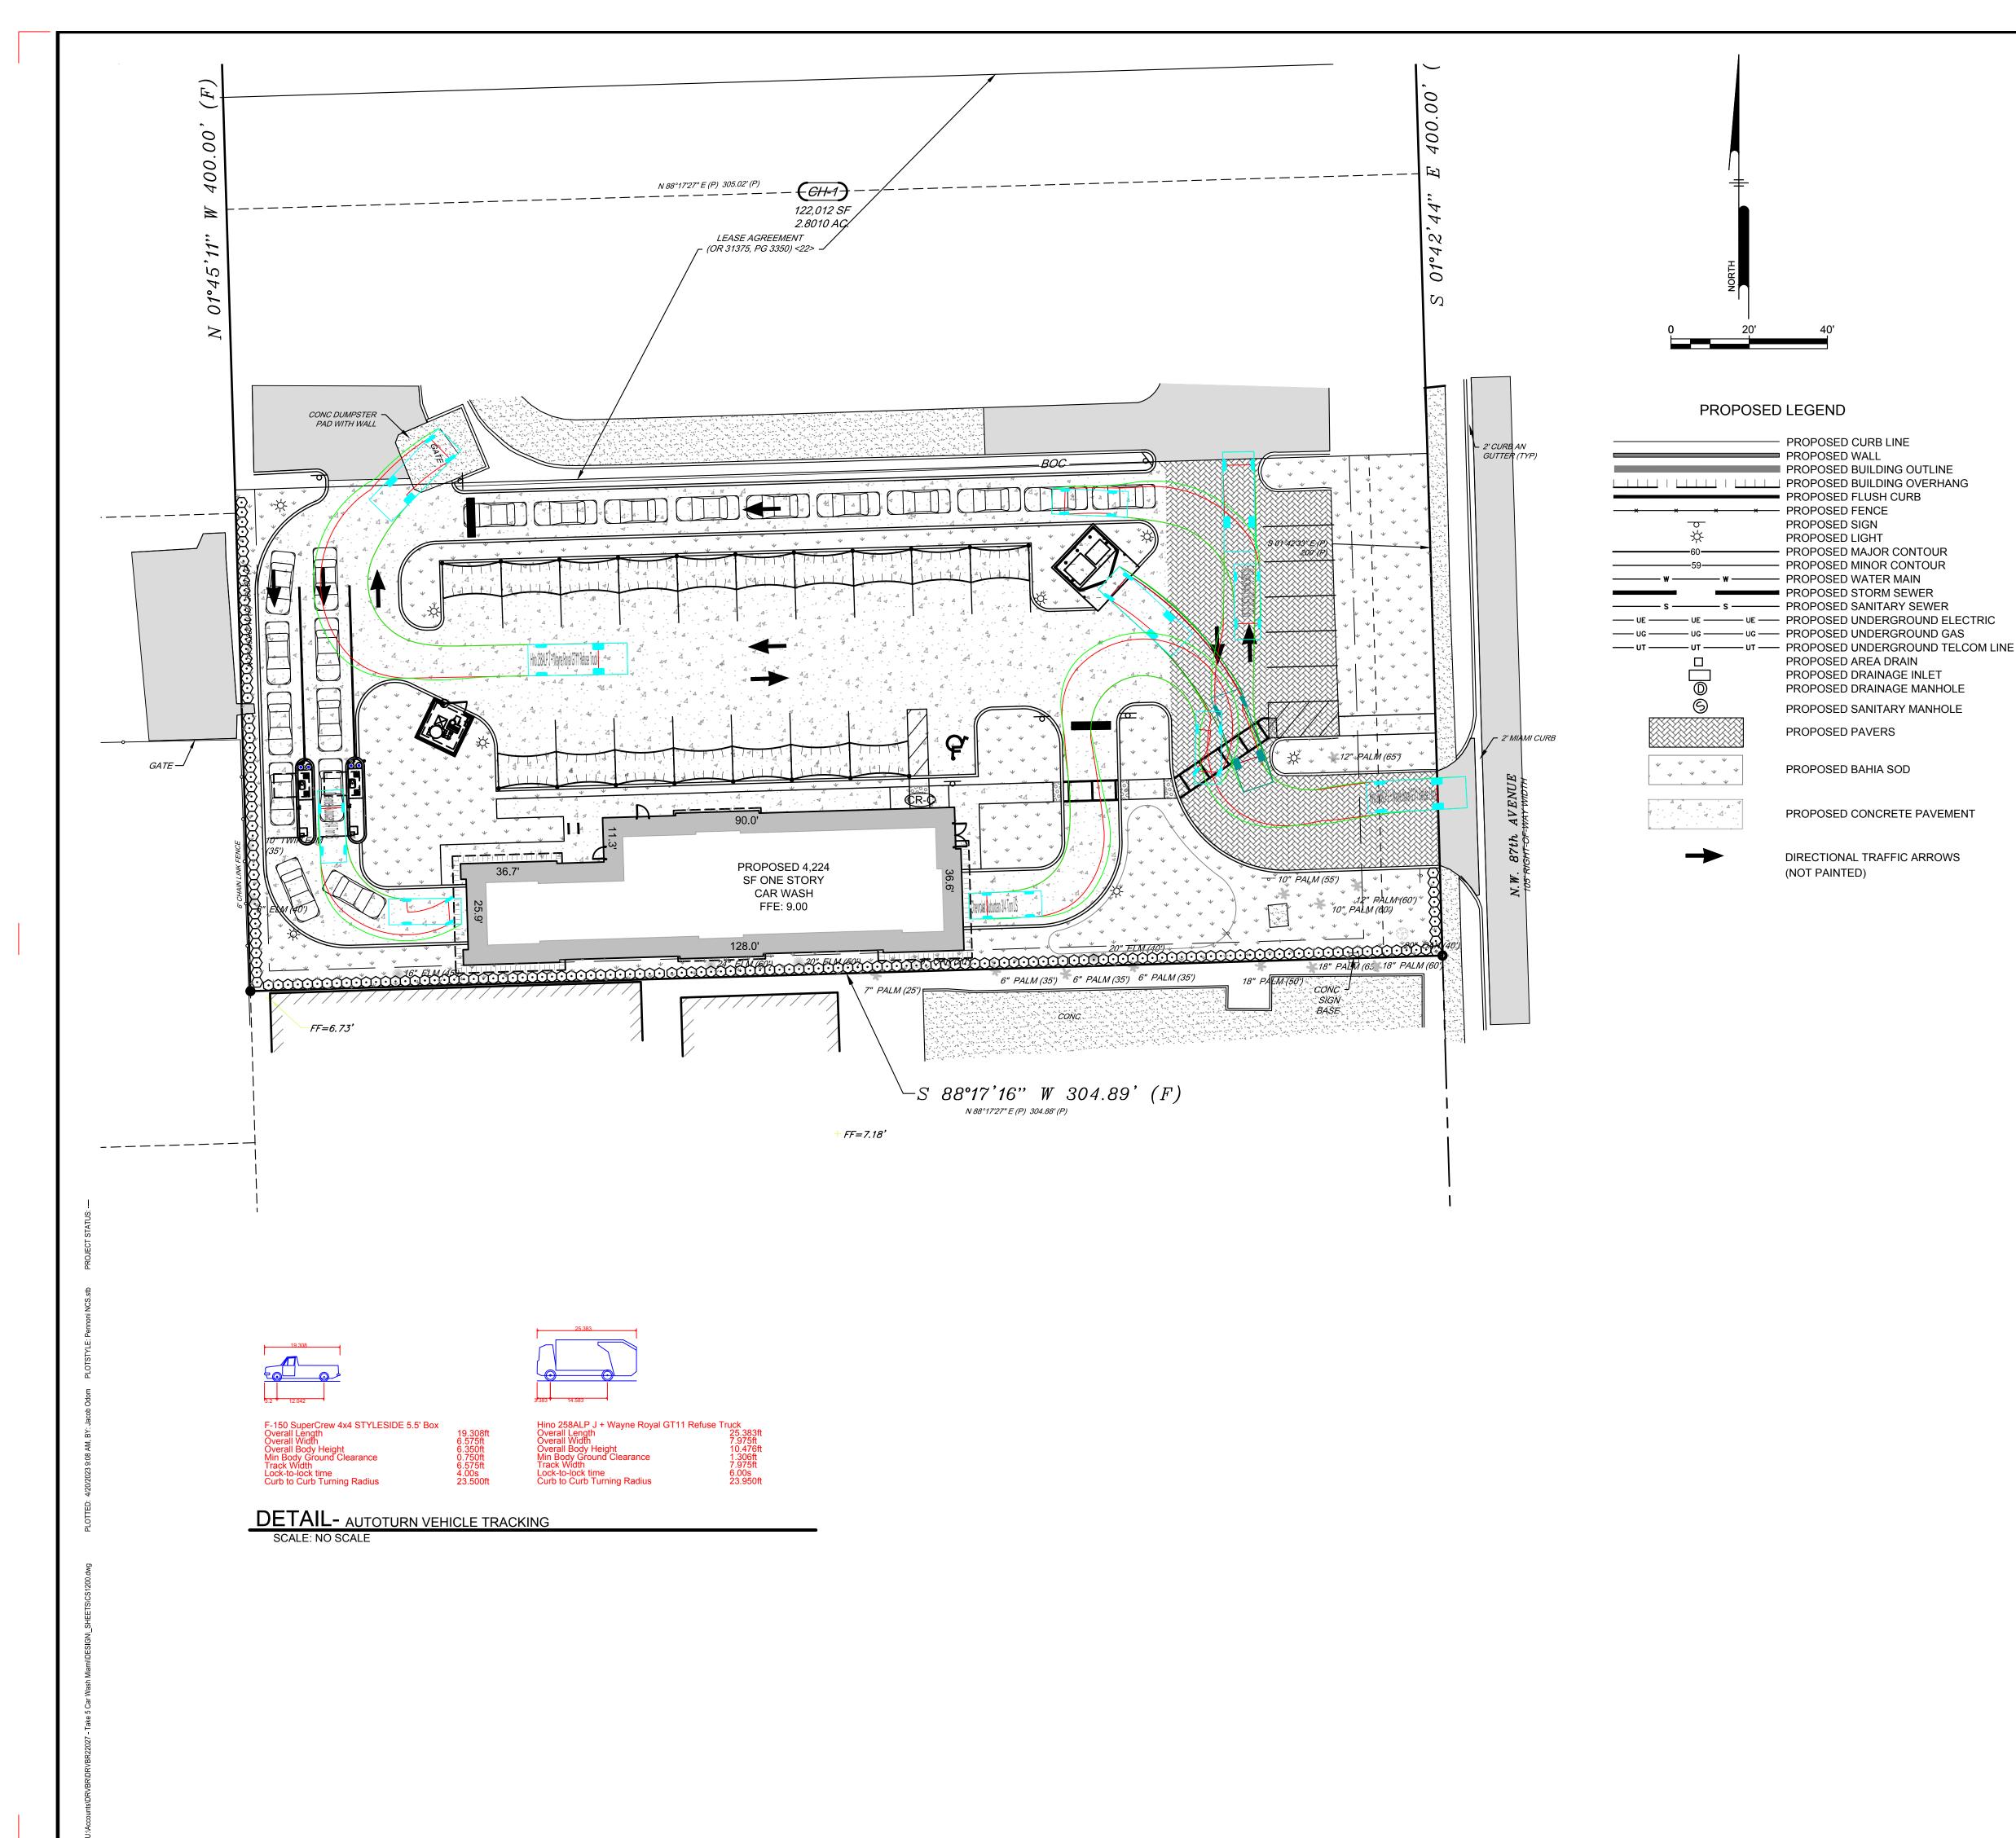



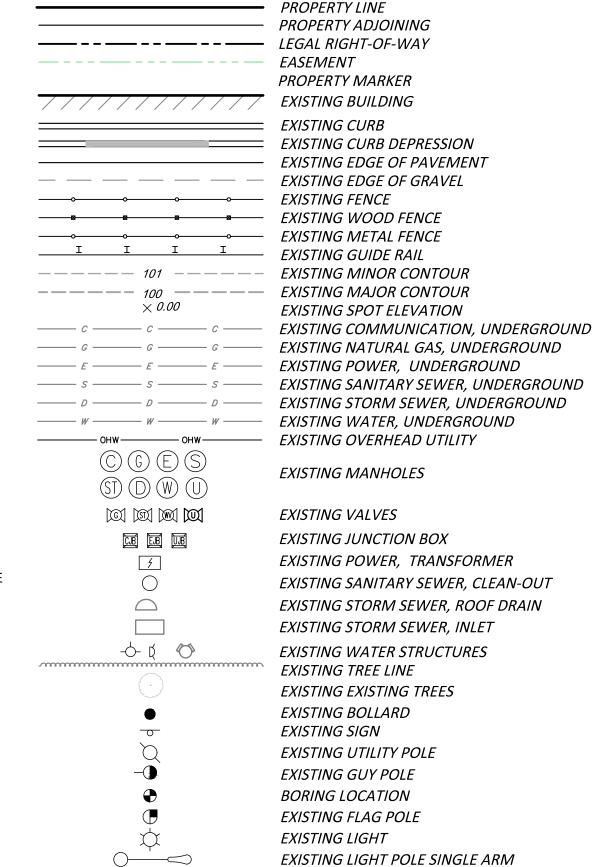



DATE	XX-XX-XX	XX-XX-XX	XX-XX-XX	XX-XX-XX	XX-XX-XX	XX-XX-XX	
DESCRIPTION							
A	×	×	×	×	×	×	

ENGINEER:



STAMPS




**CIRCULATION PLAN** 

PROJECT NUMBER


		)F	3	$\backslash$	<u> </u>	3	F	?	2	2	2(	)	2	27	7		
DATE														)8- ·	0′	1-2	2022
SCALE														٩S ·	N	Ō.	TEE
DRAWI	N .											•					JC

SHEET NO

CHECKED

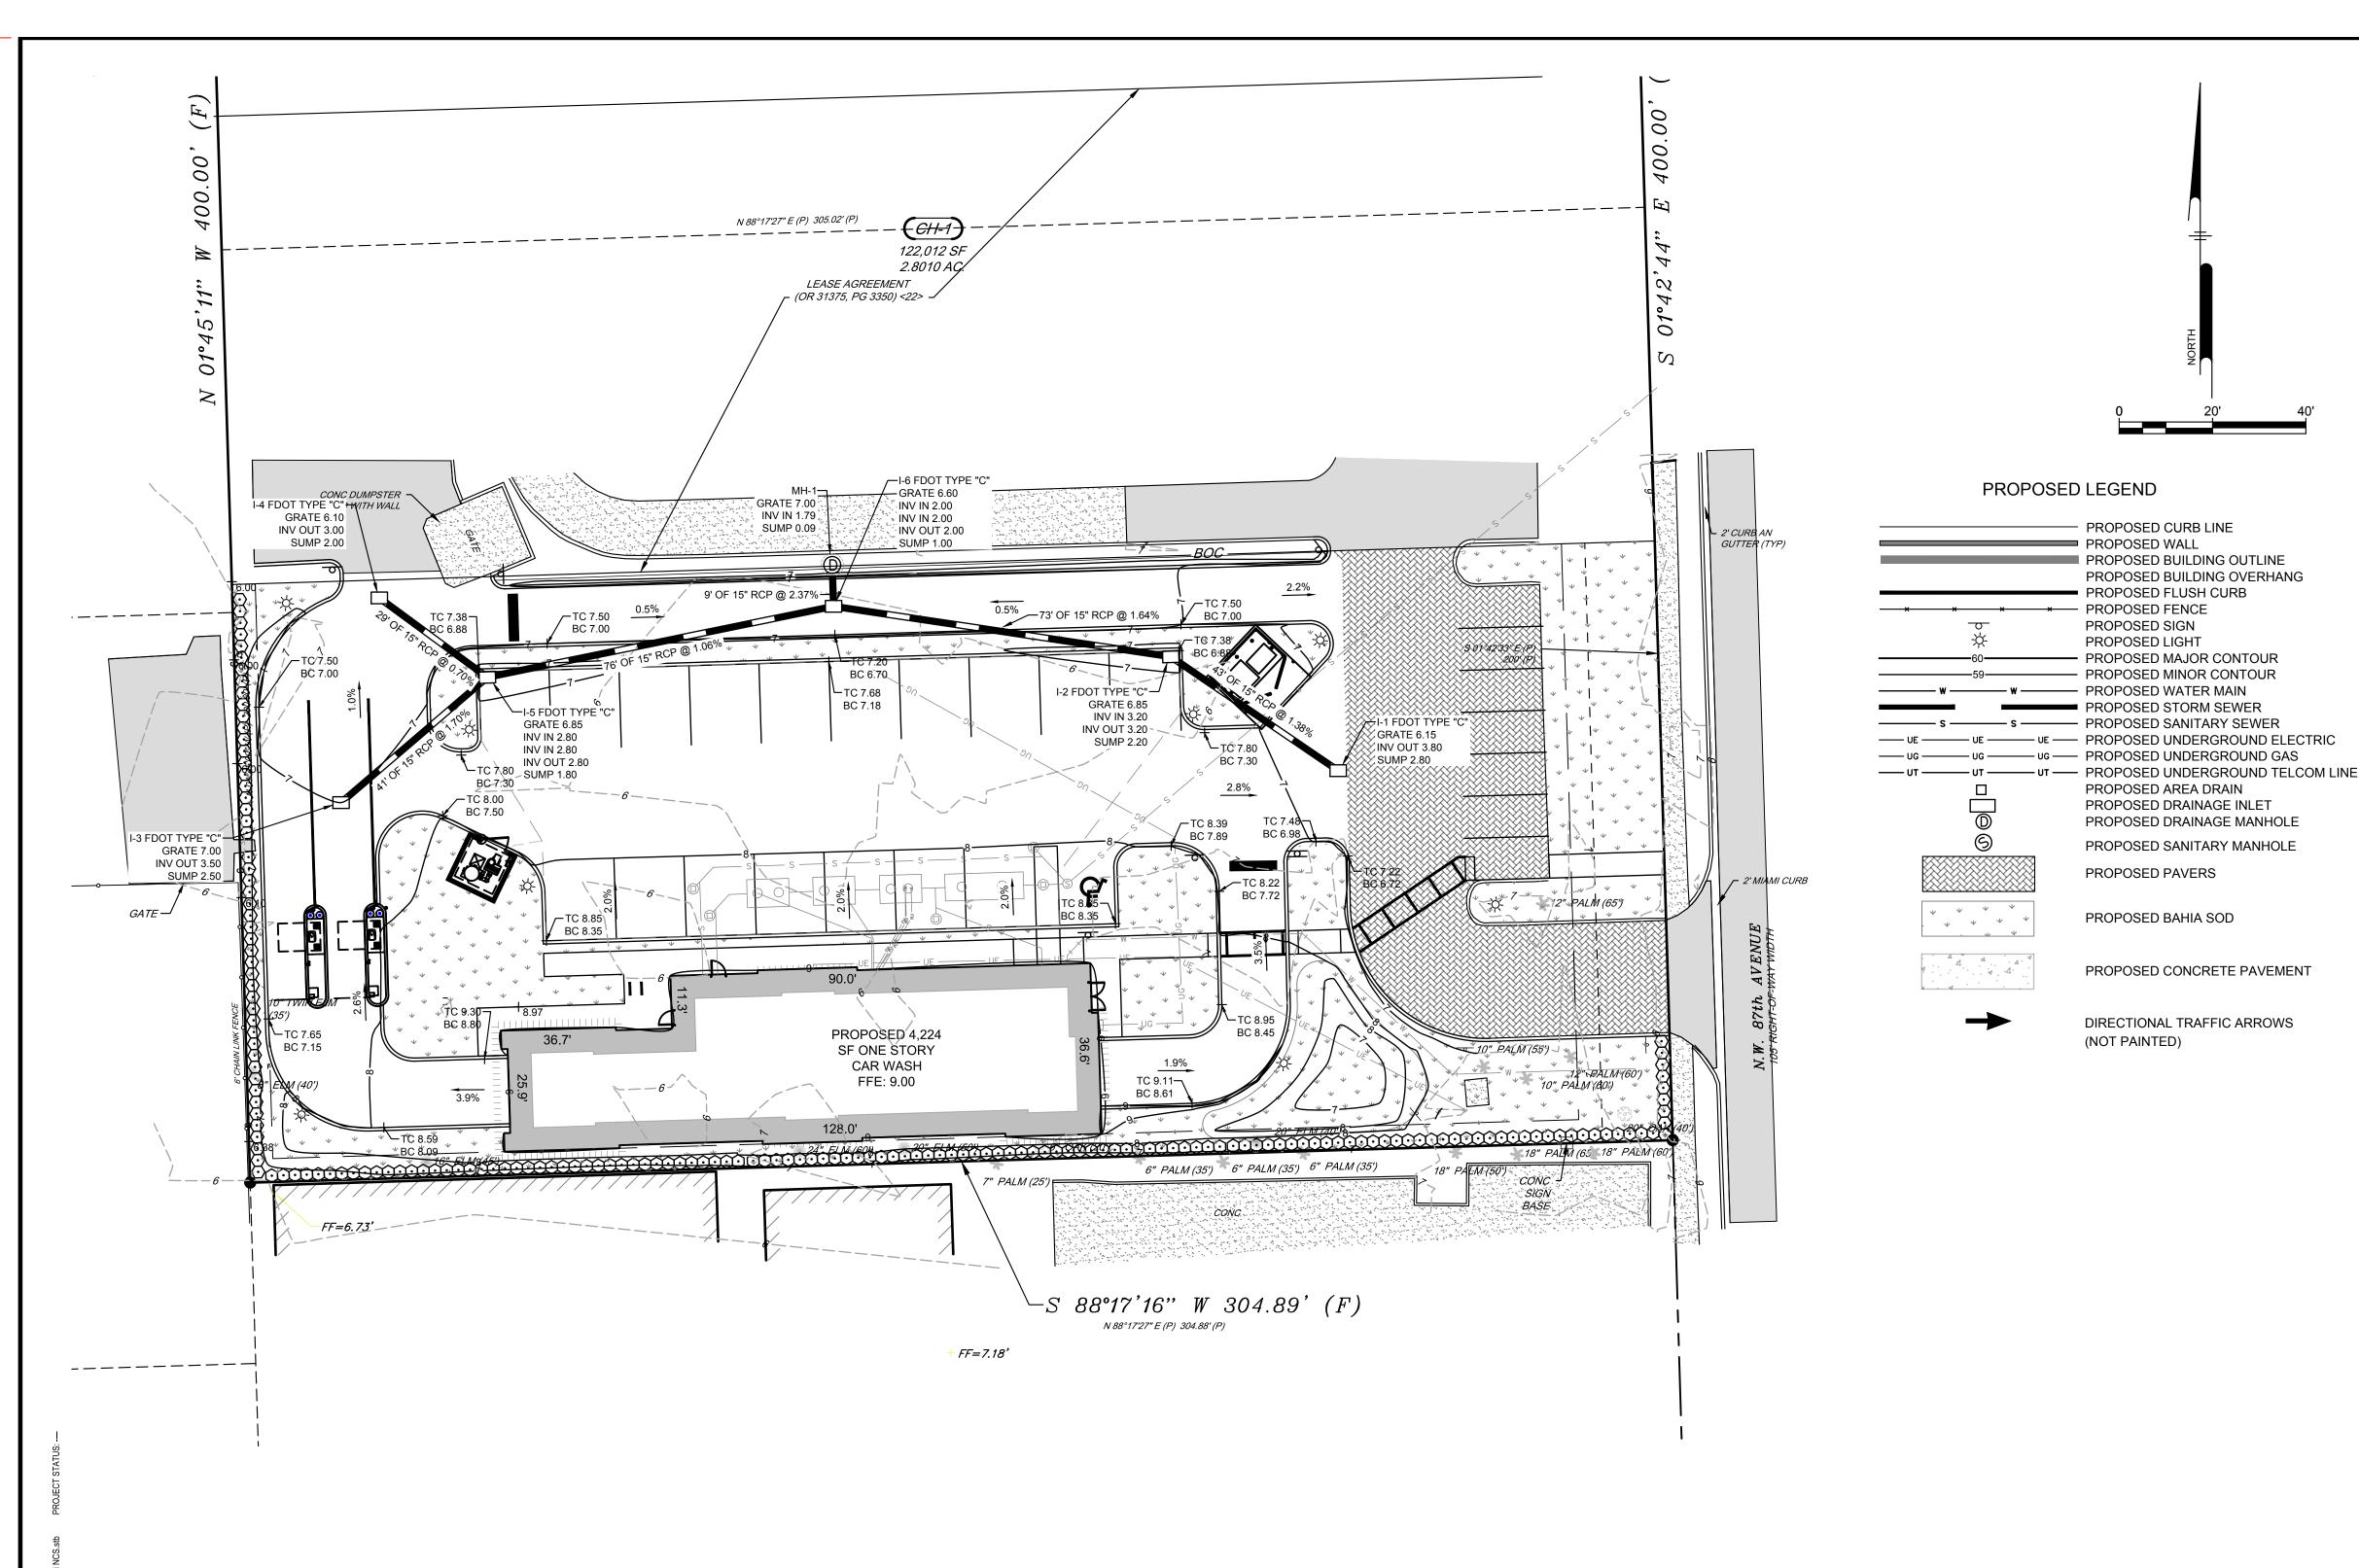



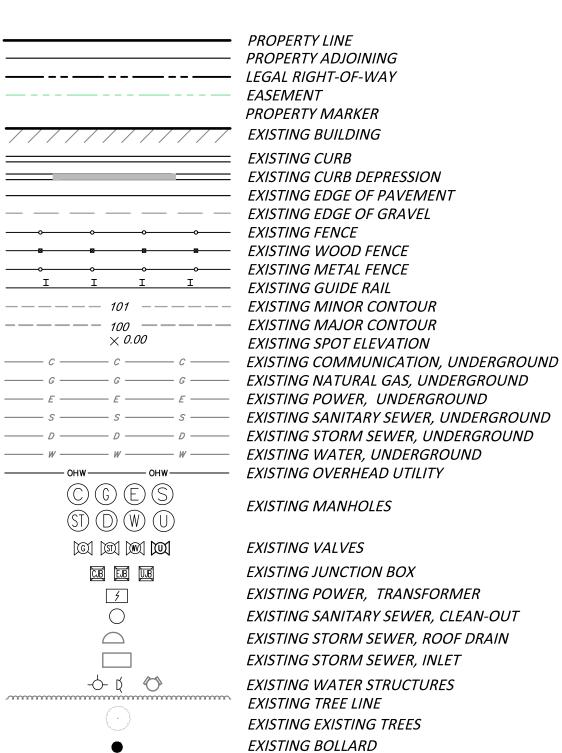

EXISTING SIGN

EXISTING UTILITY POLE **EXISTING GUY POLE** 

EXISTING LIGHT POLE SINGLE ARM

**BORING LOCATION** EXISTING FLAG POLE

EXISTING LIGHT

PROPOSED LEGEND

+ + + +

PROPOSED CURB LINE

PROPOSED BUILDING OUTLINE

PROPOSED FLUSH CURB

PROPOSED MAJOR CONTOUR

— PROPOSED MINOR CONTOUR

PROPOSED BUILDING OVERHANG

PROPOSED WALL

PROPOSED SIGN

PROPOSED LIGHT

- s ----- PROPOSED SANITARY SEWER

— ug —— ug — PROPOSED UNDERGROUND GAS

- UE ----- UE ---- PROPOSED UNDERGROUND ELECTRIC

PROPOSED PAVERS

(NOT PAINTED)

PROPOSED BAHIA SOD

PROPOSED AREA DRAIN

PROPOSED DRAINAGE INLET

PROPOSED DRAINAGE MANHOLE

PROPOSED SANITARY MANHOLE

PROPOSED CONCRETE PAVEMENT

DIRECTIONAL TRAFFIC ARROWS




CLIENT

\$\\$\\$\\$\\$\\$

ENGINEER:

STAMPS

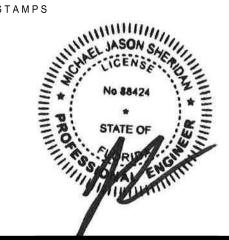

**GRADING AND DRAINAGE PLAN** 

PROJECT NUMBER

**DRVBR22027** 08-01-2022 AS NOTED SCALE DRAWN

SHEET NO

CHECKED

**CS1501** 

GRADING NOTES:

3. BEDDING REQUIREMENTS SPECIFIED HEREIN ARE TO BE CONSIDERED AS MINIMUMS FOR RELATIVELY DRY, STABLE EARTH CONDITIONS.

4. COMPACTION OF THE BACKFILL OF ALL TRENCHES SHALL BE COMPACTED TO THE DENSITY OF 95% OF THEORETICAL MAXIMUM DRY DENSITY (ASTM D698). BACKFILL MATERIAL SHALL BE FREE FROM ROOTS, STUMPS, OR OTHER FOREIGN DEBRIS AND SHALL BE PLACED IN LIFTS NOT TO EXCEED 6 INCHES IN COMPACTED FILL THICKNESS. CORRECTION OF ANY TRENCH SETTLEMENT WITHIN A YEAR FROM THE DATE OF APPROVAL WILL BE THE RESPONSIBILITY OF THE CONTRACTOR.

5. THE CONTRACTOR WILL ENSURE THAT POSITIVE AND ADEQUATE DRAINAGE IS MAINTAINED AT ALL TIMES WITHIN THE PROJECT LIMITS. THIS MAY INCLUDE, BUT NOT BE LIMITED TO, REPLACEMENT OR RECONSTRUCTION OF EXISTING DRAINAGE STRUCTURES THAT HAVE BEEN DAMAGED OR REMOVED OR REGRADING AS REQUIRED BY THE ENGINEER, EXCEPT FOR THOSE DRAINAGE ITEMS SHOWN AT SPECIFIC LOCATIONS AND HAVING SPECIFIC PAY ITEMS IN THE DETAILED ESTIMATE. NO SEPARATE PAYMENT WILL BE MADE FOR ANY COSTS INCURRED

6. THE CONTRACTOR SHALL PROVIDE ANY AND ALL EXCAVATION AND MATERIAL SAMPLES NECESSARY TO CONDUCT REQUIRED SOIL TESTS. ALL ARRANGEMENTS AND SCHEDULING FOR THE TESTING SHALL BE THE CONTRACTOR'S RESPONSIBILITY.

7. SOILS TESTING AND ON-SITE INSPECTION SHALL BE PERFORMED BY AN INDEPENDENT GEOTECHNICAL ENGINEER. THE SOILS ENGINEER SHALL PROVIDE COPIES OF TEST REPORTS TO THE CONTRACTOR, THE OWNER AND THE OWNER'S REPRESENTATIVE AND SHALL PROMPTLY NOTIFY THE OWNER, HIS REPRESENTATIVE AND THE CONTRACTOR, SHOULD WORK PERFORMED BY THE CONTRACTOR FAIL TO MEET THESE

SPECIFICATIONS. 8. CONTRACTOR SHALL FURNISH AND MAINTAIN ALL NECESSARY BARRICADES AROUND THE WORK AREA AND SHALL PROVIDE PROTECTION


9. ELEVATIONS ARE BASED ON NORTH AMERICAN VERTICAL DATUM OF 1988 (NAVD 88).

1. A GEOTECHNICAL ENGINEER IS REQUIRED TO INSPECT, TEST AND CERTIFY TO THE COMPACTION OF ALL LOAD BEARING FILLS. ALL EXISTING UNDERGROUND UTILITIES SHALL BE REMOVED OR RELOCATED. THE PREPARED SUBGRADE SHALL BE PROOF ROLLED WITH A SMOOTH-DRUM VIBRATING ROLLER TO DELINEATE SOFT/UNSTABLE AREAS AND COMPACT SOILS DISTURBED DURING EXCAVATION OPERATIONS. AREAS WHICH EXHIBIT INSTABILITY SHALL BE UNDERCUT AND REPLACED WITH LOAD-BEARING FILL.

#### 2. MINIMUM PAVEMENT GRADE SHALL BE 1.0% SLOPE UNLESS NOTED OTHERWISE. ADDITIONAL BEDDING SHALL BE REQUIRED FOR ROCK TRENCHES AND WET AREAS. CONTRACTOR SHALL HAVE THE RESPONSIBILITY TO PROVIDE SUCH ADDITIONAL BEDDING AS MAY BE REQUIRED TO PROPERLY CONSTRUCT THE WORK.

# TO COMPLY WITH THIS REQUIREMENT.

AGAINST WATER DAMAGE AND SOIL EROSION.

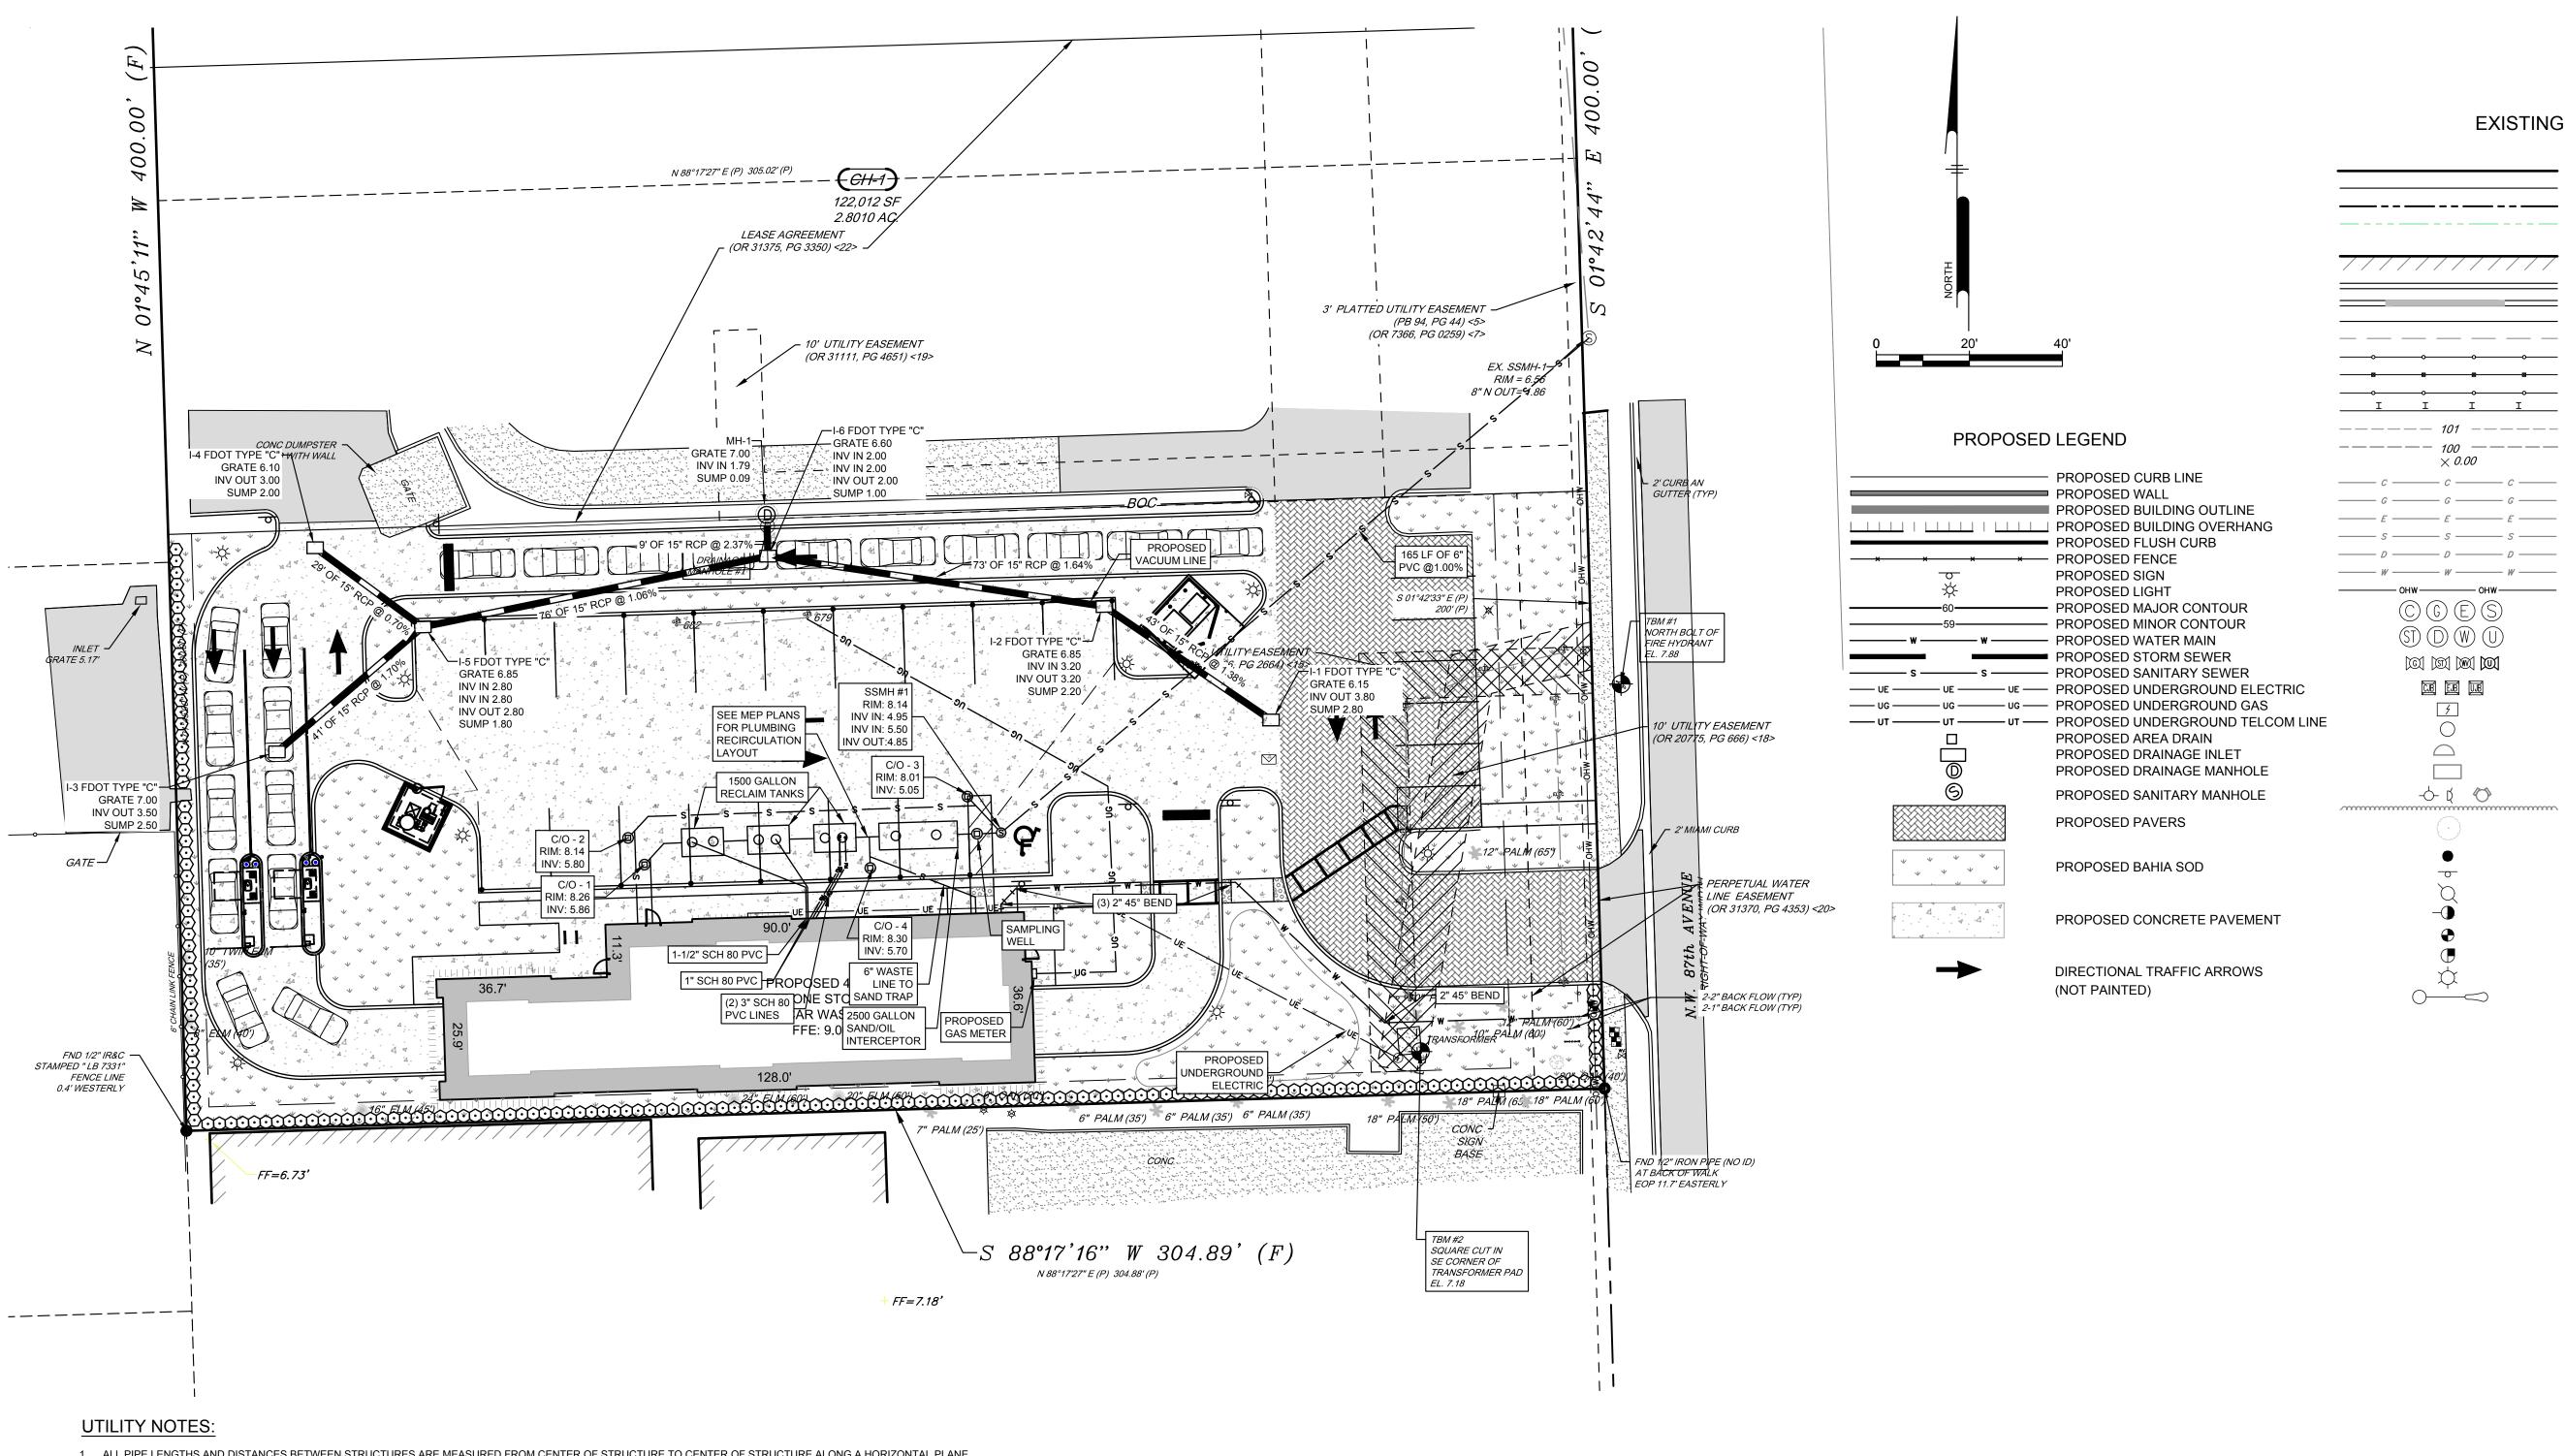

- 1. ALL PIPE LENGTHS AND DISTANCES BETWEEN STRUCTURES ARE MEASURED FROM CENTER OF STRUCTURE TO CENTER OF STRUCTURE ALONG A HORIZONTAL PLANE.
- ALL STORM DRAINAGE PIPE SHALL BE LAID ON SMOOTH CONTINUOUS GRADES WITH NO VISIBLE BENDS AT JOINTS. 3. BEDDING REQUIREMENTS SPECIFIED HEREIN ARE TO BE CONSIDERED AS MINIMUMS FOR RELATIVELY DRY, STABLE EARTH CONDITIONS. ADDITIONAL BEDDING SHALL BE REQUIRED FOR ROCK TRENCHES AND WET AREAS. CONTRACTOR SHALL HAVE THE RESPONSIBILITY TO PROVIDE SUCH ADDITIONAL BEDDING AS MAY BE REQUIRED TO PROPERLY CONSTRUCT THE WORK.
- 4. COMPACTION OF THE BACKFILL OF ALL TRENCHES SHALL BE COMPACTED TO THE DENSITY OF 95% OF THEORETICAL MAXIMUM DRY DENSITY (ASTM D698). BACKFILL MATERIAL SHALL BE FREE FROM ROOTS, STUMPS, OR OTHER FOREIGN DEBRIS AND SHALL BE PLACED IN LIFTS NOT TO EXCEED 6
- INCHES IN COMPACTED FILL THICKNESS. A REPORT FROM A GEOTECHNICAL ENGINEER MAY BE REQUIRED BY THE PUBLIC WORKS INSPECTOR. CORRECTION OF ANY TRENCH SETTLEMENT WITHIN A YEAR FROM THE DATE OF APPROVAL WILL BE THE RESPONSIBILITY OF THE CONTRACTOR. 5. THE CONTRACTOR WILL ENSURE THAT POSITIVE AND ADEQUATE DRAINAGE IS MAINTAINED AT ALL TIMES WITHIN THE PROJECT LIMITS. THIS MAY INCLUDE, BUT NOT BE LIMITED TO, REPLACEMENT OR RECONSTRUCTION OF EXISTING DRAINAGE STRUCTURES THAT HAVE BEEN DAMAGED OR REMOVED OR REGRADING AS REQUIRED BY THE ENGINEER, EXCEPT FOR THOSE DRAINAGE ITEMS SHOWN AT SPECIFIC LOCATIONS AND HAVING SPECIFIC PAY ITEMS IN THE DETAILED ESTIMATE. NO SEPARATE PAYMENT WILL BE MADE FOR ANY COSTS INCURRED TO COMPLY WITH THIS
- 6. CONTRACTOR IS RESPONSIBLE FOR ALL UTILITY CONNECTION FEES.
- 7. IT IS THE RESPONSIBILITY OF THE CONTRACTOR TO DETERMINE THE LOCATION OF ALL EXISTING UNDERGROUND UTILITIES AND TO TAKE WHATEVER STEPS NECESSARY TO PROVIDE FOR THEIR PROTECTION. THE ENGINEER ASSUMES NO RESPONSIBILITY FOR THE LOCATIONS OF UTILITIES SHOWN OR NOT SHOWN. THE CONTRACTOR SHALL CONTACT THE UTILITY COMPANIES FOR EXACT LOCATION OF THEIR UTILITIES PRIOR TO STARTING CONSTRUCTION. IT SHALL BE THE SOLE RESPONSIBILITY OF THE CONTRACTOR TO REPAIR AND REPLACE ANY AND ALL DAMAGE MADE TO UTILITIES BY THE CONTRACTOR
- 8. THE CONTRACTOR SHALL COORDINATE LOCATION AND INSTALLATION OF ALL UNDERGROUND UTILITIES AND APPURTENANCES TO MINIMIZE DISTURBANCE TO CURBING, PAVING, AND COMPACTED SUBGRADE.
- 9. CONTRACTOR SHALL EXCAVATE ONLY AS MUCH TRENCH WHICH PIPE CAN BE INSTALLED AND TRENCH BACKFILLED BY THE END OF EACH WORK DAY. 10. ALL UNDERGROUND UTILITY TRENCHES SHALL BE BACKFILLED WITH SAFE CLEAN FILL.

11. FLOW PRESSURE TO ALL FIRE HYDRANTS SHALL HAVE MINIMUM 600 GALLONS PER MINUTE AT A MINIMUM RESIDUAL PRESSURE OF 20 POUNDS PER SQUARE INCH.

12. THE CONTRACTOR OR OWNER'S REPRESENTATIVE WILL BE RESPONSIBLE FOR OBTAINING AN APPROPRIATELY SIZED TEMPORARY JUMPER ASSEMBLY WITH METER FROM THE CITY OF DORAL UTILITY COLLECTION AND DISTRIBUTION DEPARTMENT, PRIOR TO RECEIVING CITY WATER FOR CONSTRUCTION AND/OR TYING INTO ANY EXISTING POTABLE WATER MAIN LINES. A BILLING ACCOUNT MUST BE SET UP THROUGH THE CITY'S CUSTOMER BILLING DEPARTMENT PRIOR TO INSTALLATION. A REPRESENTATIVE FROM THE CITY OF DORAL'S DEVELOPMENT SERVICES, MUST BE NOTIFIED 48 HOURS IN ADVANCE OF INSTALLATION AND BE PRESENT TO WITNESS AND RECORD THE INSTALLATION PROCESS. ACCOUNT DOCUMENTATION MUST BE SUBMITTED TO THE SITE DEVELOPMENT AND REVIEW INSPECTOR AT THE TIME OF METER INSTALLATION. AFTER CONSTRUCTION IS

COMPLETE AND BEFORE THE TEMPORARY JUMPER AND METER IS REMOVED ALL POTABLE WATER MAINS SHALL BE FLUSHED AND PRESSURE TESTED PER AWWA SECTION C_600 AND DISINFECTED PER AWWA C_651.

- 13. THE CONTRACTOR IS RESPONSIBLE FOR NOTIFYING THE CITY OF DORAL'S UTILITIES COLLECTION/DISTRIBUTION DIVISION, A MINIMUM OF 7 DAYS PRIOR TO ANY SHUT DOWN OR DIVERSION OF AN EXISTING WATER MAIN. A 48_HOUR NOTICE IS REQUIRED FOR A PRESSURE TEST, HOT TAP, OR TIE INTO EXISTING UTILITY MAIN, AND PRIOR TO BEGINNING ANY UTILITY CONSTRUCTION. ALSO, THE CONTRACTOR WILL DISTRIBUTE ANY INTERRUPTION OF SERVICES NOTICES TO ALL AFFECTED PARTIES AND THE CITY WILL DISTRIBUTE ALL BOIL WATER AND RESCISSION NOTICES.
- 14. IF ANY UTILITY WORK (WATER, SEWER AND IRRIGATION) IS PERFORMED AFTER HOURS (SCHEDULED OR UNSCHEDULED) AND THE UTILITY WORK REQUIRES THE PRESENCE OF A CITY OF DORAL UTILITY INSPECTOR THE SUBJECT OVERTIME WILL BE REQUIRED TO BE PAID FOR BY THE CONTRACTOR.
- A BILL WILL BE CREATED AND ATTACHED TO THE APPROPRIATE PERMIT AND PAYMENT WILL BE REQUIRED BEFORE THE WATER FINAL INSPECTION IS COMPLETED. 15. ALL UTILITY MAIN EXTENSIONS AND UTILITY MAIN REPLACEMENTS ARE REQUIRED TO BE A MINIMUM 6" MAIN. ALL SERVICE LATERALS 3" AND LARGER WILL REQUIRE A MINIMUM 6" TAP WITH 6" GATE VALVE AT THE CONNECTION POINT TO THE UTILITY MAIN WITH THE EXCEPTION OF TAPS ON MAINS
- 16. THE CONTRACTOR IS PROHIBITED FROM TURNING OFF ANY EXISTING MAIN LINE VALVES. THESE WILL BE TURNED OFF BY A REPRESENTATIVE OF THE CITY OF DORAL UTILITY DEPARTMENT AT THE CONTRACTORS ARRANGED TIME AND DATE. 17. ALL EXISTING UTILITY SERVICE CONNECTIONS THAT WILL NOT BE UTILIZED FOR THIS PROJECT SHALL BE ABANDONED AT THE MAIN OR POINT AGREED UPON BY THE UTILITY INSPECTOR, PER CITY OF DORAL SPECIFICATIONS. WATER AND IRRIGATION SERVICES MUST BE ABANDONED AT THE MAIN.
- SEWER LATERALS MUST BE CAPPED AT THE ROW WITH AN APPROVED LOCATOR INSTALLED. A VISUAL INSPECTION MUST BE COMPLETED BY A CITY OF DORAL UTILITIES INSPECTOR. 18. THE ENGINEERS ESTIMATED FLOW DEMANDS FOR POTABLE WATER, IRRIGATION WATER AND SANITARY SEWER MUST BE PROVIDED ON THE UTILITY PAGE OF THE SITE PLANS.
- 19. THE CONTRACTOR WILL NEED TO ADJUST THE EXISTING UTILITIES AFFECTED BY THE NEWLY PROPOSED FINISHED GRADE AT THEIR EXPENSE. THESE ITEMS INCLUDE BUT NOT LIMITED TO; VALVE BOXES, VALVE PADS, VALVE STEM EXTENSIONS, SERVICE CONNECTIONS AND ACCESSORIES, BACKFLOW PREVENTION DEVICES, METER BOXES, FIRE HYDRANTS, MANHOLE COVERS AND/OR ADJUSTMENT RINGS. IT IS THE CONTRACTORS' RESPONSIBILITY TO VERIFY THAT ADEQUATE DEPTHS AND CLEARANCES EXIST TO MAKE THE SYSTEM HYDRAULICS WORK PROPERLY. ANY CHANGES TO EXISTING UTILITIES MUST MEET THE CITY OF DORAL SPECIFICATIONS. DISINFECTION AND RE_SAMPLING WILL BE REQUIRED WHEN ANY EXISTING POTABLE WATER MAIN OR SERVICE IS DISTURBED AND IS THE RESPONSIBILITY OF THE CONTRACTOR AT HIS EXPENSE 20. ALL FIRE LINES AND PRIVATE HYDRANTS WILL REQUIRE THE INSTALLATION OF AN APPROVED DDCV ASSEMBLY INSTALLED AS CLOSE TO THE ROW AS POSSIBLE WITHIN THE PUE. A FIRE HYDRANT RESPONSIBILITY AGREEMENT WILL BE REQUIRED FOR ALL PRIVATE FIRE HYDRANTS. ALL ABOVE GROUND ASSEMBLIES, PIPE, AND FITTINGS MUST BE PAINTED PER CITY OF DORALS TECHNICAL SPECIFICATIONS PROTECTIVE COATINGS SECTION.
- 21. ALL BACKFLOW CERTIFICATIONS MUST BE EMAILED TO THE ASSIGNED UTILITY INSPECTOR. 22. ANY WORK OR MATERIALS WHICH DO NOT CONFORM TO THE CITY OF DORAL'S SPECIFICATIONS OR ANY WORK PERFORMED WITHOUT THE KNOWLEDGE OF THE CITY OF BELL VIEW UTILITY INSPECTORS OR REPRESENTATIVES IS SUBJECT TO REMOVAL AND REPLACEMENT AT THE CONTRACTOR'S
- EXPENSE. 23. THE STANDARD MINIMUM COVER FOR A WATER, IRRIGATION OR FORCE MAIN, WHICH IS NOT UNDER PAVEMENT, IS 30" BELOW THE EDGE OF PAVEMENT. THE MINIMUM COVER FOR WATER MAINS PLACED UNDER PAVEMENT IS 36". PLEASE DEFER TO THE UTILITY
- 24. THE CONTRACTOR SHALL PROVIDE ALL LABOR, MATERIALS, AND EQUIPMENT NECESSARY TO DEWATER TRENCH AND SECURE EXCAVATIONS. THE CONTRACTOR SHALL SECURE ALL NECESSARY PERMITS ASSOCIATED WITH THE CITY OF DORALS UTILITY DESIGN PROCEDURES MANUAL TECHNICAL SPECIFICATIONS. ALL DEWATERING SHALL COMPLY WITH THE REGULATIONS OF THE SOUTH FLORIDA WATER MANAGEMENT DISTRICT AND ANY AGENCY WITH JURISDICTION.
- 25. THE CONTRACTOR SHALL LOCATE AND VERIFY THE SIZE, LOCATION, AND DEPTH OF ALL EXISTING UTILITIES ON SITE. THE LOCATIONS OF EXISTING UTILITIES ARE APPROXIMATE AND MUST BE VERIFIED BY THE CONTRACTOR. THE CONTRACTOR HAS SOLE RESPONSIBILITY TO LOCATE AND PROTECT
- UNDERGROUND UTILITIES IN THE PROJECT AREA. THE CONTRACTOR SHALL HAVE ALL UTILITIES IDENTIFIED AND MARKED PRIOR TO BEGINNING CONSTRUCTION. 26. THE CONTRACTOR SHALL NOTIFY ALL UTILITY COMPANIES IN THE AREA BEFORE BEGINNING CONSTRUCTION AND BE RESPONSIBLE FOR PROTECTION OF ON_SITE UTILITIES INCLUDING LOCATES DURING CONSTRUCTION. ANY UTILITIES THAT ARE DISTURBED OR DAMAGED BY THE CONTRACTOR SHALL BE IMMEDIATELY REPAIRED OR REPLACED BY THE CONTRACTOR AT HIS EXPENSE USING CITY APPROVED MATERIALS AND MUST BE REPORTED TO THE CITY OF DORALS UTILITIES COLLECTION/ DISTRIBUTION DEPARTMENT. ALL REPAIRS MUST BE INSPECTED BY A CITY UTILITIES INSPECTOR PRIOR TO BACKFILL AND RESTORATION. IF THE CONTRACTOR IS UNABLE TO MAKE THE NECESSARY REPAIRS, THE CONTRACTOR WILL BE HELD LIABLE FOR COSTS ASSOCIATED WITH THE REPAIRS BY CITY PERSONNEL.

27. THE CONTRACTOR SHALL ADJUST (AS REQUIRED) PIPELINE ALIGNMENTS HORIZONTALLY AND/OR VERTICALLY TO AVOID CONFLICTS WITH ACTUAL FIELD CONDITIONS AS UNCOVERED DURING CONSTRUCTION. HORIZONTAL AND VERTICAL SEPARATION SHALL CONFORM TO THE CITY OF DORAL

28. THE CONTRACTOR SHALL MAINTAIN A CURRENT AND UPDATED SET OF AS_BUILT DRAWINGS AT ALL TIMES AND PROVIDE ONE COPY TO THE ENGINEER UPON COMPLETION. ACCEPTANCE OF THE COMPLETED UTILITY SYSTEM WILL NOT BE GIVEN FINAL APPROVAL BY THE UTILITIES DEPARTMENT UNTIL AS_BUILT PLANS HAVE BEEN SUBMITTED AND APPROVED BY THE ENGINEER OF RECORD.

### FACILITIES IMPACTS TABLE

ESTIMATED TRIPS (	GENERATED (1 TUNNEL)
WEEKDAY PEAK PM	78 TRIPS
SATURDAY PEAK	41 TRIPS
ESTIMAT	ED DEMANDS
WATER	3,900 GPD
IRRIGATION	300 GPD
SEWER	1,560 GPD

#### **EXISTING LEGEND**

PROPERTY LINE
PROPERTY ADJOINING
LEGAL RIGHT-OF-WAY
EASEMENT
PROPERTY MARKER
EXISTING BUILDING
EXISTING CURB
EXISTING CURB DEPRESSION
EXISTING EDGE OF PAVEMENT
EXISTING EDGE OF GRAVEL
EXISTING FENCE
EXISTING WOOD FENCE
EXISTING METAL FENCE
EXISTING GUIDE RAIL
EXISTING MINOR CONTOUR
EXISTING MAJOR CONTOUR
EXISTING SPOT ELEVATION
EXISTING COMMUNICATION, UNDERGROUND
EXISTING NATURAL GAS, UNDERGROUND
EXISTING POWER, UNDERGROUND
EXISTING SANITARY SEWER, UNDERGROUND
EXISTING STORM SEWER, UNDERGROUND
EXISTING WATER, UNDERGROUND EXISTING OVERHEAD UTILITY
EXISTING OVERHEAD UTILITY
EXISTING MANHOLES
EXISTING VALVES
EXISTING JUNCTION BOX
EXISTING POWER, TRANSFORMER
EVICTING CANUTARY CELVER OF TAR OUT


EXISTING SANITARY SEWER, CLEAN-OUT EXISTING STORM SEWER, ROOF DRAIN EXISTING STORM SEWER, INLET **EXISTING WATER STRUCTURES** EXISTING TREE LINE **EXISTING EXISTING TREES EXISTING BOLLARD** EXISTING SIGN **EXISTING UTILITY POLE** EXISTING GUY POLE BORING LOCATION EXISTING FLAG POLE EXISTING LIGHT EXISTING LIGHT POLE SINGLE ARM

CLIENT

DELTA	DESC	DESCRIPTION DATE
1	×	XX-XX-XX
2	×	XX-XX-XX
3	×	XX-XX-XX
4	×	XX-XX-XX
5	×	XX-XX-XX
9	×	XX-XX-XX

ENGINEER:




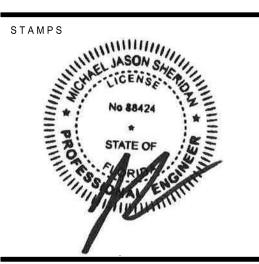

**UTILITY PLAN** 

PROJECT NUMBER


08-01-2022 AS NOTED SCALE DRAWN CHECKED SHEET NO

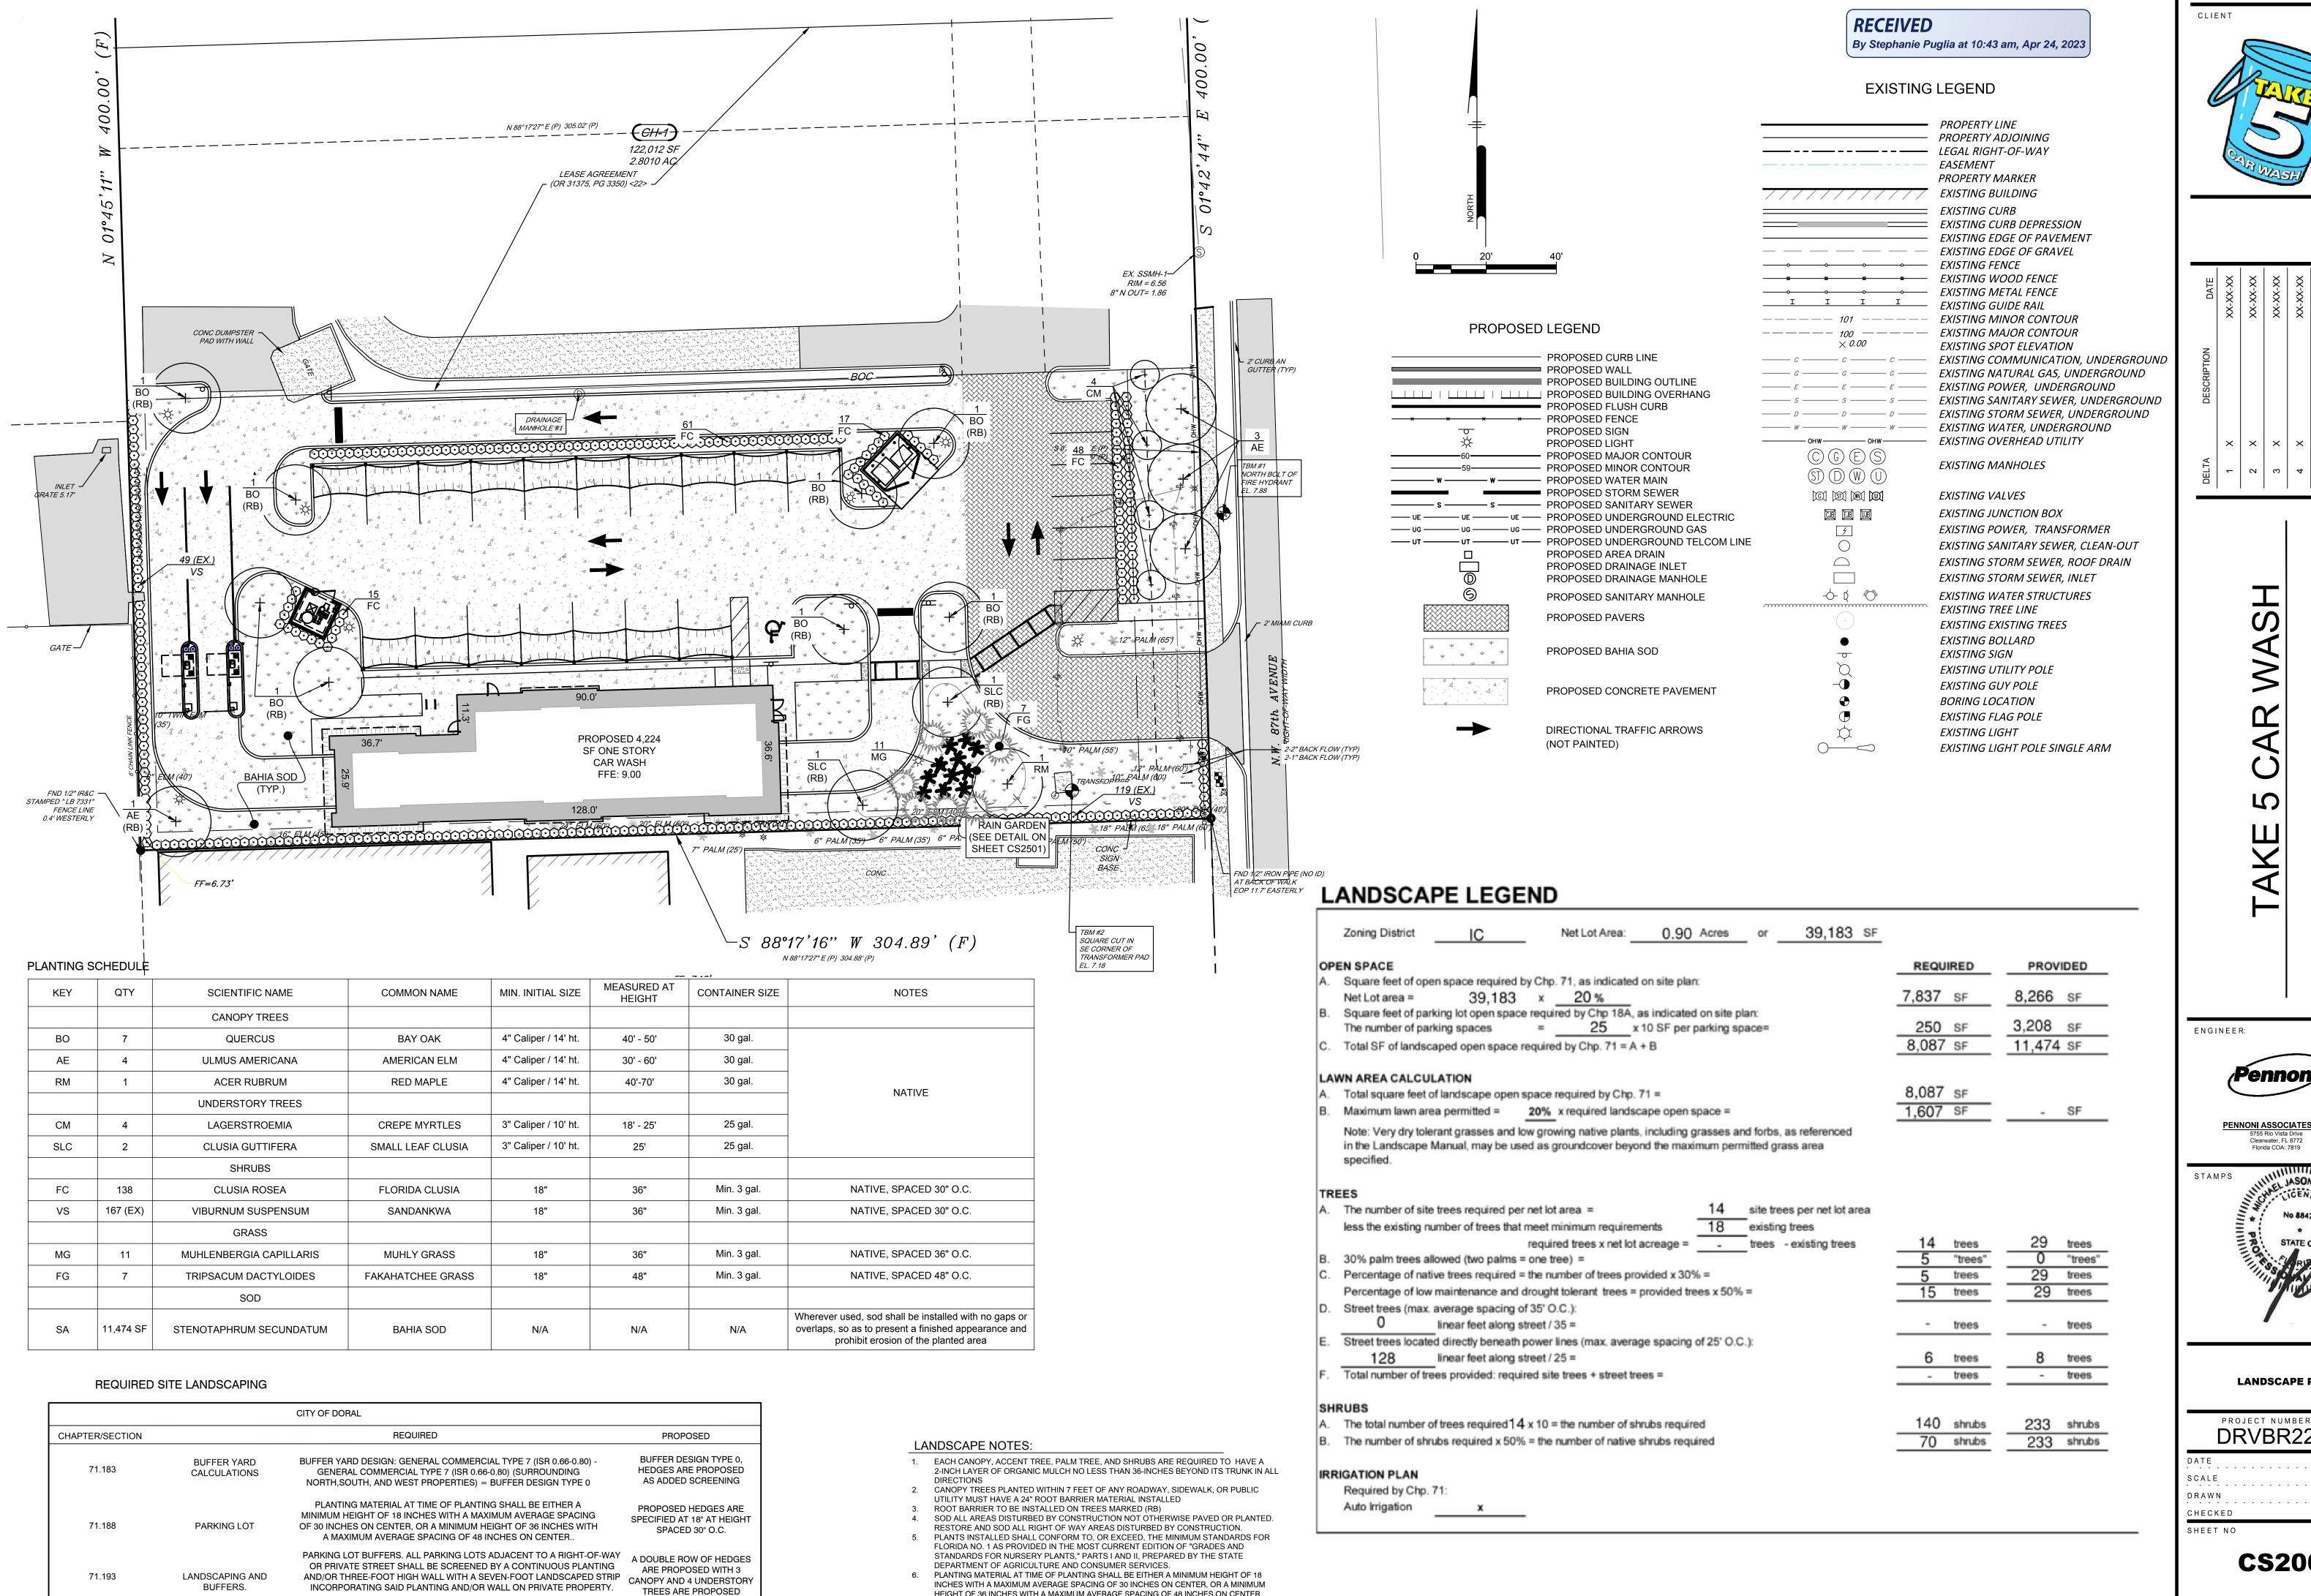

HEIGHT OF 36 INCHES WITH A MAXIMUM AVERAGE SPACING OF 48 INCHES ON CENTER.


 $\stackrel{\circ}{\times}$   $|\stackrel{\circ}{\times}$   $|\stackrel{\circ}{\times}$   $|\stackrel{\circ}{\times}$   $|\stackrel{\circ}{\times}$  $\times | \times | \times | \times | \times | \times$ 

PENNONI ASSOCIATES INC. 5755 Rio Vista Drive

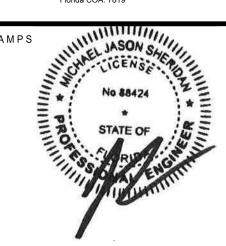


LANDSCAPE PLAN

PROJECT NUMBER **DRVBR22027** 

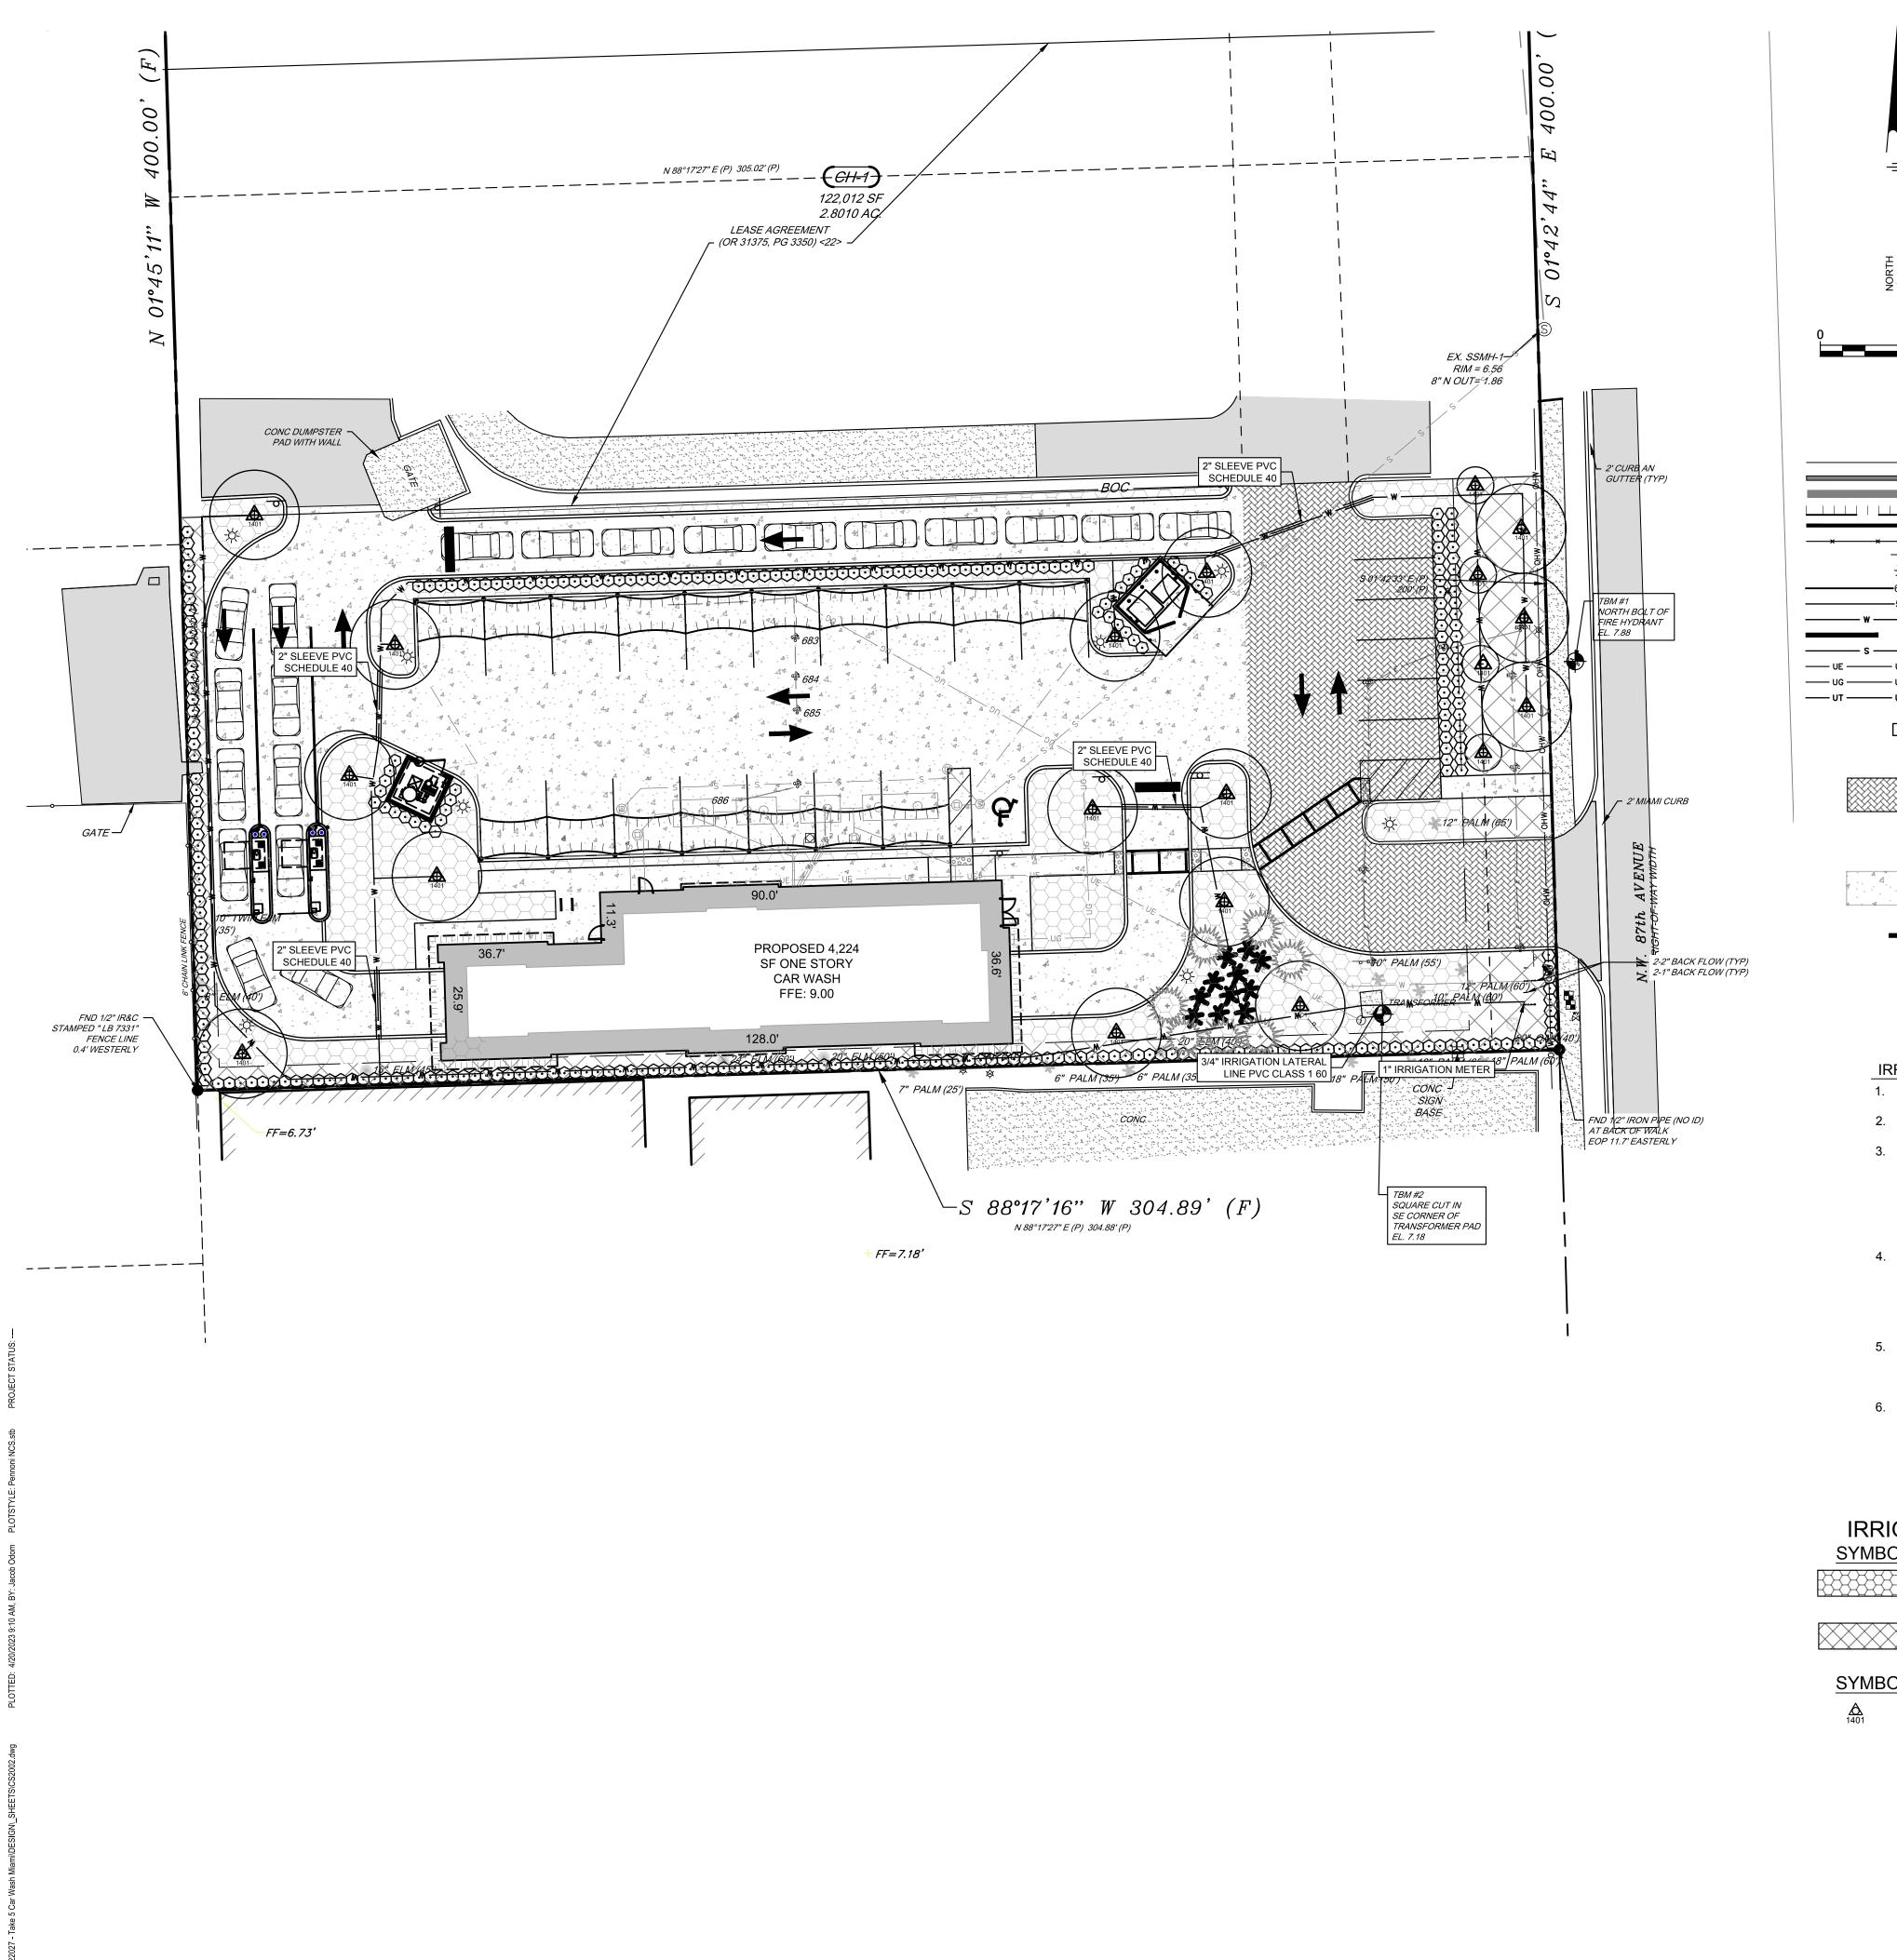

#### **EXISTING LEGEND**

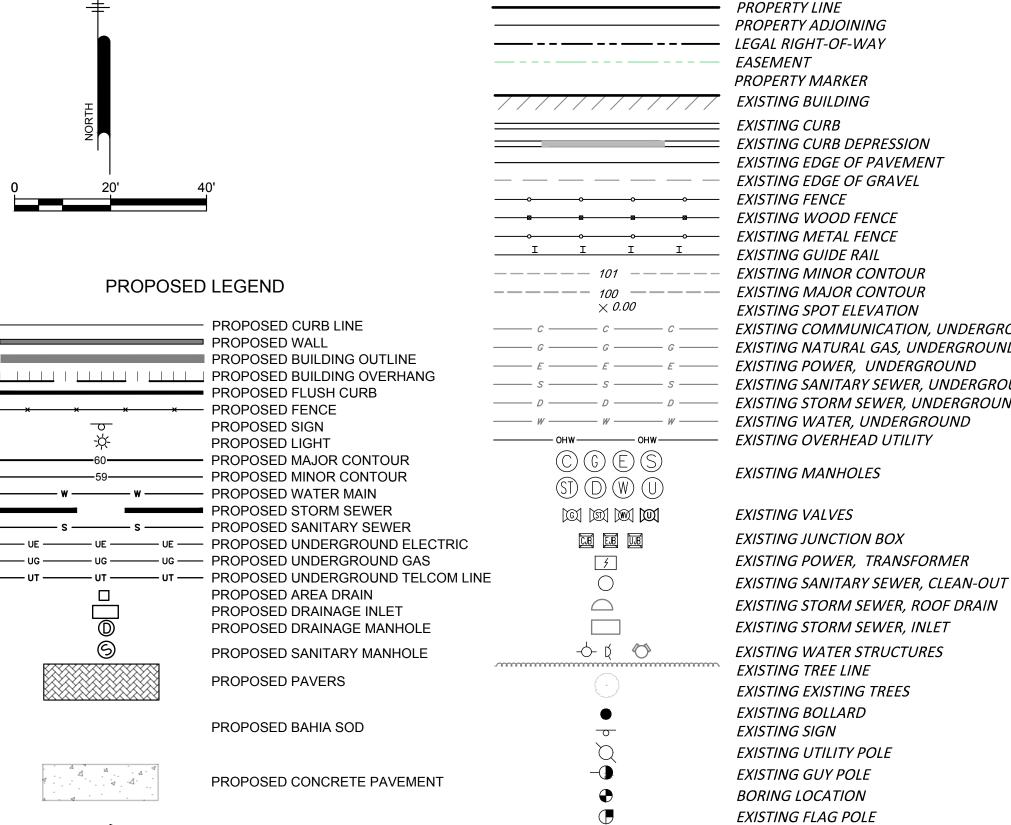

### **IRRIGATION NOTES:**

CONTRACTOR TO RECONNECT IRRIGATION BUBBLERS TO EXISTING TREES DESIGNATED TO REMAIN.

**DIRECTIONAL TRAFFIC ARROWS** 

ALL LANDSCAPING SHALL CONTAIN AN AUTOMATIC IRRIGATION SYSTEM.

(NOT PAINTED)

- 3. ALL REQUIRED IRRIGATION SYSTEMS SHALL BE DESIGNED TO MINIMIZE THE APPLICATION OF WATER TO IMPERVIOUS AREAS, INCLUDING ROADS, DRIVES, AND OTHER VEHICLE AREAS. REQUIRED IRRIGATION SHALL ALSO BE DESIGNED TO AVOID DAMAGE TO EXISTING NATIVE VEGETATION FROM OVER WATERING OR FROM PHYSICAL CONFLICTS WITH PLANT ROOTS.
- 4. THE IRRIGATION SYSTEM SHALL BE PROPERLY MAINTAINED AND OPERATED CONSISTENT WITH WATERING SCHEDULES ESTABLISHED BY THE SOUTHWEST FLORIDA WATER MANAGEMENT DISTRICT OR THE CITY OF DORAL, WHICHEVER IS MORE RESTRICTIVE. EXISTING NATIVE PLANTS ARE EXEMPT FROM THIS REQUIREMENT.
- 5. AUTOMATIC CONTROL SYSTEMS SHALL BE EQUIPPED WITH AN OPERABLE RAIN SENSOR OR OTHER DEVICES, SUCH AS SOIL MOISTURE SENSORS, TO PREVENT UNNECESSARY IRRIGATION.
- 6. CONTRACTOR TO SUBMIT FULL IRRIGATION DESIGN, MEETING THE REQUIRED PRECIPITATION RATES IN VEGETATED AREAS TO ENGINEER FOR APPROVAL PRIOR TO CONSTRUCTION

#### **IRRIGATION LEGEND:**

SYMBOL	DESCRIPTION	<u>QTY</u>	
	TURF SPRAYAREA 4'-15' RADIUS, TRIANGULAR SPACED, HEAD TO HEAD COVERAGE.	5,598 SF	1.9 in/h
	BUFFER SPRAYAREA 4'-15' RADIUS, TRIANGULAR SPACED, HEAD TO HEAD COVERAGE.	2,439 SF	1.9 in/h
SYMBOL	DESCRIPTION	<u>QTY</u>	
A	RAIN BIRD 1806-PRS30 12' RADIUS	19	



EXISTING LIGHT

EXISTING LIGHT POLE SINGLE ARM




/EMENT AVEL								
E E TOUR TOUR	DATE	XX-XX-XX	XX-XX-XX	XX-XX-XX	XX-XX-XX	XX-XX-XX	XX-XX-XX	
TION ATION, UNDERGROUND S, UNDERGROUND DERGROUND WER, UNDERGROUND ER, UNDERGROUND DERGROUND DERGROUND DERGROUND	DESCRIPTION	×	×	×	×	×	×	

ENGINEER:




PENNONI ASSOCIATES INC.
5755 Rio Vista Drive
Clearwater, FL 8772
Florida COA: 7819

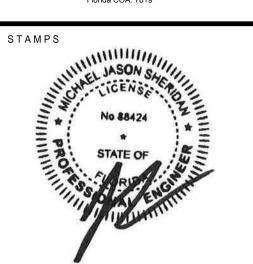


**IRRIGATION PLAN** 

PROJECT NUMBER DRVBR22027 08-01-2022

SCALE AS NOTED DRAWN CHECKED SHEET NO

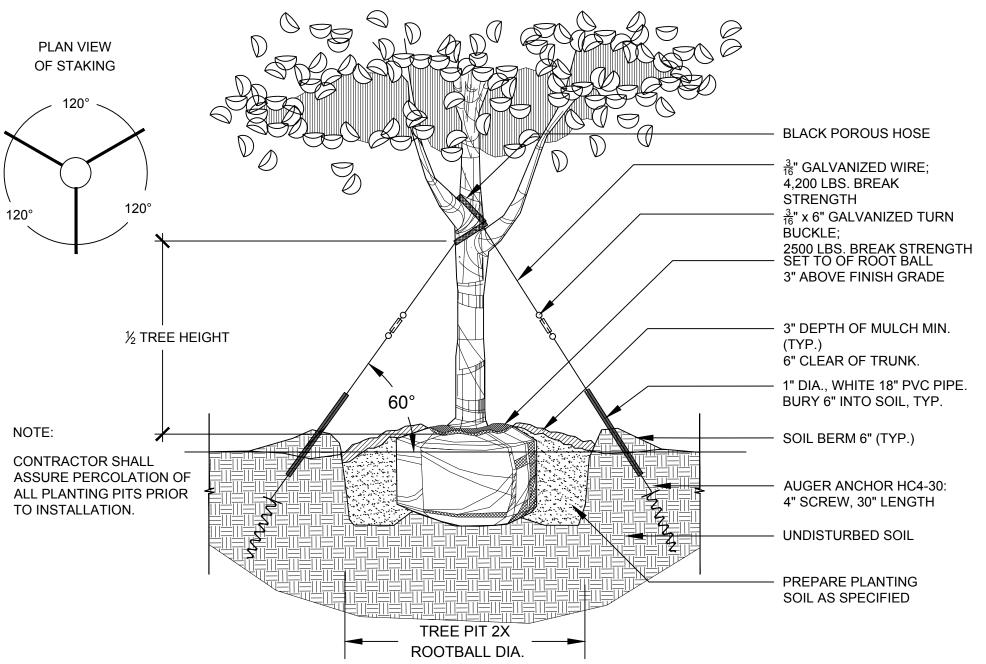


DETAIL- SHRUB AND BUFFER PLANTING

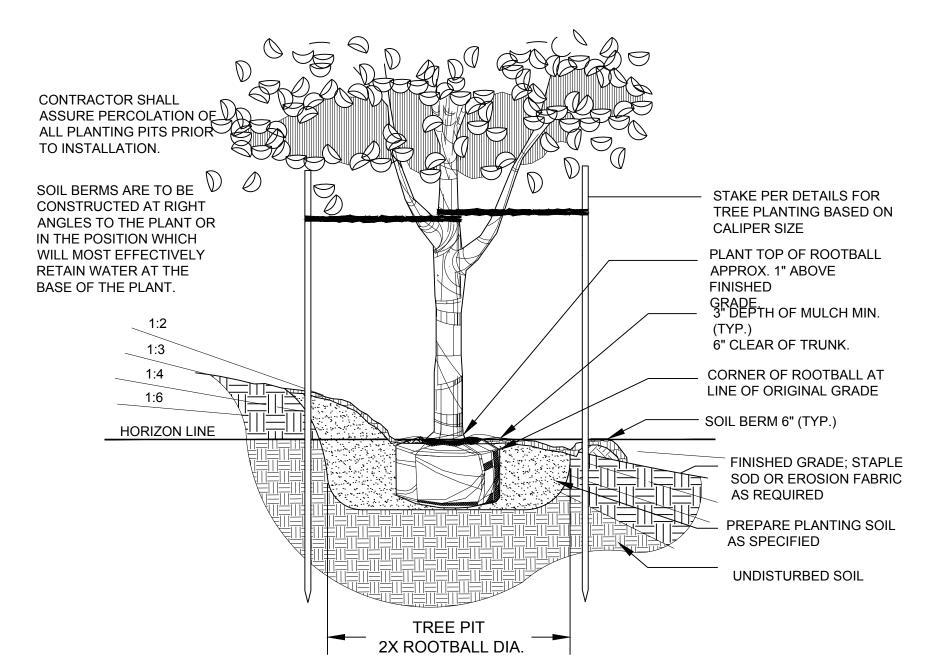


**DETAIL-** TREE PLANTING ON SLOPE

**DETAIL-** TREE PLANTING - 3" TO 7" CAL

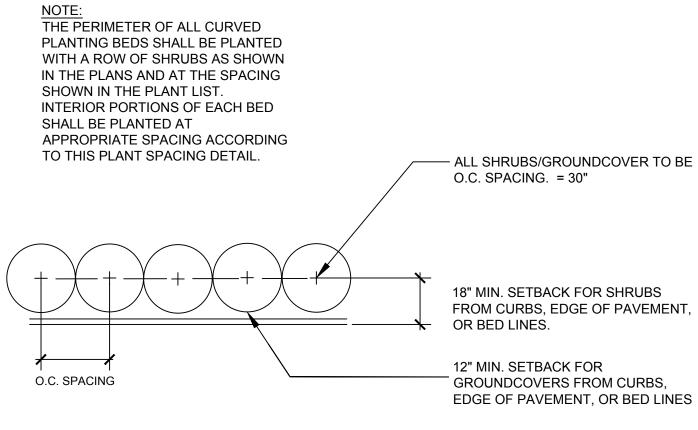

DETAIL- SHRUB AND BUFFER SPACING

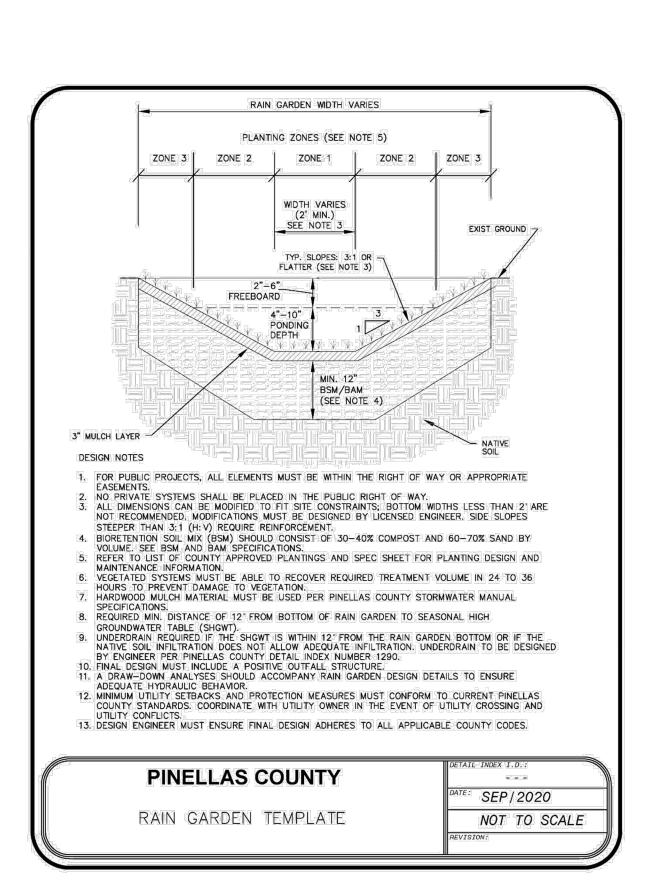

- EXCAVATE AND REMOVE 3" OF EXISTING

BACKFILL ALL SHRUB BED AREAS WITH

3" OF PREPARED PLANTING SOIL. ROTOTILL

UNTIL SOIL IS UNIFORMLY BLENDED TO A

CONTINUOUS SOIL BERM AT EDGE OF

FINISH GRADE (SEE GRADING PLAN)

NOTE: CONTRACTOR SHALL ASSURE

PERCOLATION OF ALL PLANTING

PITS / BEDS PRIOR TO INSTALLATION

· AUGER PLANT MATERIAL WITH A BIT

SIZED AS LISTED WITHIN CHART BELOW

TO A DEPTH OF 6" BELOW BOTTOM OF

ROOTBALL 1" ABOVE FINISHED GRADE.

FINISH GRADE (SEE GRADING PLAN)

PREPARED PLANTING SOIL

DO NOT SPREAD MULCH OVER ROOTBALL

SITE SOIL IN ALL SHRUB BED AREAS

DEPTH OF 8"-12".

ROOTBALL, TYP.

- 3" MULCH, TYP.

AS SPECIFIED

PLANTING BED, TYP.

1. PLANTING BED PREPARATION

2. PLANT MATERIAL INSTALLATION

Figure 4.13.1: Pinellas County CAD template for rain gardens

Page 123

#### LANDSCAPE NOTES:

- 1. THE CONTRACTOR SHALL REVIEW PLANS TO BECOME THOROUGHLY FAMILIAR WITH SURFACE AND SUBSURFACE UTILITIES.
- 2. THE PLANT QUANTITIES SHOWN ON THE LANDSCAPE CONTRACT DOCUMENTS ARE FOR THE CONVENIENCE OF THE CONTRACTOR. THE CONTRACTOR IS RESPONSIBLE FOR VERIFYING ALL QUANTITIES AND REPORTING ANY DISCREPANCIES TO THE ENGINEER FOR CLARIFICATION PRIOR TO CONTRACT
- AWARD AND COMMENCEMENT OF WORK.

  3. ALL INSTALLATION OF PLANT MATERIAL SHALL COMPLY WITH APPLICABLE JURISDICTIONAL CODES. THE CONTRACTOR IS RESPONSIBLE FOR OBTAINING ALL PERMITS ASSOCIATED WITH THIS WORK.
- JURISDICTIONAL CODES. THE CONTRACTOR IS RESPONSIBLE FOR OBTAINING ALL PERMITS ASSOCIATED WITH THIS WORK.

  4. PRIOR TO PLANTING INSTALLATION, THE CONTRACTOR SHALL CONFIRM THE AVAILABILITY OF ALL THE SPECIFIED PLANT MATERIALS. SUBMIT DATED
- PHOTOGRAPHS OF ALL TREE MATERIAL AND SPECIMEN MATERIAL AS TO THE OWNER'S REPRESENTATIVE FOR REVIEW.

  5. ALL PLANT MATERIAL SIZES SPECIFIED ARE MINIMUM SIZES. CONTAINER SIZE
- SHALL BE INCREASED IF NECESSARY TO PROVIDE OVERALL PLANT SIZE SPECIFIED.

  6. IF PLANT MATERIAL DOES NOT COMPLY WITH THE REQUIREMENTS AS SPECIFIED HEREIN, THE OWNER'S REPRESENTATIVE RESERVES THE RIGHT
- SPECIFIED HEREIN, THE OWNER'S REPRESENTATIVE RESERVES THE RIGH'
  TO REJECT SUCH PLANTS AND REQUIRE THE CONTRACTOR TO REPLACE
  REJECTED WORK AND CONTINUE SPECIFIED MAINTENANCE UNTIL
  RE-INSPECTED AND FOUND TO BE ACCEPTABLE.
- THE CONTRACTOR SHALL PROVIDE AN APPROVED PLANTING SOIL MIXTURE FOR ALL PLANT MATERIAL. SEE SPECIFICATIONS FOR REQUIREMENTS. THE CONTRACTOR SHALL BE RESPONSIBLE FOR STABILITY AND PLUMB CONDITION OF ALL TREES AND SHRUBS, AND SHALL BE LEGALLY LIABLE FOR ANY DAMAGE CAUSED BY INSTABILITY OF ANY PLANT MATERIALS. STAKING OF TREES OR SHRUBS SHALL BE DONE IN ACCORDANCE WITH PLANS AND
- SPECIFICATIONS.

  9. THE CONTRACTOR SHALL ENSURE ADEQUATE VERTICAL DRAINAGE IN ALL PLANT BEDS AND PLANTERS. IF INADEQUATE VERTICAL DRAINAGE IS ENCOUNTERED, THE CONTRACTOR SHALL SUBMIT RECOMMENDATIONS FOR PROVIDING ADEQUATE DRAINAGE TO THE OWNER'S REPRESENTATIVE.
- PEG SOD ON SLOPES GREATER THAN 3:1.
   CONTRACTOR SHALL INVESTIGATE SITE AND REMOVE ALL INVASIVE PLANT SPECIES LISTED BY SOUTHWEST FLORIDA WATER MANAGEMENT DISTRICT WITH APPROPRIATE HERBICIDE OR MECHANICAL METHODS ON AN ANNUAL BASIS
- CONTRACTOR SHALL PROTECT EXISTING VEGETATION TO REMAIN AS SHOWN ON DRAWINGS OR BY MEANS APPROVED BY THE OWNER'S REPRESENTATIVE.
   CONTRACTOR TO CLEAN, PRUNE, AND SHAPE EDGES OF EXISTING VEGETATION AS DIRECTED BY OWNER'S REPRESENTATIVE. CREATE SMOOTH
- BED LINES AROUND EXISTING VEGETATION.

  14. THE CONTRACTOR SHALL BEAR ALL COSTS OF TESTING OF SOILS, AMENDMENTS, ETC. ASSOCIATED WITH THE WORK. SEE SPECIFICATIONS FOR
- ADDITIONAL TESTING REQUIREMENTS.

  15. CONTRACTOR SHALL FIELD-ADJUST LOCATION OF PLANT MATERIAL PRIOR TO INITIATING INSTALLATION FOR THE REVIEW AND APPROVAL OF THE OWNER'S REPRESENTATIVE.
- 16. ALL PLANT MATERIAL SHALL BE IN FULL AND STRICT ACCORDANCE WITH FLORIDA NO. 1 GRADE, ACCORDING TO THE "GRADES AND STANDARDS FOR NURSERY PLANTS" PUBLISHED BY THE FLORIDA DEPARTMENT OF AGRICULTURE AND CONSUMER SERVICES.
- 17. EACH CANOPY TREE, ACCENT TREE, AND PALM TREE MUST HAVE ORGANIC MULCH NO LESS THAN 36 INCHES BEYOND ITS TRUNK IN ALL DIRECTIONS
  18. CONTRACTOR SHALL COORDINATE ALL PLANTING WORK WITH IRRIGATION WORK. CONTRACTOR SHALL BE RESPONSIBLE FOR ALL HAND WATERING AS

- REQUIRED TO SUPPLEMENT IRRIGATION WATERING AND RAINFALL.

  19. CONTRACTOR SHALL BE RESPONSIBLE FOR HAND WATERING IN ALL PLANTING AREAS, REGARDLESS OF THE STATUS OF EXISTING OR PROPOSED
- 1RRIGATION.

  20. CONTRACTOR SHALL RE-GRADE ALL AREAS DISTURBED BY PLANT REMOVAL,

  PEL OCATION, AND/OR INSTALLATION WORK
- RELOCATION, AND/OR INSTALLATION WORK.
  21. CONTRACTOR SHALL REPLACE (BY EQUAL SIZE AND QUALITY) ANY AND ALL EXISTING PLANT MATERIAL DISTURBED OR DAMAGED BY PLANT REMOVAL,
- RELOCATION, AND/OR INSTALLATION WORK.

  22. MAINTENANCE SHALL BEGIN AFTER EACH PLANT HAS BEEN INSTALLED AND SHALL CONTINUE UNTIL THE PROJECT HAS BEEN DEEMED SUBSTANTIALLY COMPLETE. MAINTENANCE INCLUDES WATERING, PRUNING, WEEDING, MULCHING, REPLACEMENTS OF SICK OR DEAD PLANTS, AND ANY OTHER CARE NECESSARY FOR THE PROPER GROWTH OF THE PLANT MATERIAL.
- 23. UPON COMPLETION OF ALL LANDSCAPING, AN INSPECTION FOR SUBSTANTIAL COMPLETION OF THE WORK SHALL BE HELD. THE CONTRACTOR SHALL NOTIFY THE OWNER'S REPRESENTATIVE FOR SCHEDULING THE INSPECTION AT LEAST SEVEN (7) DAYS PRIOR TO THE ANTICIPATED INSPECTION DATE.
- AT LEAST SEVEN (7) DAYS PRIOR TO THE ANTICIPATED INSPECTION DATE.

  24. CONTRACTOR SHALL SUBMIT WRITTEN GUARANTEE OF SURVIVABILITY OF ALL PLANT MATERIAL FOR A PERIOD OF ONE YEAR FROM DATE OF SUBSTANTIAL
- 25. CONTRACTOR MUST REVIEW AND ACCEPT, APPROVE ALL GRADED AREAS PRIOR TO THE COMMENCEMENT OF PLANTING.
- 26. TREES ADJACENT TO BUILDINGS SHOULD BE PLANTED AT LEAST THE DIAMETER OF THE TREE CANOPY OR A MIN. OF 10'-0" (WHICHEVER IS
- GREATER) AWAY FROM THE BUILDING WALL.

  27. CONTRACTOR IS RESPONSIBLE FOR THE REPAIR OF ANY EXISTING LAWN AREAS OR PLANTING AREAS DISTURBED DURING THE CONSTRUCTION PROCESS
- 28. ALL TRIMMING UNDERTAKEN ON A TREE PROTECTED BY THE PROVISIONS OF THE LAND DEVELOPMENT CODE SHALL BE IN ACCORDANCE WITH THE AMERICAN NATIONAL STANDARDS INSTITUTE (ANSI) A-300 PRUNING
- STANDARDS.

  29. SHRUBBERY USED FOR SCREENING SHALL BE A MINIMUM HEIGHT OF 24 INCHES AND SHALL BE SPACED 3 FEET ON CENTER. TREES SHALL HAVE A MINIMUM HEIGHT OF 6 FEET.
- 30. PRUNING OF A GRAND OAK, WITH THE EXCEPTION OF MINOR PRUNING, IS PROHIBITED UNLESS CONDUCTED IN ACCORDANCE WITH THE ANSI-A-300 PRUNING STANDARDS, AND PERFORMED BY AN ARBORIST CERTIFIED BY THE INTERNATIONAL SOCIETY OF ARBORICULTURE (ISA) OR A REGISTERED CONSULTING ARBORIST WITH THE AMERICAN SOCIETY OF CONSULTING ARBORISTS (ASCA). A NOTARIZED AFFIDAVIT (ATTACHED) AFFIRMING AN ISA CERTIFIED ARBORIST OR AN ASCA REGISTERED CONSULTING ARBORIST WILL CONDUCT OR PROVIDE ONSITE SUPERVISION OF THE PRUNING SHALL BE SUBMITTED TO THE COUNTY PRIOR TO THE PRUNING OF A GRAND OAK. AN ISA CERTIFIED ARBORIST OR AN ASCA REGISTERED CONSULTING ARBORIST CONTRACTED BY A PROPERTY OWNER TO PRUNE A GRAND OAK SHALL ASSUME FULL RESPONSIBILITY FOR ALL PRUNING ACTIVITIES DETERMINED IN NONCOMPLIANCE WITH STANDARDS SPECIFIED WITHIN THE LAND DEVELOPMENT CODE.

TANKE O

CLIENT

X XX-XX-XX

AVENUE


ENGINEER:



<


PENNONI ASSOCIATES INC.

5755 Rio Vista Drive
Clearwater, FL 8772
Florida COA: 7819

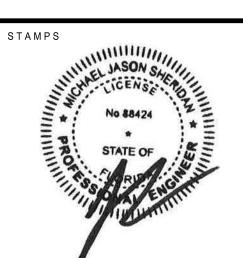

LANDSCAPE DETAILS

DRAWN CHECKED SHEET NO

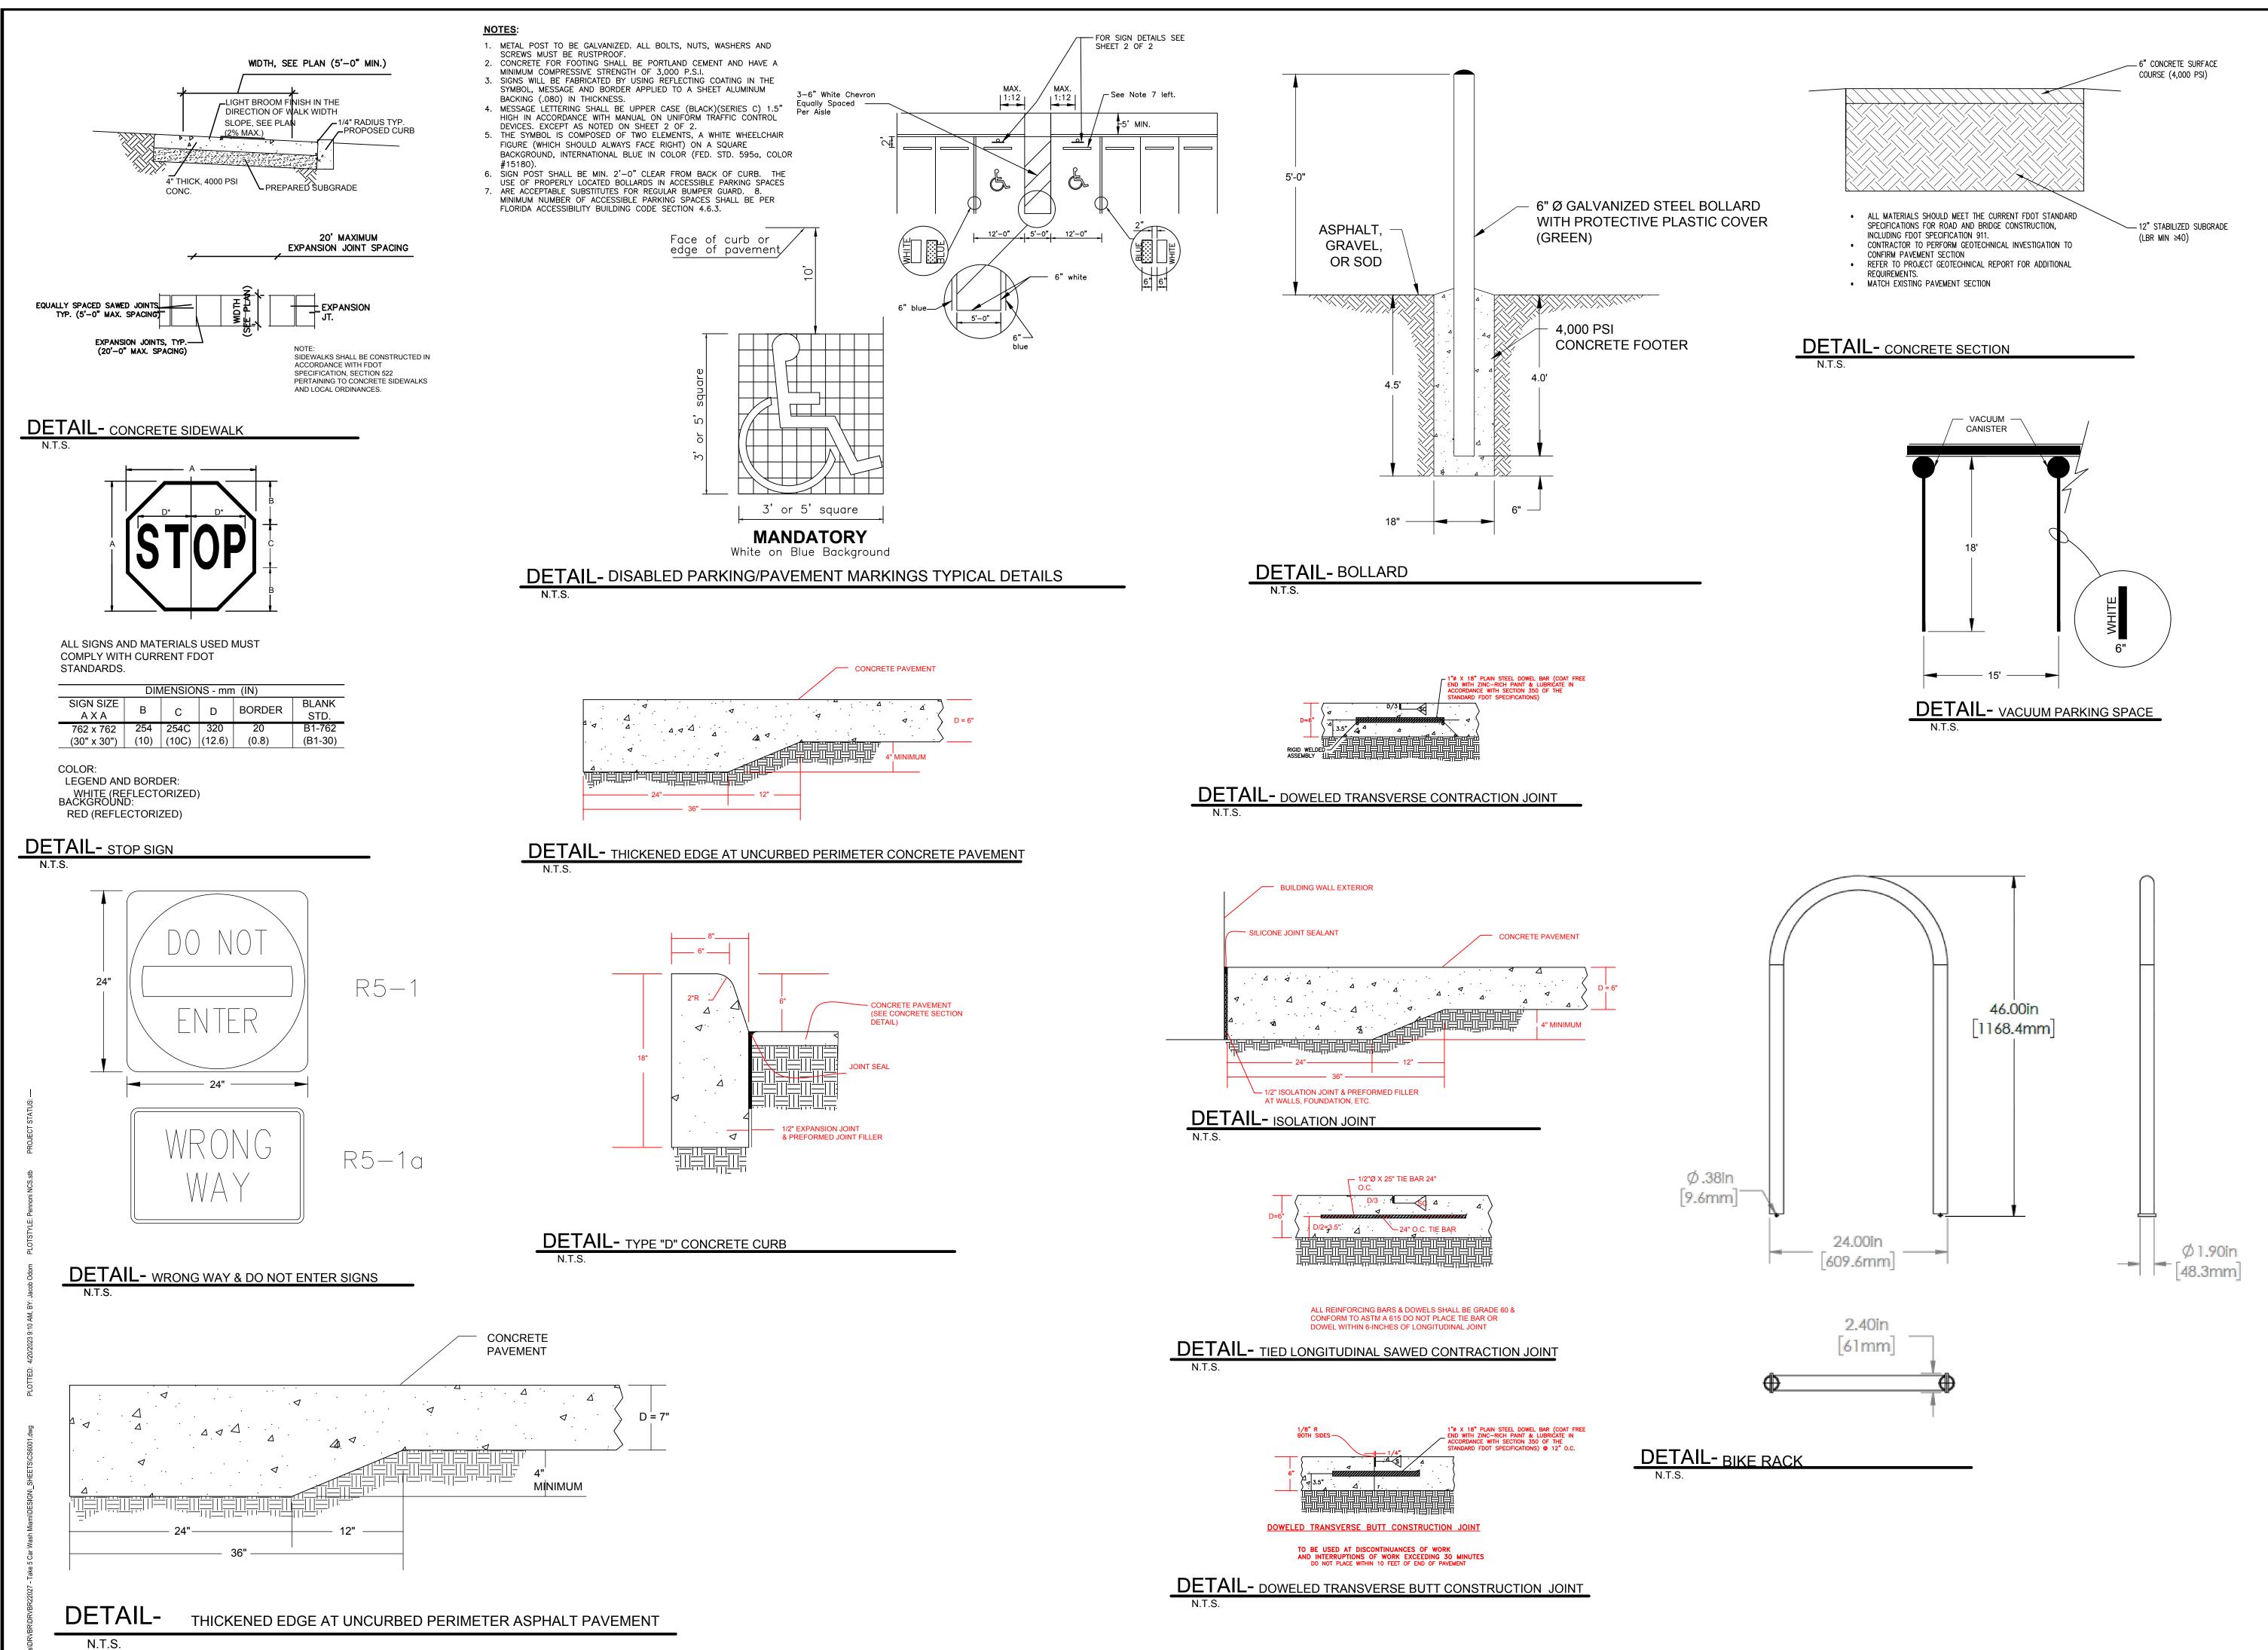



 DESCRIPTION
 DATE

 1
 X

 2
 X

 3
 X

 4
 X

 5
 X

 6
 X

1350 NW 87TH AVENUE

Pennoni Pennoni

PENNONI ASSOCIATES INC.

5755 Rio Vista Drive
Clearwater, FL 8772
Florida COA: 7819

STAMPS

JASON S

IGENS


No 88424

STATE OF

SITE DETAILS

DRVBR22027


DATE 08-01-2022
SCALE AS NOTED
DRAWN JO
CHECKED JS
SHEET NO

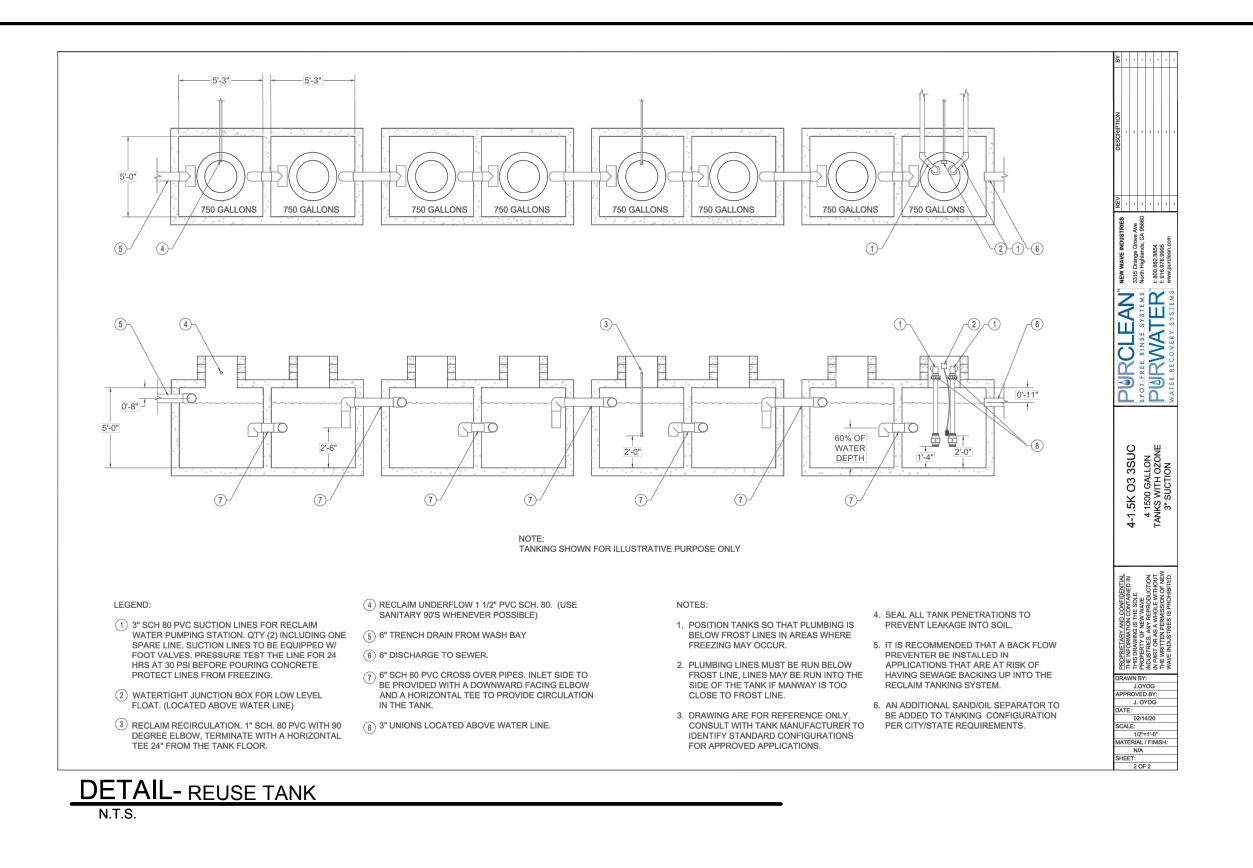

ON RAMPS THAT ARE PERPENDICULAR WITH THE CURB LINE, THE DOME PATTERN SHALL BE IN-LINE WITH THE DIRECTION OF TRAVEL. ON RAMPS INTERSECTION CURBS ON A RADIUS, THE DOME PATTERN SHALL BE IN-LINE WITH THE DIRECTION OF TRAVEL TO THE EXTENT PRACTICAL. — TRUNCATED DOME ∼INTEGRAL DOME THE TOP WIDTH OF THE DOME SHALL BE A MINIMUM OF 50% AND A MAXIMUM OF 65% OF THE BASE DIAMETER. TRUNCATED DOME BASE-TO-BASE SPACING SHALL BE 0.65" MINIMUM BETWEEN DOMES

ALL SIDEWALK CURB RAMPS SHALL HAVE DETECTABLE WARNING SURFACES THAT EXTEND THE FULL WIDTH OF THE RAMP AND IN THE DIRECTION OF TRAVEL 24 INCHES (610 mm) FROM THE BACK OF CURB.

PLAN VIEW

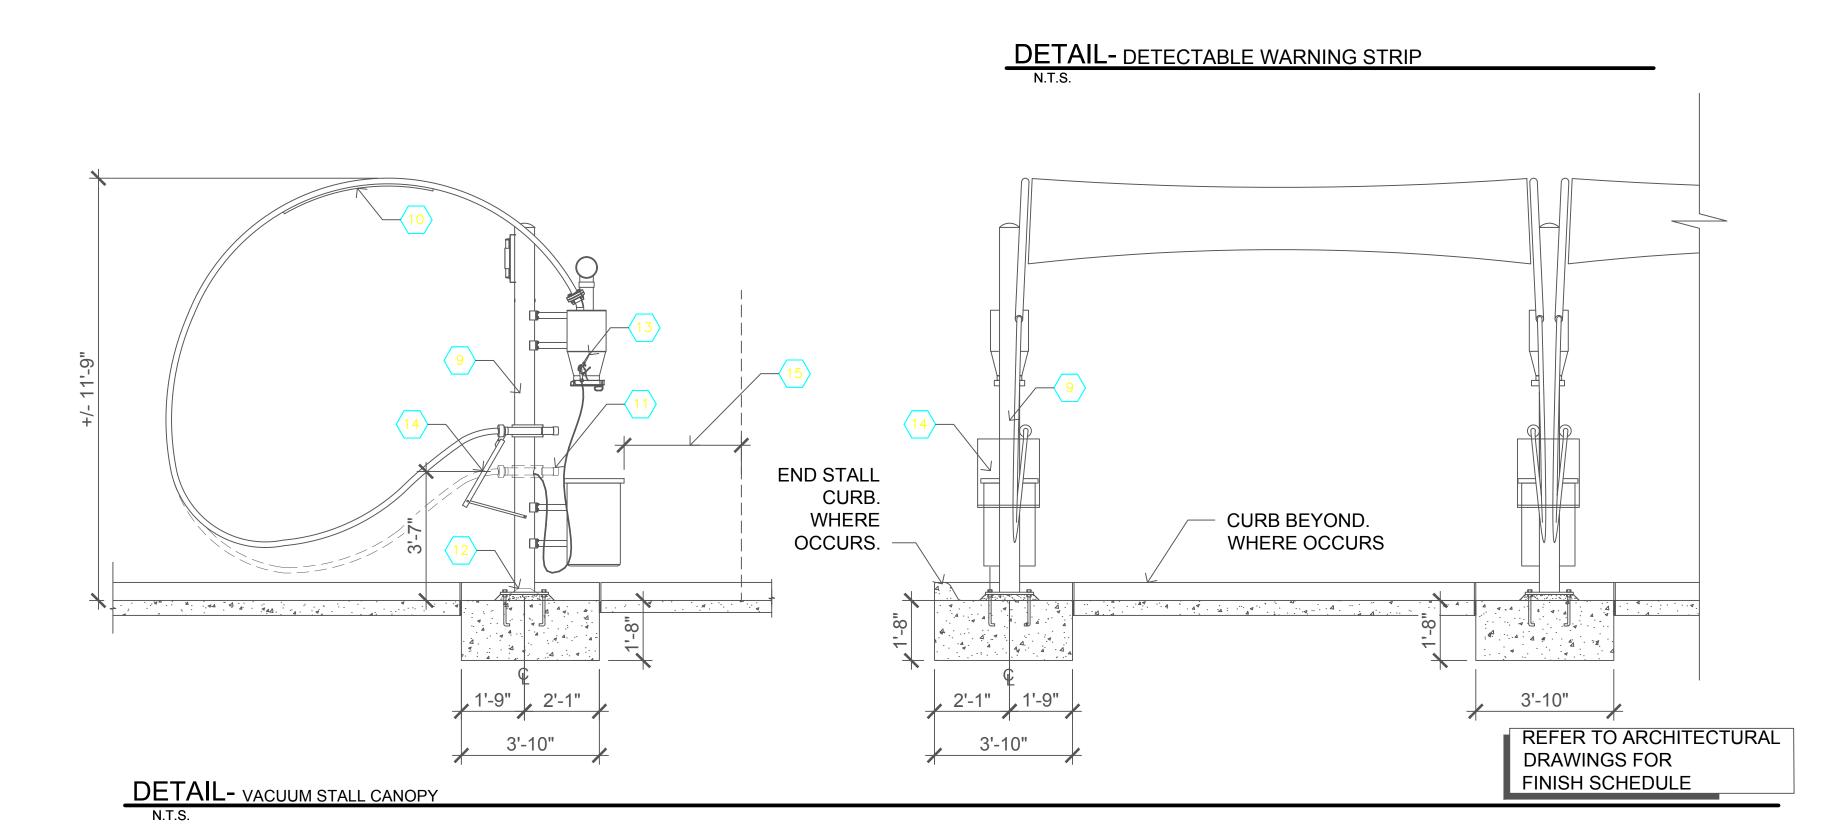

OWNER FURNISHED PRODUCTS AND NOTES

1. VACUUM EQUIPMENT FURNISHED AND INSTALLED BY OWNER'

UNDERGROUND VACUUM SUCTION PIPES. REFER TO A100 FOR

- 24" DIA. X 48" DEEP

ARCHITECTURAL PLANS FOR FINISH COLORS & EQUIPMENT

GENERAL CONTRACTOR SHALL FURNISH AND INSTALL


✓ BACK-UP VACUUM PIPE


- BOLLARD PER CIVIL

**DETAIL-** DUMPSTER AND VACUUM ENCLOSURE

24" DIA. X 48" DEEP FOOTING. SPRING LOADED - GATE CASTER (S)

BACK-UP VACUUM PIPE PRIMARY VACUUM PIPE -

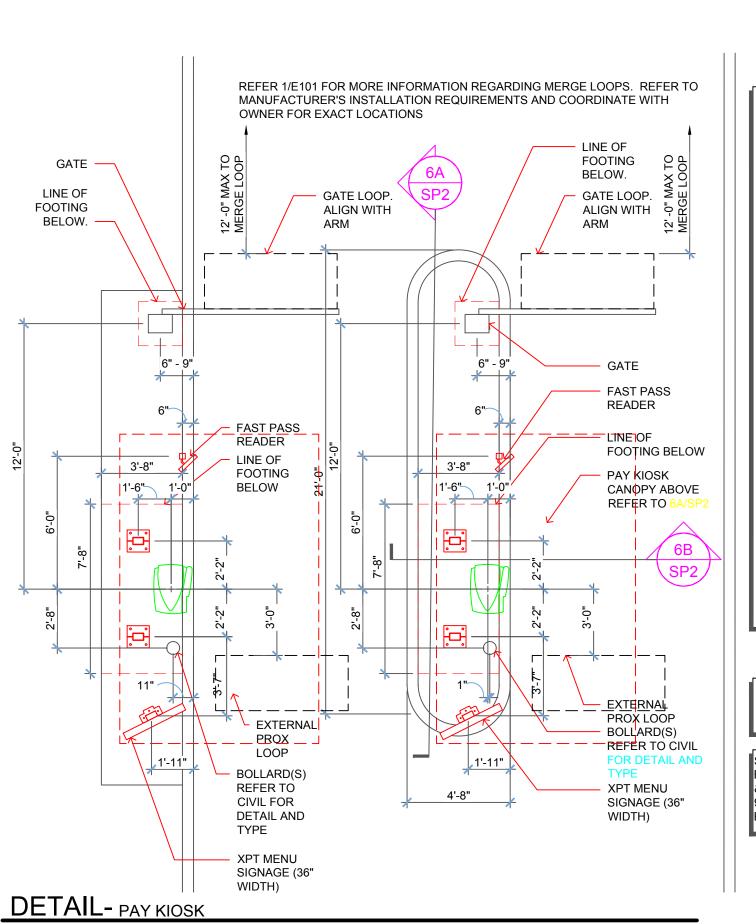

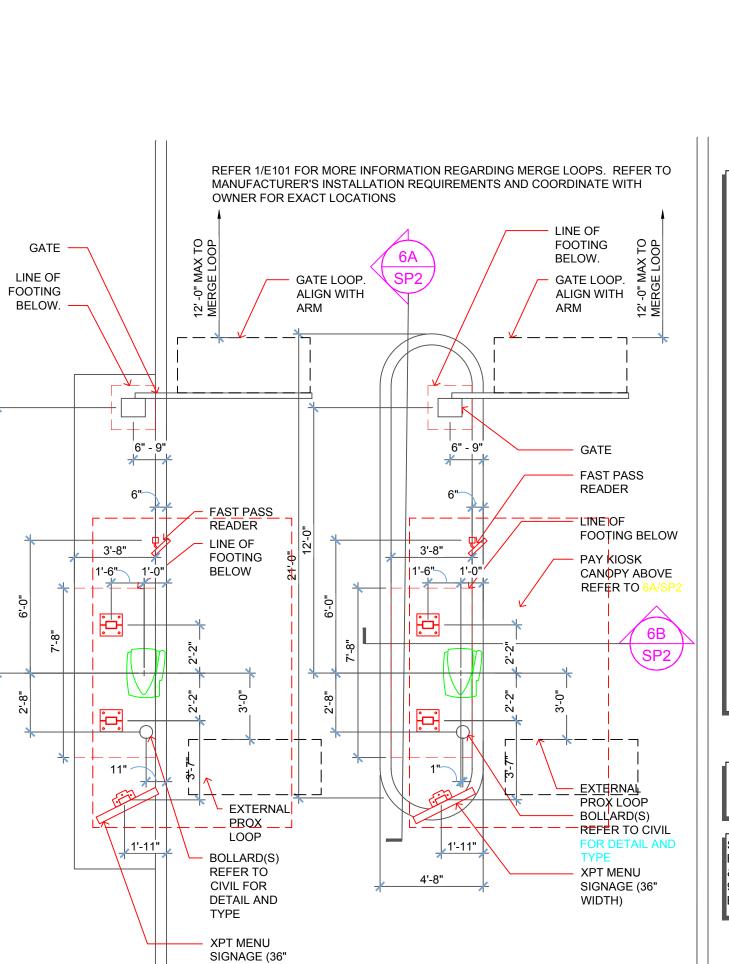

Sidewalk Curb (Where Necessary) —

Rdwy. Pavt.

DETAIL- CR-C RAMP

Ramp

PLAN VIEW

(CR-C)

NOTE: For additional information on sidewalk curb construction, see SIDEWALK CURB OPTIONS details.

6'-0" (Shown)

Sidewalk Curb

→ | ✓ (Where Necessary)

(See Note)



DATE	XX-XX-XX	XX-XX-XX	XX-XX-XX	XX-XX-XX	XX-XX-XX	XX-XX-XX	
DESCRIPTION							
	×	×	×	×	×	×	
DELTA	1	2	ဗ	4	5	9	

ENGINEER:

PENNONI ASSOCIATES INC.
5755 Rio Vista Drive
Clearwater, FL 8772
Florida COA: 7819

STAMPS

REFER TO ELECTRICAL FOR POWER AND DATA REQUIREMENTS XPT CANOPY (TSS) FURNISHED AND INSTALLED BY OWNER'S CONTRACTOR. REFER TO ELECTRICAL FOR POWER AND

OWNER FURNISHED PRODUCTS AND NOTES

ALL FOOTINGS AND ANCHOR BOLTS FURNISHED AND INSTALLED BY GENERAL

XPT PAY KIOSK FURNISHED AND

FOR MORE INFORMATION.

DATA REQUIREMENTS

REQUIREMENTS

CONTRACTOR. REFER TO STRUCTURAL

INSTALLED BY OWNER'S CONTRACTOR.

GATE FURNISHED AND INSTALLED BY OWNER'S CONTRACTOR. REFER TO ELECTRICAL FOR POWER AND DATA

FAST PASS READER FURNISHED AND INSTALLED BY OWNER'S CONTRACTOR.

REFER TO ELECTRICAL FOR POWER AND

DATA REQUIREMENTS XPT MENU SIGNAGE FURNISHED AND INSTALLED BY OWNER'S CONTRACTOR. REFER TO ELECTRICAL FOR POWER AND

DATA REQUIREMENTS LOOPS FURNISHED BY OWNER AND INSTALLED BY GENERAL CONTRACTOR. REFER TO MANUFACTURER'S INSTALLATION REQUIREMENTS AND COORDINATE WITH OWNER FOR EXACT LOCATIONS


REFER TO CIVIL PAVING DRAWINGS FOR ALL PAVING SPECIFICATIONS AND DIMENSIONAL CONTROLS.


SINGLE POINT OF CONTACT: BOB MCQUAGE, ICWG ENGINEERING & TECHNICAL DIRECTOR 901.870.3498 BOBMCQUAGE@ICWG.COM


SITE DETAILS


PROJECT NUMBER **DRVBR22027** 

DATE CALE AS NOTED SCALE DRAWN CHECKED SHEET NO

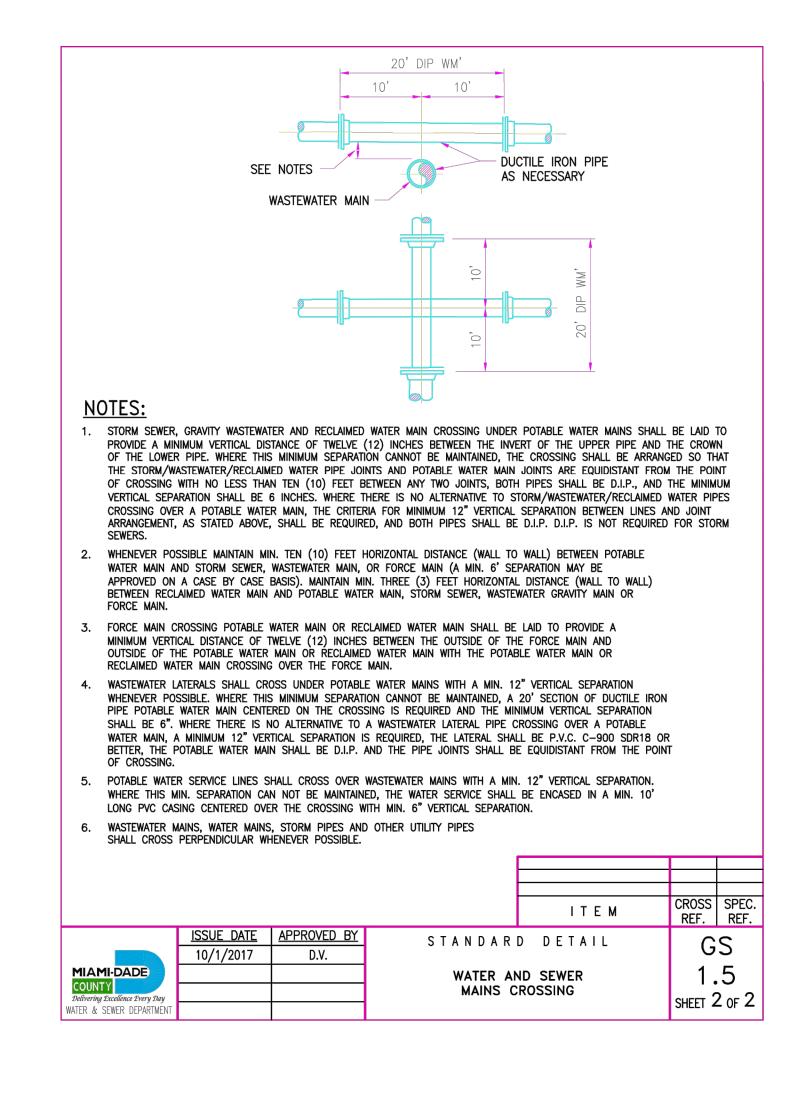

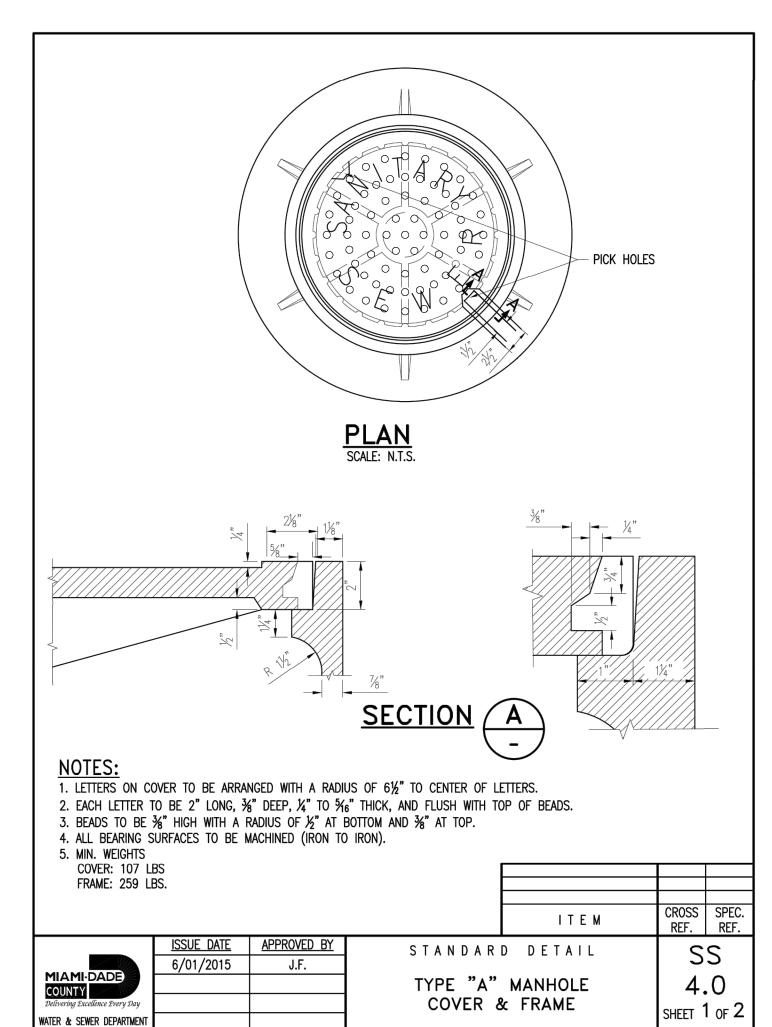

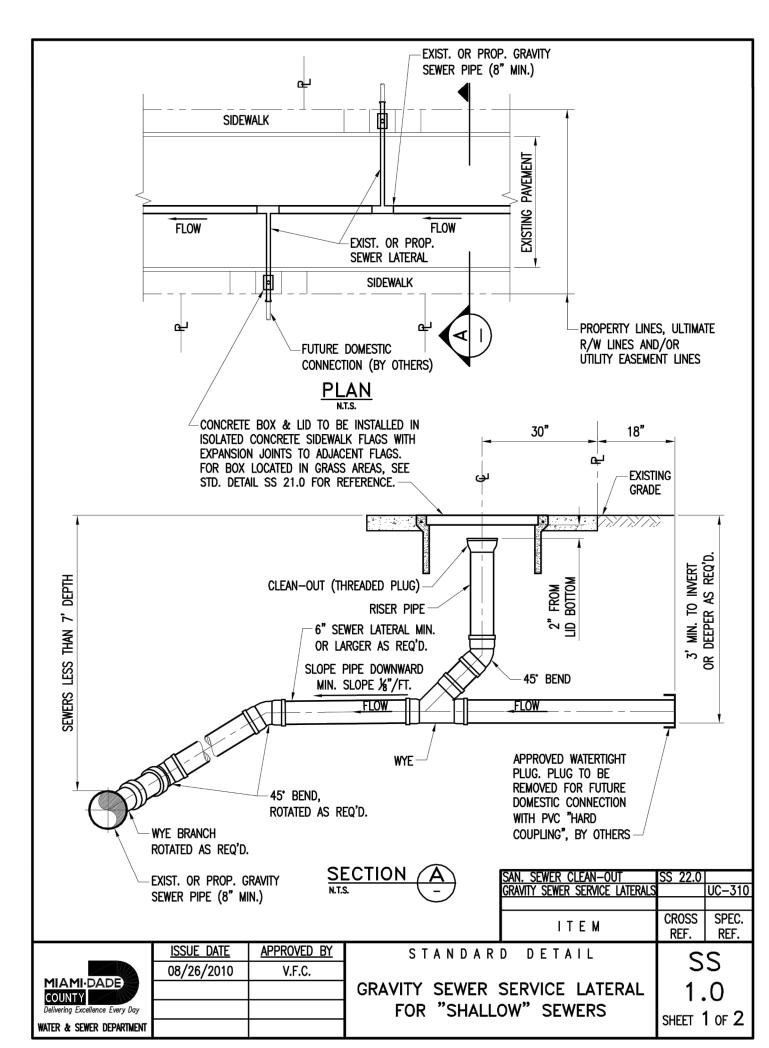

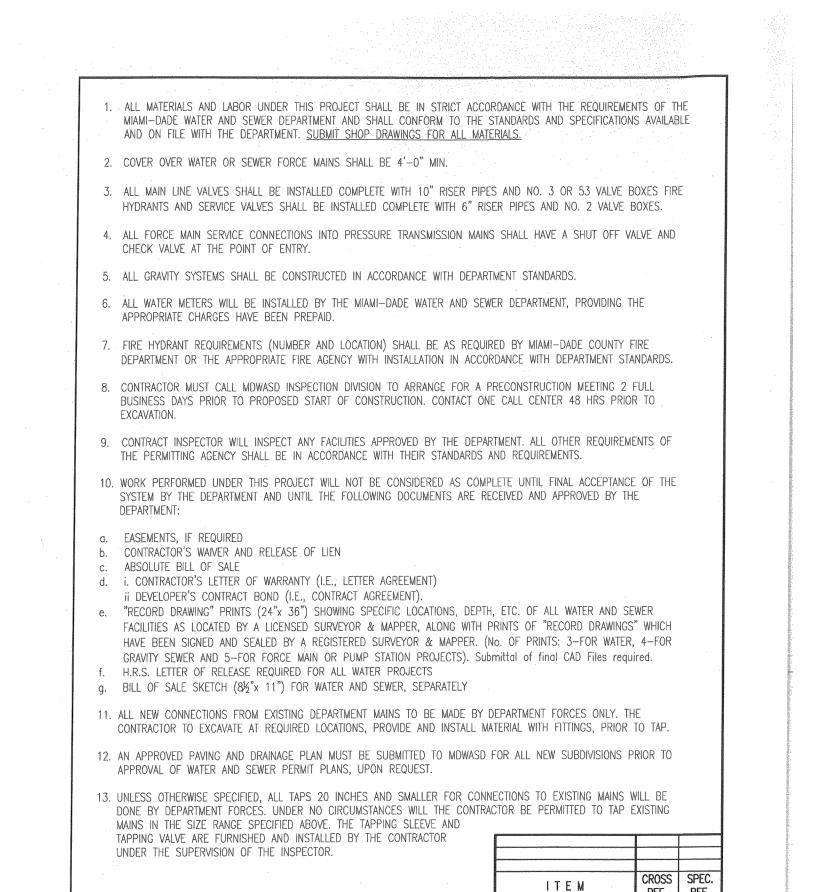

STANDARD DETAIL

STANDARD REQUIREMENTS

WATER AND SEWER

CONSTRUCTION


SHEET 1 OF 2

ISSUE DATE APPROVED BY

D.V.

03/01/2010 V.F.C.

07/20/2016

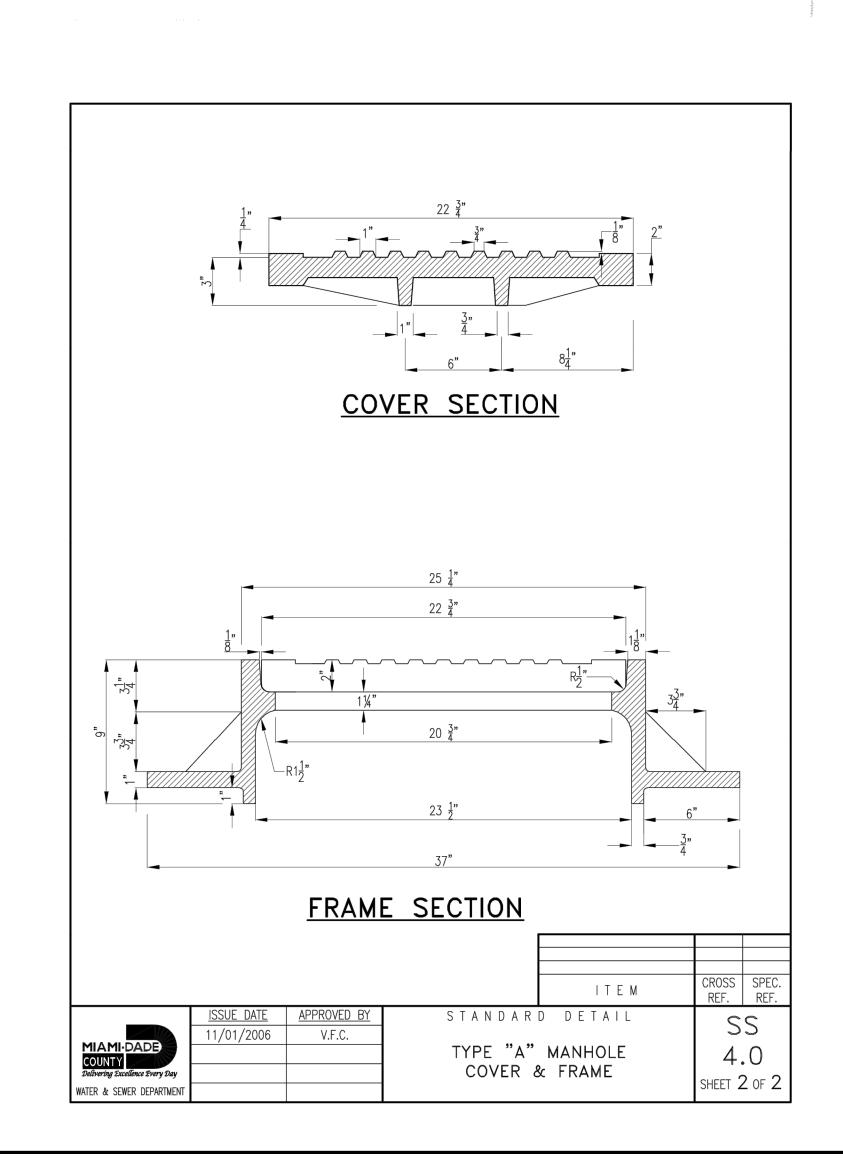



A DESCRIPTION DATE

X XX-XX-XX

TOYNO TO THE AVENUE


ENGINEER:

PENNONI ASSOCIATES

5755 Pio Vista Drive

AK

PENNONI ASSOCIATES INC.
5755 Rio Vista Drive
Clearwater, FL 8772
Florida COA: 7819

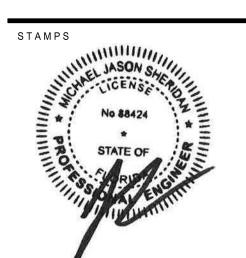



UTILITY DETAILS


DRVBR22027


SHEET NO

DATE 08-01-2022
SCALE AS NOTED
DRAWN JO
CHECKED JS

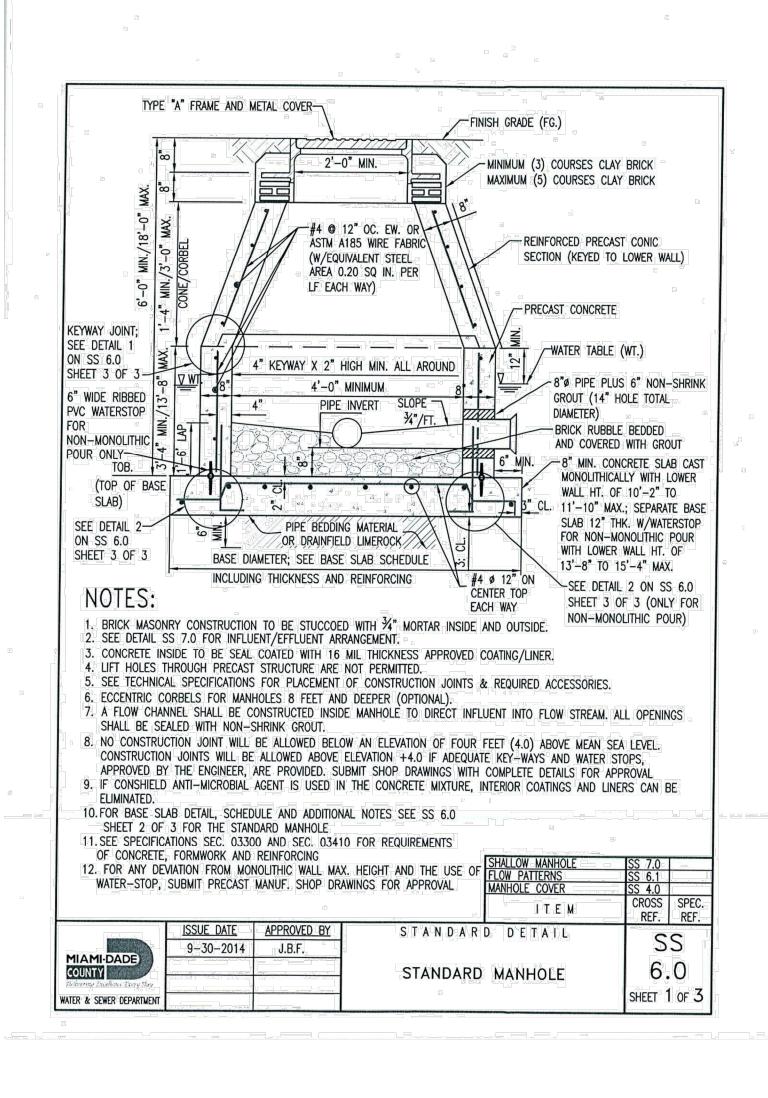


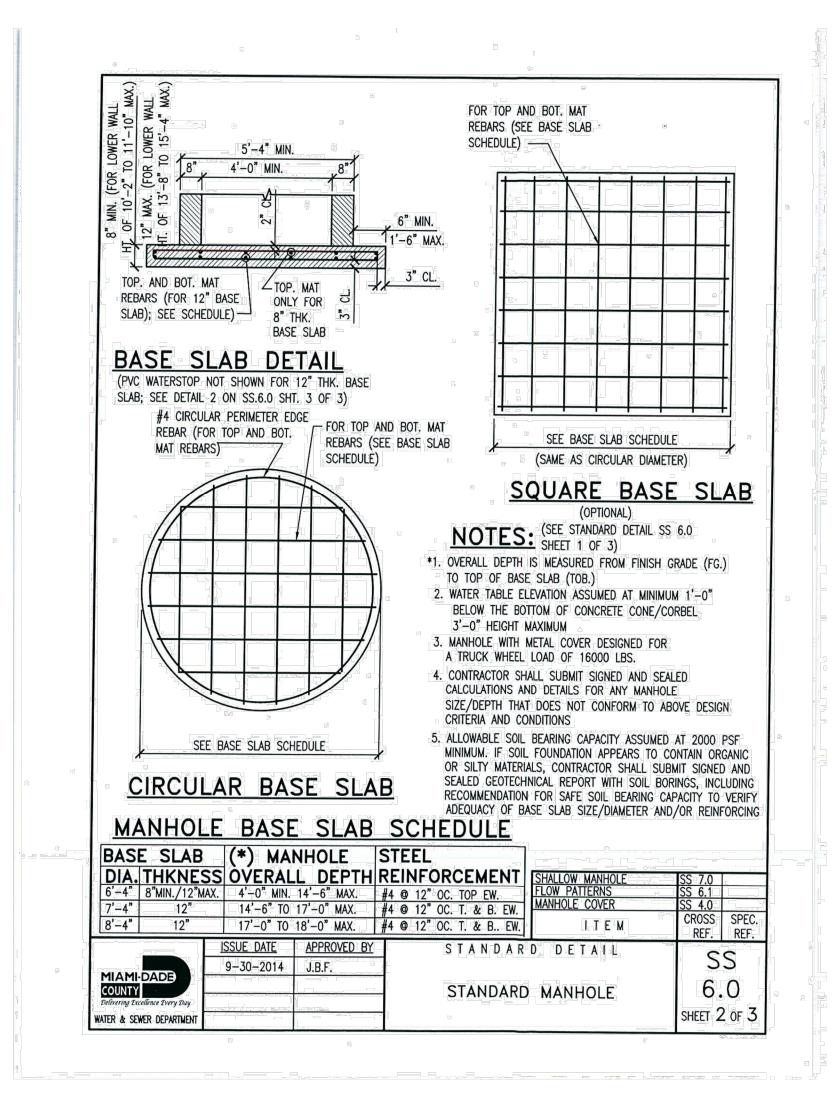


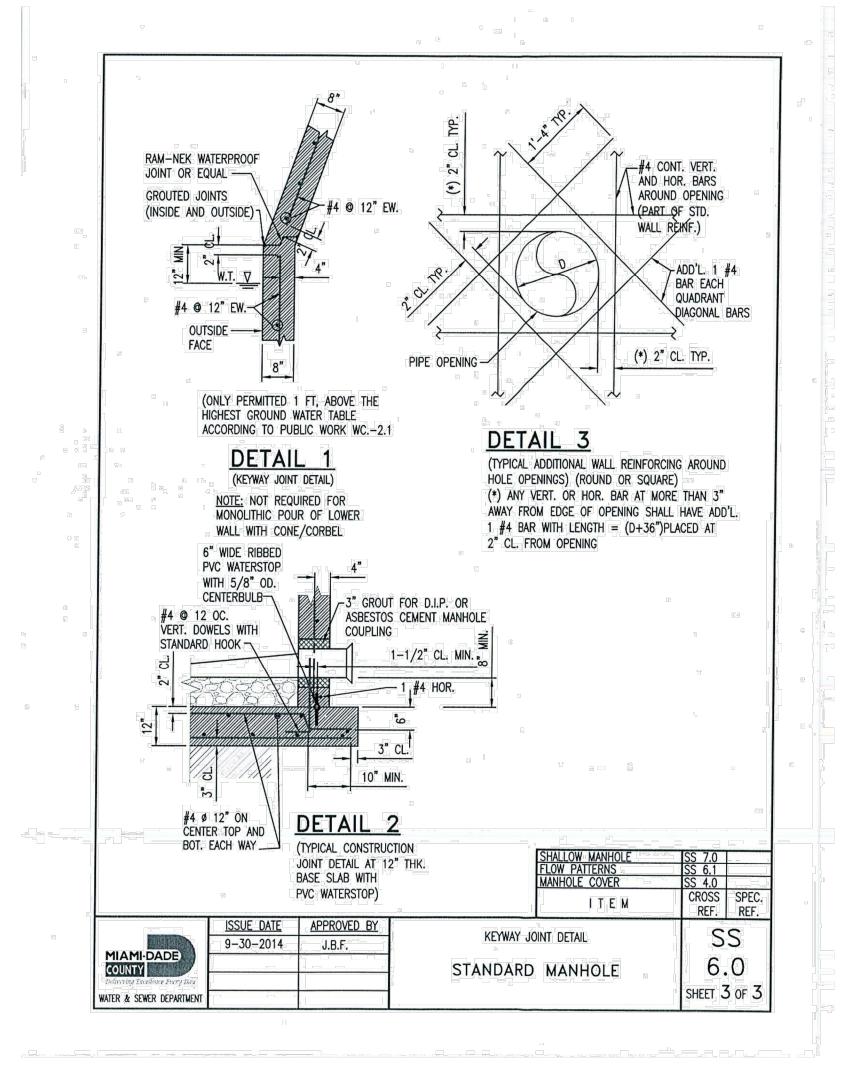

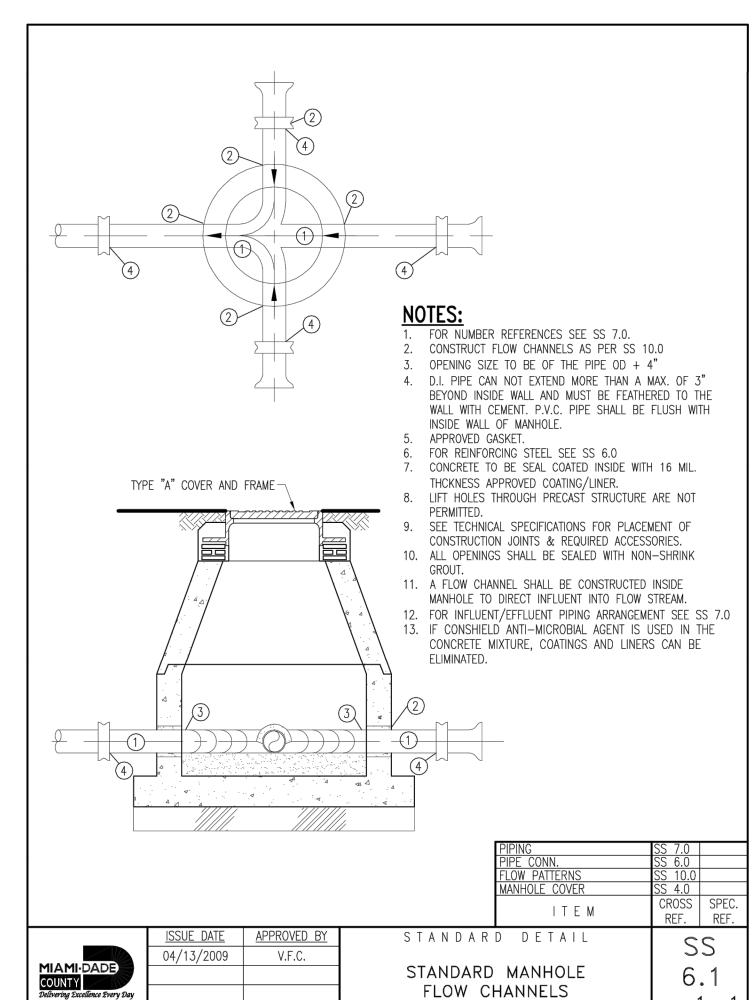

WATER & SEWER DEPARTMENT

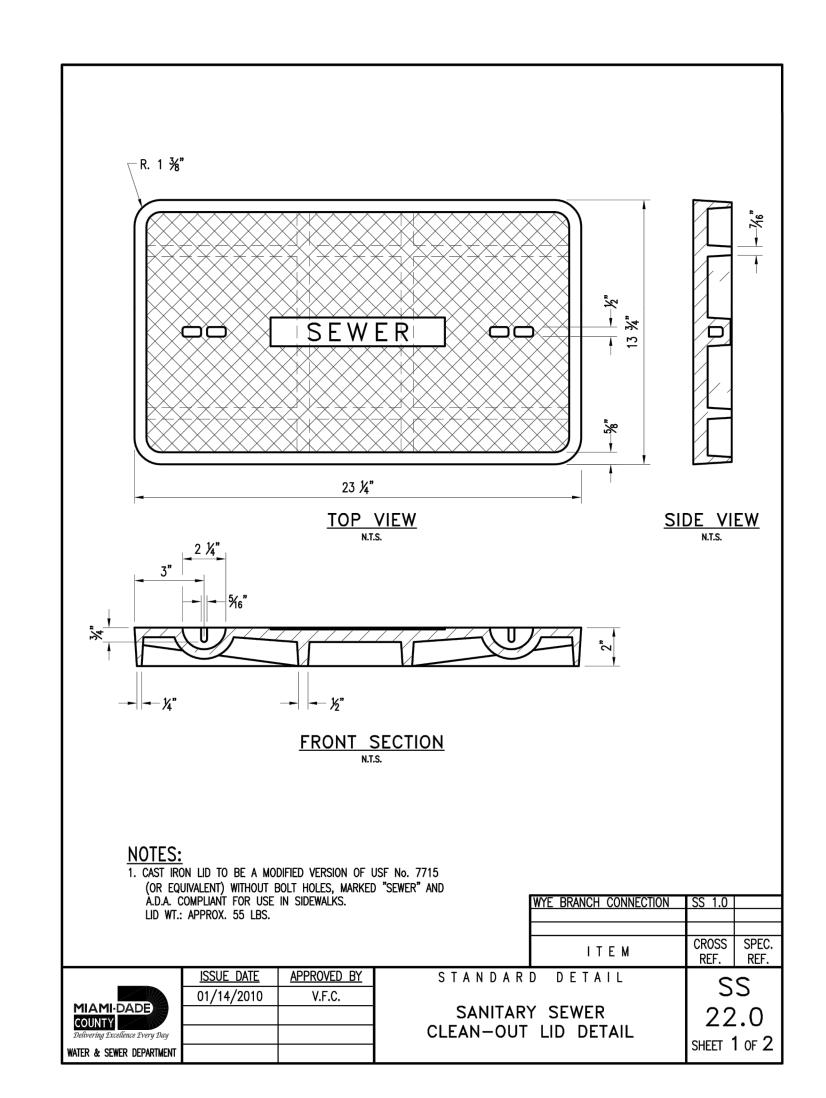

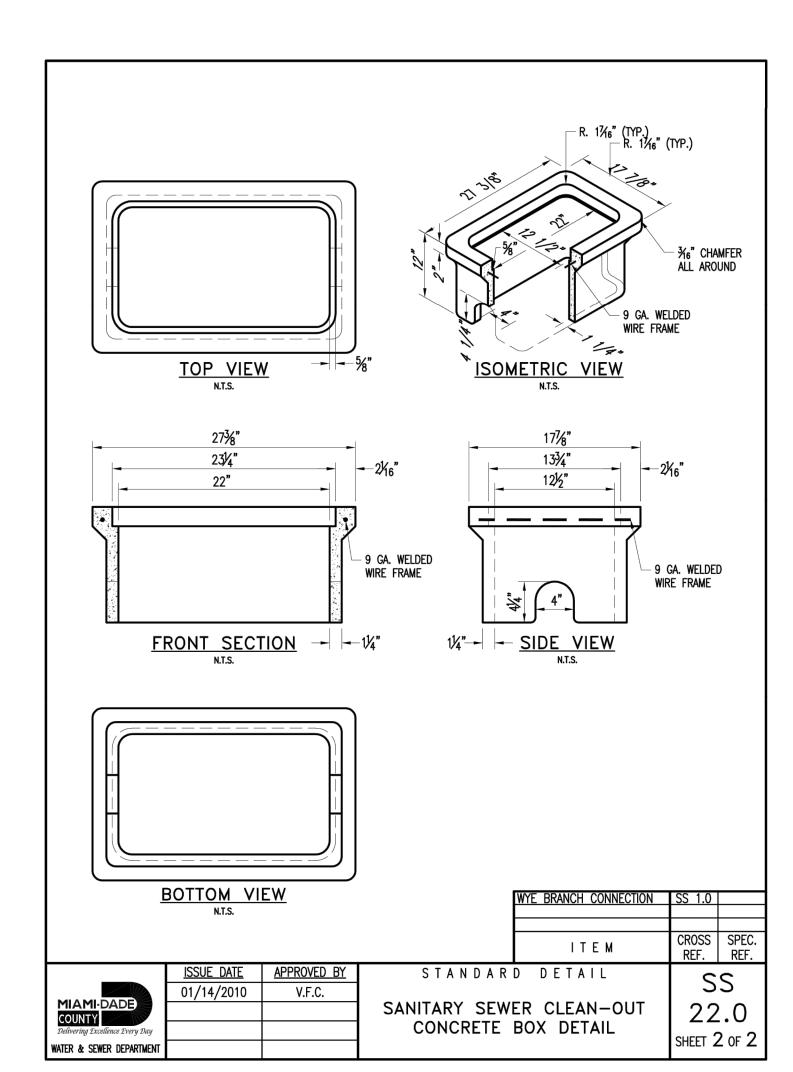



\$ | \$ | \$ | \$ | \$ | \$

ENGINEER:

AK


PENNONI ASSOCIATES INC. 5755 Rio Vista Drive Florida COA: 7819





**UTILITY DETAILS** 

PROJECT NUMBER **DRVBR22027** DATE

08-01-2022 AS NOTED SCALE DRAWN CHECKED SHEET NO

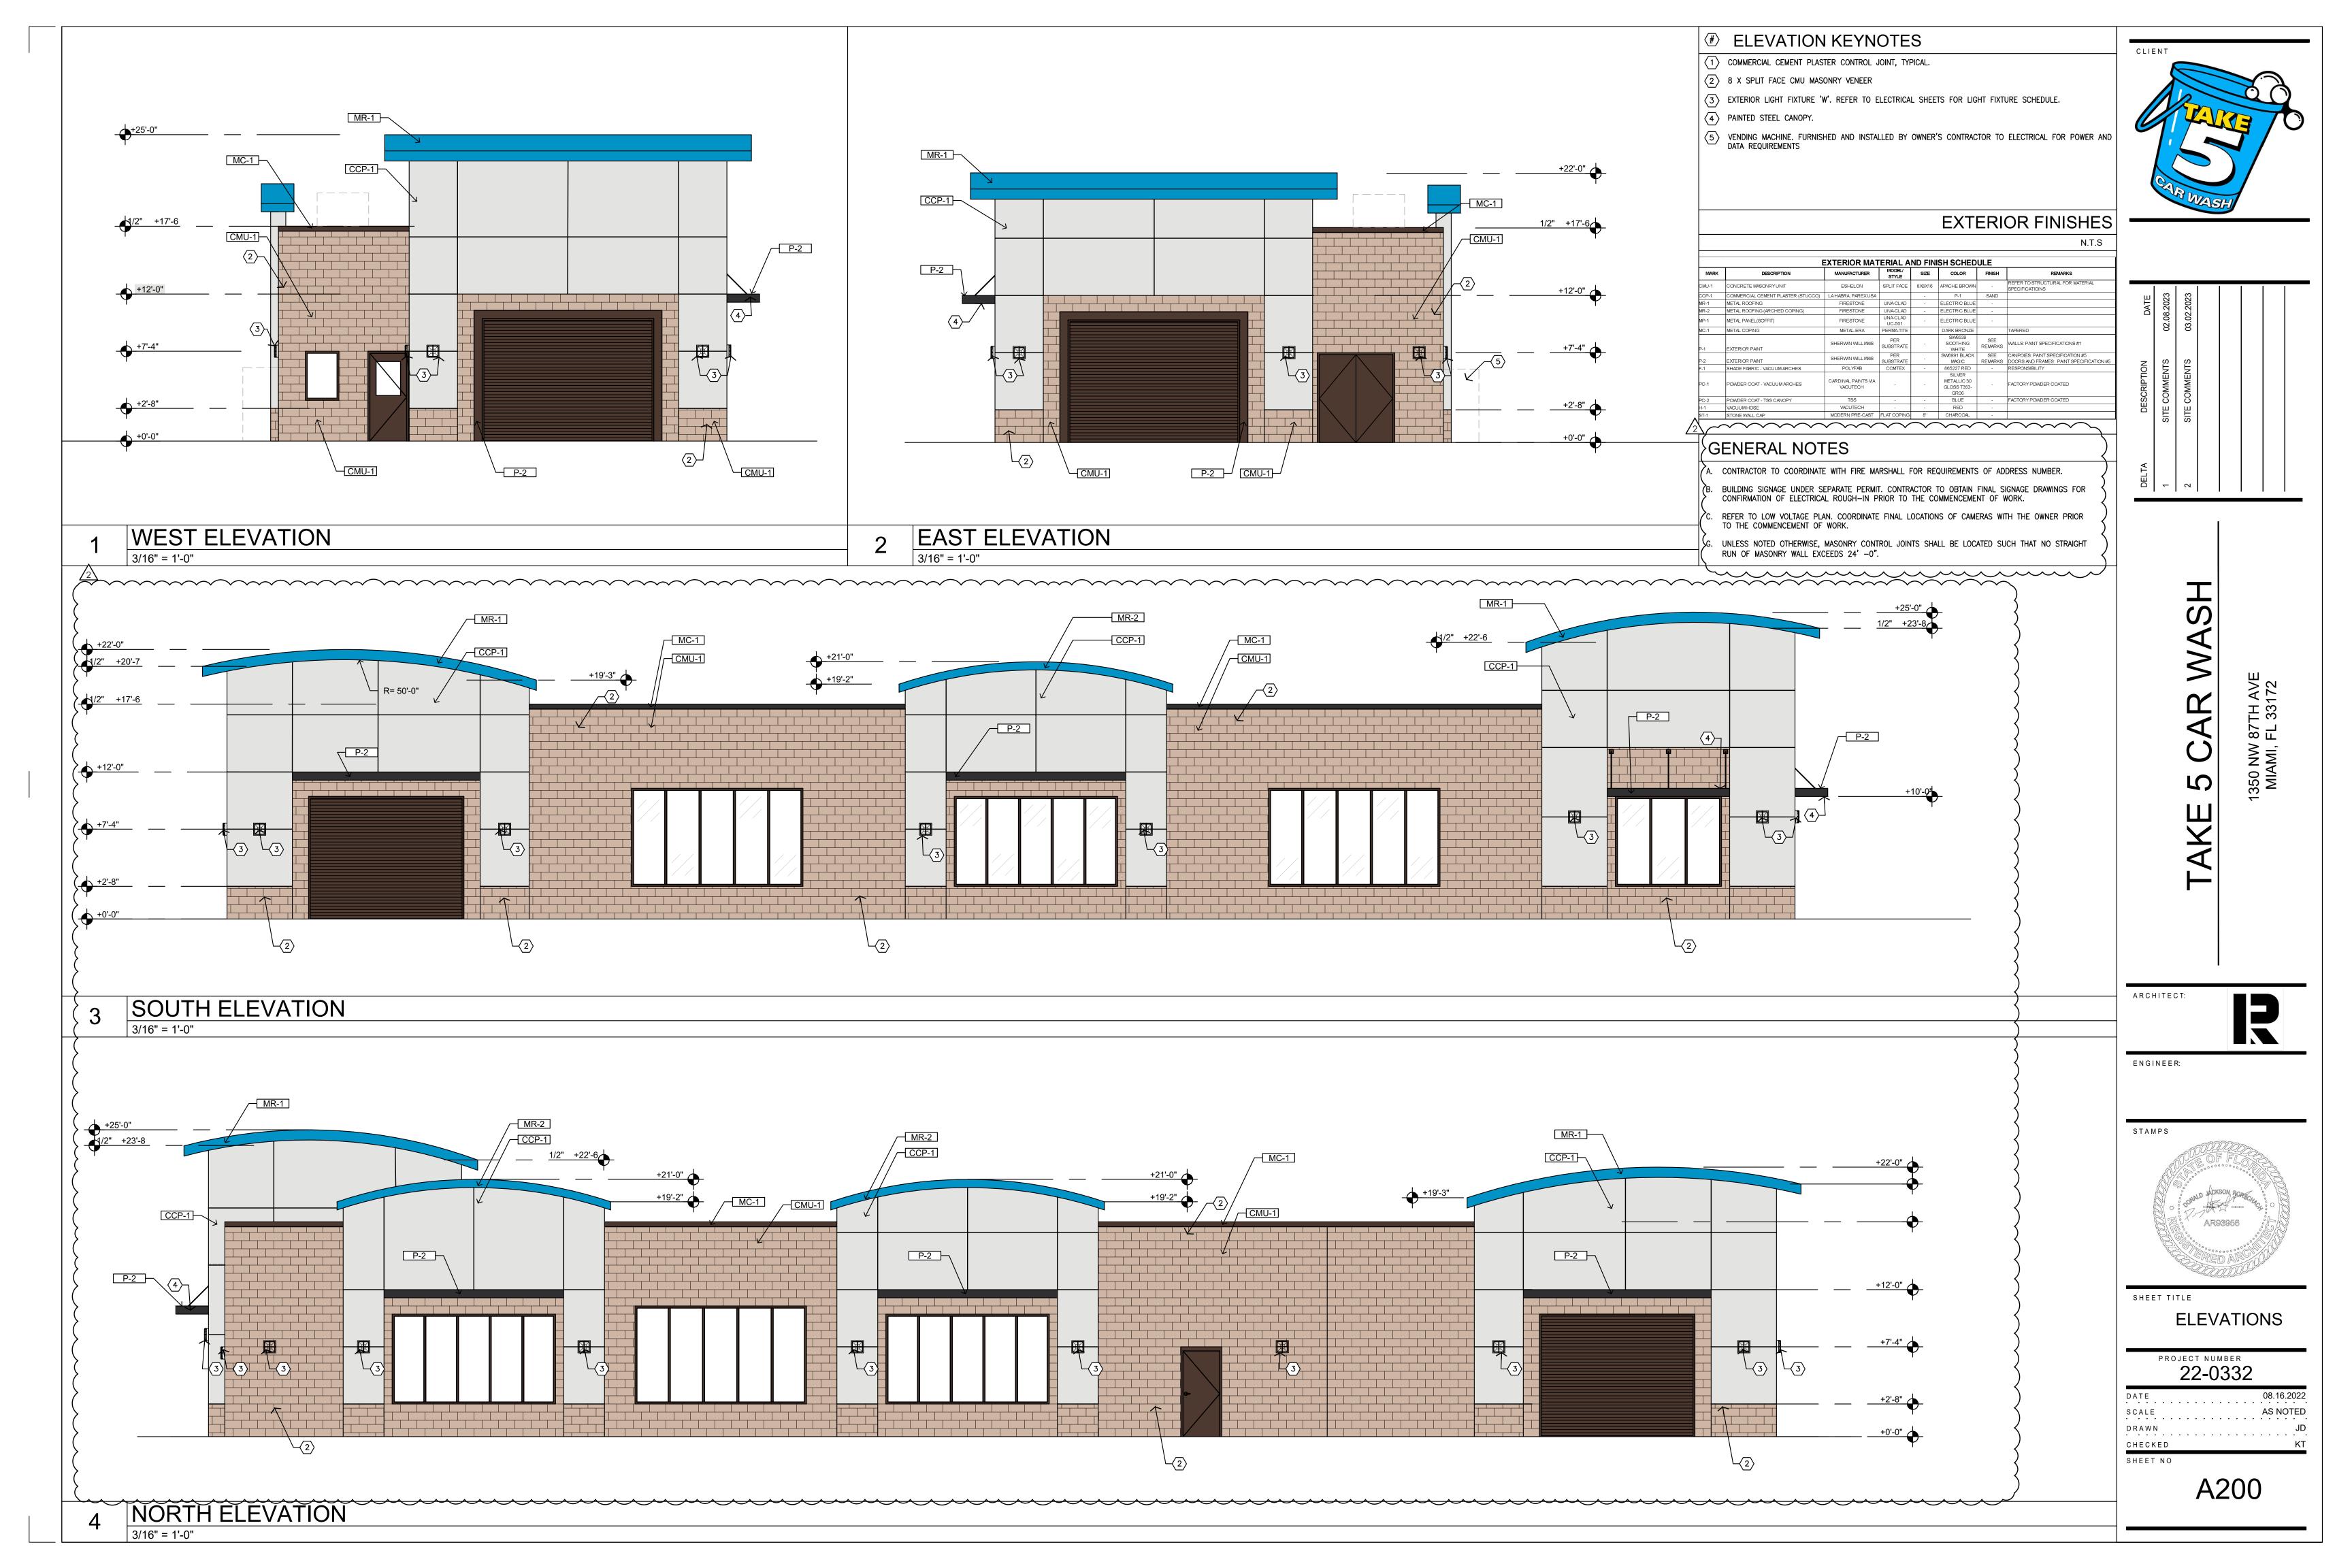

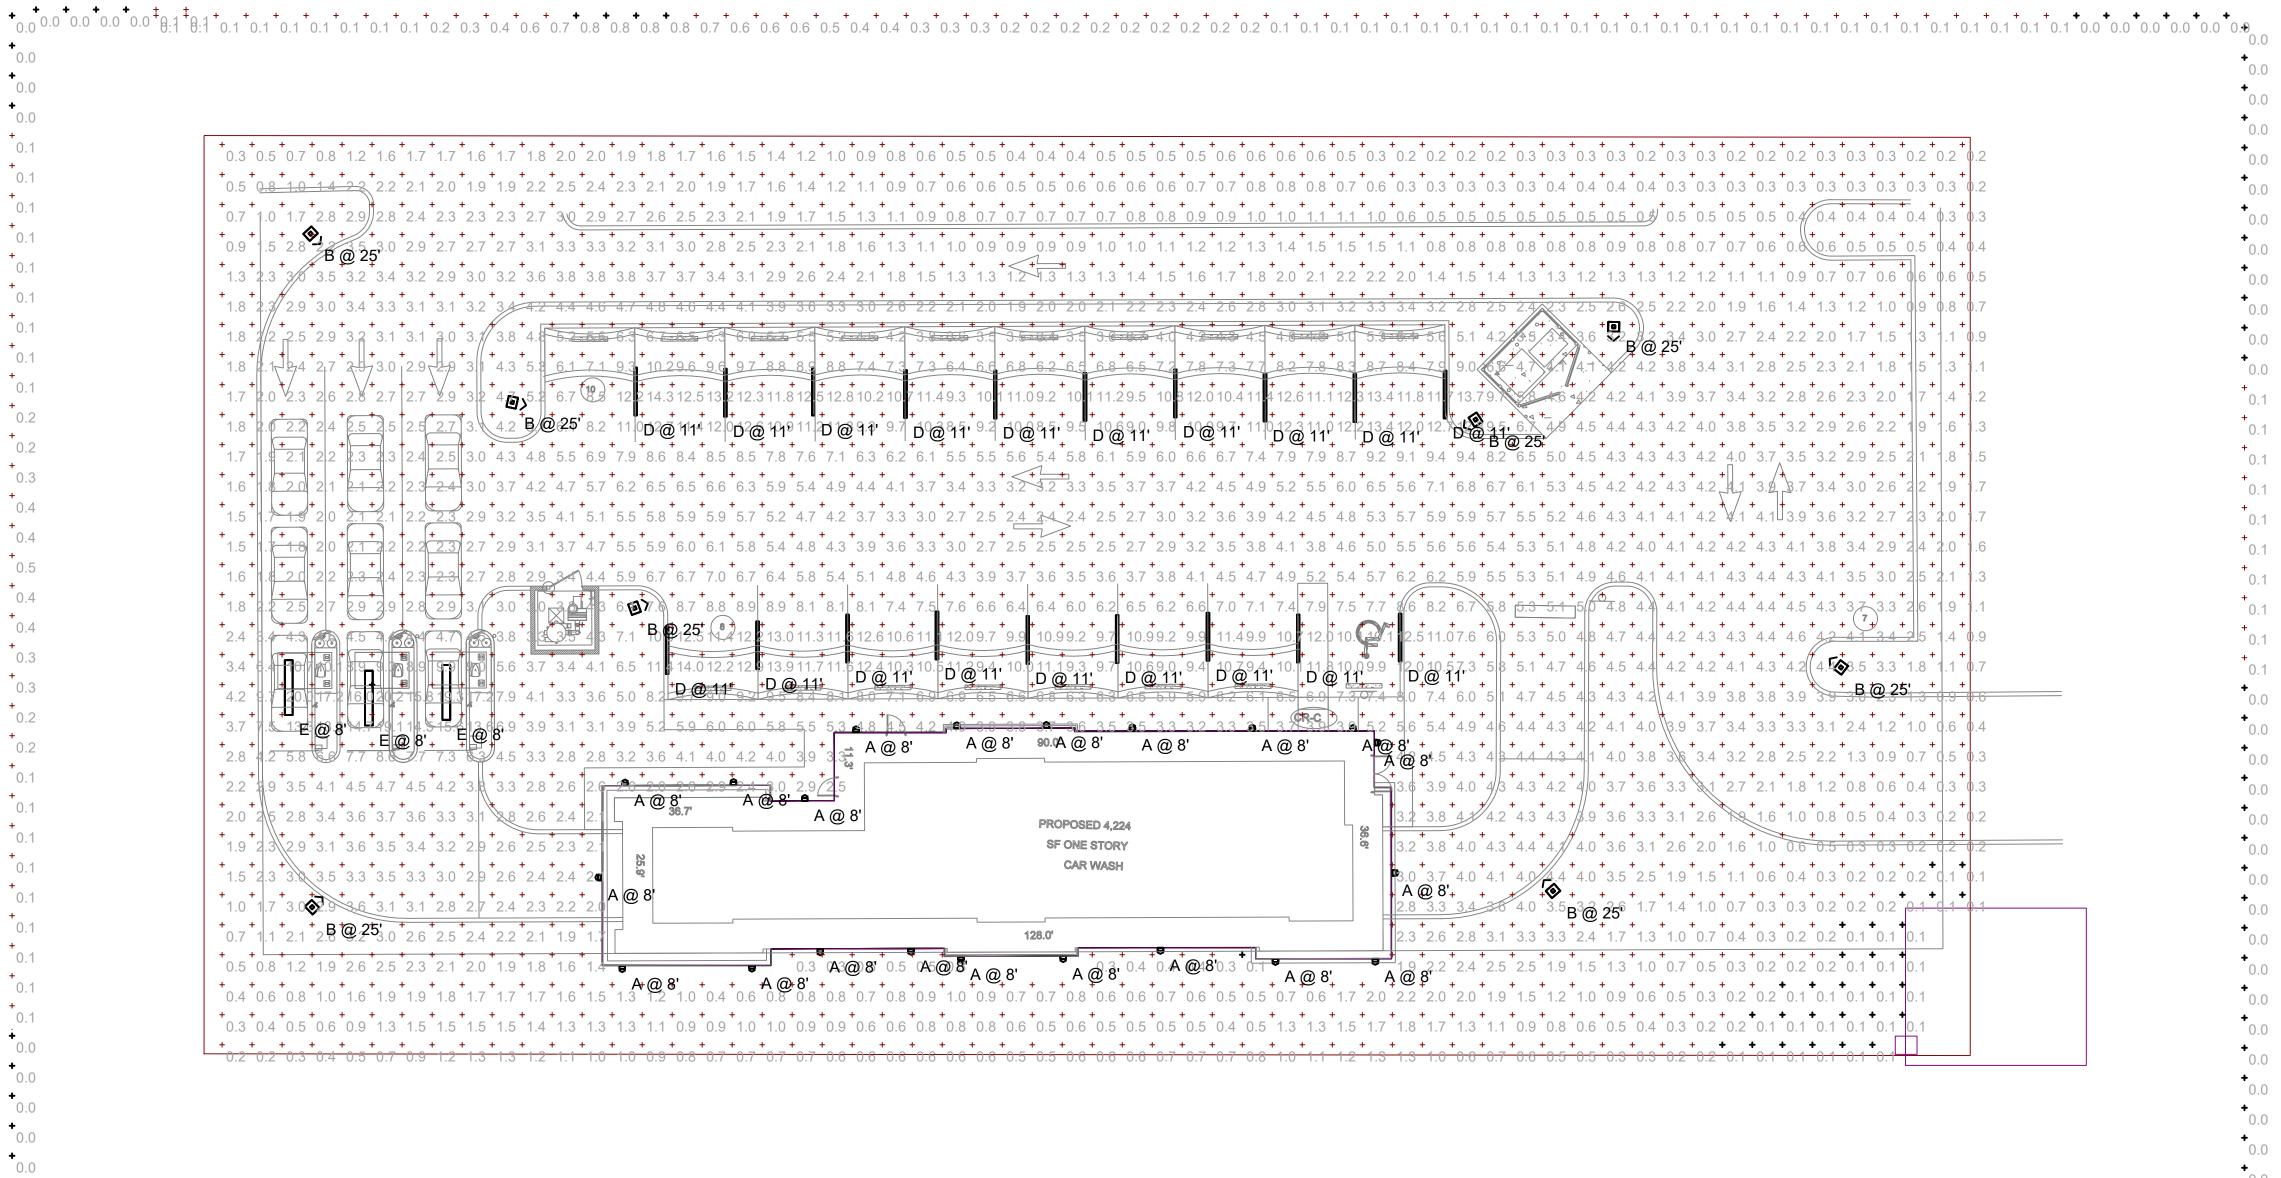

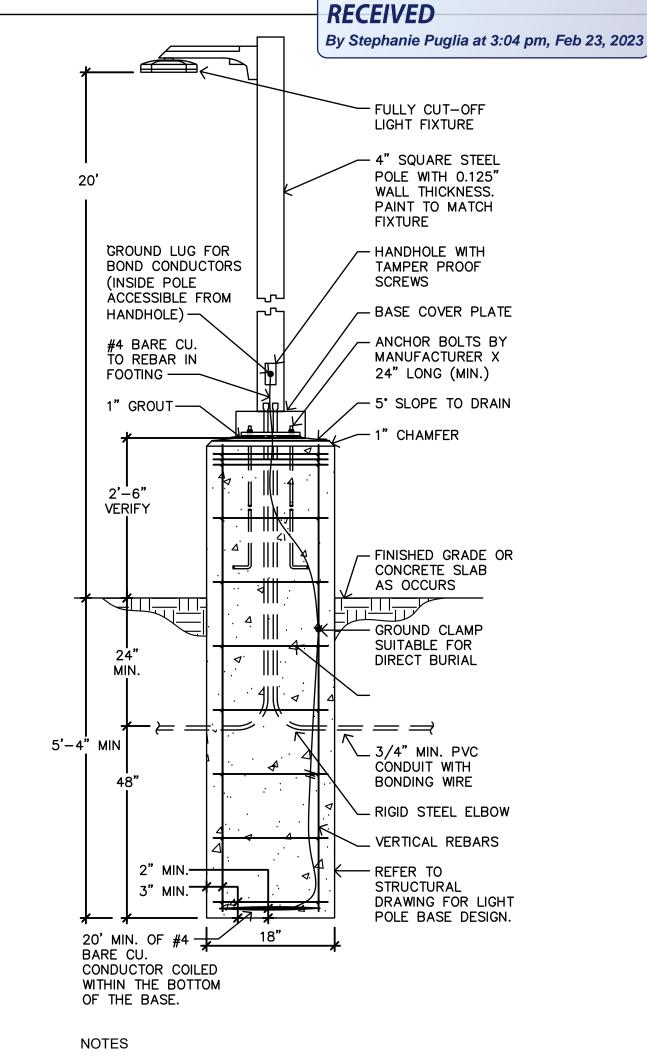

- 1. E.P.A. RATINGS SHALL BE COORDINATED WITH POLE AND FIXTURE ASSEMBLY.
- 2. GENERAL CONTRACTOR TO PROVIDE POLE BASE DESIGN SEALED BY PROFESSIONAL STRUCTURAL ENGINEER. REFER TO STRUCTURAL DRAWINGS S4.0 FOUNDATION DETAILS, 118 FOR LIGHT POLE FOOTING.
- 3. CONNECT TO REBAR WITH APPROVED LISTED GROUNDING CLAMPS USED FOR THIS PURPOSE.

POLE MOUNTING DETAIL - FIXTURE TYPE 'B"

Statistics						
Description	Symbol	Avg	Max	Min	Max/Min	Avg/Min
Calc Zone #2	+	0.1 fc	0.8 fc	0.0 fc	N/A	N/A
Calc Zone #1	+	3.7 fc	20.2 fc	0.1 fc	202.0:1	37.0:1

0.3

						Scale - 1" = 20	Schedule											
							Symbol	Label	Image	QTY	Manufacturer	Catalog	Description	Number Lamps	Lamp Output	LLF	Input Power	Polar Plot
Statistics				11						21	Healthcare Lighting	HPSC LED 30K MVOLT N80	HPSC LED WALL SCONCE w/ ETCHED OPAL ACRYLIC DIFFUSER	1	558	1	12	1/2
Description	Symbol	Avg	Max	Min	Max/Min	Avg/Min		A										06
Calc Zone #2	+	0.1 fc	0.8 fc	0.0 fc	N/A	N/A												
Calc Zone #1	+	3.7 fc	20.2 fc	0.1 fc	202.0:1	37.0:1												Max: 127cd
										8	Lithonia Lighting	DSX1 LED P5 40K T4M MVOLT HS	DSX1 LED P5 40K T4M MVOLT with houseside shield	1	12025	1	138	- 13
								_										
								В										
																		Max: 8096cd
										0	Lithonia Lighting	DSX1 LED P5 40K T5M MVOLT	DSX1 LED P5 40K T5M MVOLT	1	16435	1	138	1/3
												WVOLT						
								C										
																		-90.0
										19	Lithonia Lighting	CSS L48 ALO3 MVOLT	Contractor LED Single Strip Light, 48",	1	3174	1	24.26	Max: 6539cc
												SWW3 80CRI (3000LM 5000K)	Switchable lumens (3000LM / 4000LM /5000LM), 120-277V, Switchable White					
								D					(3500K, 4000K, 5000K), 80 CRI, Set to 3000LM 5000K					
												VAD 40001 M FOT MD	WARLER WERE CORNEL		0040		200	Max: 1064cd
										3	Lithonia Lighting	VAP 4000LM FST WD 50K 80CRI	VAP LED with BLT Gen 2 Boards	1	3919	1	32.9	18
								E										
							U											
																		Max: 1198cc
										0	Luminis Canada Inc.	SQ600-L1L15-R55	Syrios Square 6	1	1701	1	15.3	19
								F										



St. Louis, MO 63026 F 636.349.1730 CERTIFICATE OF AUTHORITY NO. 32860

CLIENT

DATE	01/24/2023			
DESCRIPTION	CITY COMMENTS			
DELTA	1			

ENGINEER:

STAMPS

SHEET TITLE

CHECKED

**PHOTOMETRIC** 

PROJECT NUMBER 22-0332

DATE SCALE DRAWN

SHEET NO

